


FILE NAME: Autodesk_Docs\RP22_BHC-Residential\21-2779-1 Bob Hope Center-Resi.rvt
DATE STAMP: 6/22/2023 2:32:20 PM

BOB HOPE CENTER - RESIDENTIAL

at

3201 W OLIVE AVE.
BURBANK, CA 91505

PLANNING DEVELOPMENT STANDARDS
RESUBMITTAL- 06.22.23

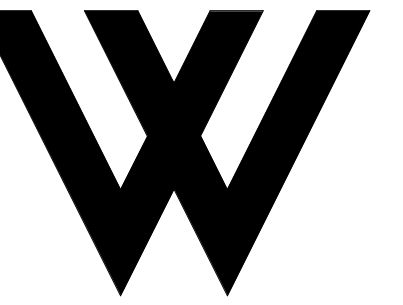

WOLCOTT
ARCHITECTURE
527 W. 11th St., Ste. 1304, Los Angeles, CA 90014
310.204.2290 | WWW.WOLCOTTAI.COM

CONSULTANT:

CERTIFICATION:

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FLOOR/LEVEL:

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PROJECT NO: 21-2779-1

DRAWN BY: RM CHECKED BY: SP

PROJECT MANAGER: CC

DRAWING SCALE:

SHEET SIZE: 30x42

DRAWING TITLE:


COVER SHEET

SHEET NO:


A000

ABBREVIATIONS			
# L C S @ &	POUND OR NUMBER ANGLE CENTERLINE DIAMETER AT AND PERPENDICULAR	JAN. J.T. LAM. LAV. LT.	JANITOR JOINT LAMINATE LAVATORY LIGHT
ACOUS. A.D.A. ADJ. A.F.F. AL. APPROX. ARCH. ARCHT. ANG.	ACOUSTICAL AMERICANS WITH DISABILITIES ACT ADJUSTABLE ABOVE FINISH FLOOR ALUMINUM APPROXIMATE ARCHITECTURAL ARCHITECT AVERAGE NATURAL GRADE	M.C. MAX. MECH. MET. MFR. MIN. MSC. MTD. MUL.	MINERAL CORE MATERIAL MAXIMUM MECHANICAL META MANUFACTURER MINIMUM MISCELLANEOUS MOUNTED MULLION
B.D. BLDG. B.O. BOT.	BOARD BUILDING BLOCKING BOTTOM OF BOTTOM	N NA N.I.C. NO NOMINAL N.T.S.	NEW TO MATCH EXISTING NOT APPLICABLE NOT IN CONTRACT NUMBER NOMINAL NOT TO SCALE
CAB. C.B.C. CER. C.L. CL. OPG. CLNG. CLKG. C.O. CLR. CNTR. COL. CONST. CONT. CONTR. CORR. CTR.	CABINET CALIFORNIA BUILDING CODE CERAMIC CLEAR OPENING CEILING CAULKING CLOSET CLEAR CENTER COLUMN CONSTRUCTION CONTINUOUS CONTRACTOR CORRIDOR CENTER	O.A. O.C. O.D. OFF. OPNG. OPP. PL. P.LAM. PLAS. PLY. P.O. PR. PT. P.T.M. PTD. PTNL.	OVER ALL ON CENTER OUTSIDE DIAMETER OFFICE OPENING OPPOSITE PLATE PLASTIC LAMINATE PLASTIC PLYWOOD PRIVATE OFFICE PAIR PAINT PAINT TO MATCH PAINTED PARTITION
D. DBL. DEPT. DET. DIA. DIM. DISP. DN. D.O. DR. DWG. DWR.	DEMOLISH DOUBLE DEPARTMENT DETAIL DIAMETER DIMENSION DISPENSER DOWN DOOR OPENING DOOR DRAWING DRAWER	Q.T. R RAD. REF. REFL. REFR. REQ. RESIL. RM. R.O.	QUARRY TILE RELOCATE EXISTING OR SALVAGE FOR RELOCATION RADIUS REFERENCE REFLECTED REFRIGERATOR REQUIRED RESILIENT ROOM ROUGH OPENING
(E) EL. ELEV. ELEV. ELCL. EQ. EQUIP. EXIST. EXT.	EXISTING TO REMAIN EACH ELEVATION ELECTRICAL ELEVATION ENCLOSURE EQUAL EQUIPMENT EXISTING EXTERIOR	S.C. SCH. SECT. SHT. SIN. S.M. SPEC. SQ. SS. STA. STD. STL. STOR. SUSP. S.F.	SOLID CORE SCHEDULE SECTION SHEET SIMILAR SURFACE MOUNTED SPECIFICATION SQUARE STAINLESS STEEL STATION STANDARD STEEL STORAGE SUSPENDED SQUARE FEET
F.F.E. F.E. F.E.C. F.H. F.H.C. FIN. FL. F.L.G. F.O.F. F.O.S. FIRE. F.R.T. FT. FURR. FUT.	FINISH FLOOR ELEVATION FIRE EXTINGUISHER FIRE EXTINGUISHER CABINET FIRE HOSE FIRE HOSE CABINET FINISH FLOOR FLOORING FACE OF FINISH FACE OF STUDS FIRE PROOF FIRE RETARDANT TREATED FOOT OR FEET FURRING FUTURE	TAMGD T.B.D. TEL. TER. THK. THK. TOP OF TOP OF PARAPET TOP OF LO T.V. TYP.	TONGUE AND GROOVE TO BE DETERMINED TELEPHONE TERRAZZO THICK THICK TOP OF TOP OF PARAPET TOP OF LO TELEVISION TYPICAL
GA. GALV. SC. G.D. GL. GYP. GYP. BD.	GALVANIZED GENERAL CONTRACTOR GARAGE DISPOSAL GLASS OR GLAZING GYPSUM GYPSUM BOARD	U.B.C. UNF. U.O.N.	UNIFORM BUILDING CODE UNFINISHED UNLESS OTHERWISE NOTED
H.C. H.D. HWD. HWR. HST. H.M. HORZ. HR. HVAC	HOLLOW CORE HEAD HARDWOOD HARDWARE HEIGHT HOLLOW METAL HORIZONTAL HOUR HEATING, VENTILATION AND AIR CONDITIONING	V. VERT. VEST. V.I.F. V.T. W/ WD. WH. W.A. W/O WP. WSCT. WST.	VOLT VERTICAL VESTIBULE VERY IN FIELD VINYL TILE WITH WOOD WATER HEATER WOLCOTT ARCHITECTURE WITHOUT WATERPROOF WAINSCOT WORKSTATION WEIGHT
I.D. INF. INSUL. INT. I.T.	INSIDE DIAMETER INFORMATION INSULATION INTERIOR INFORMATION TECHNOLOGY		

SATELLITE MAP

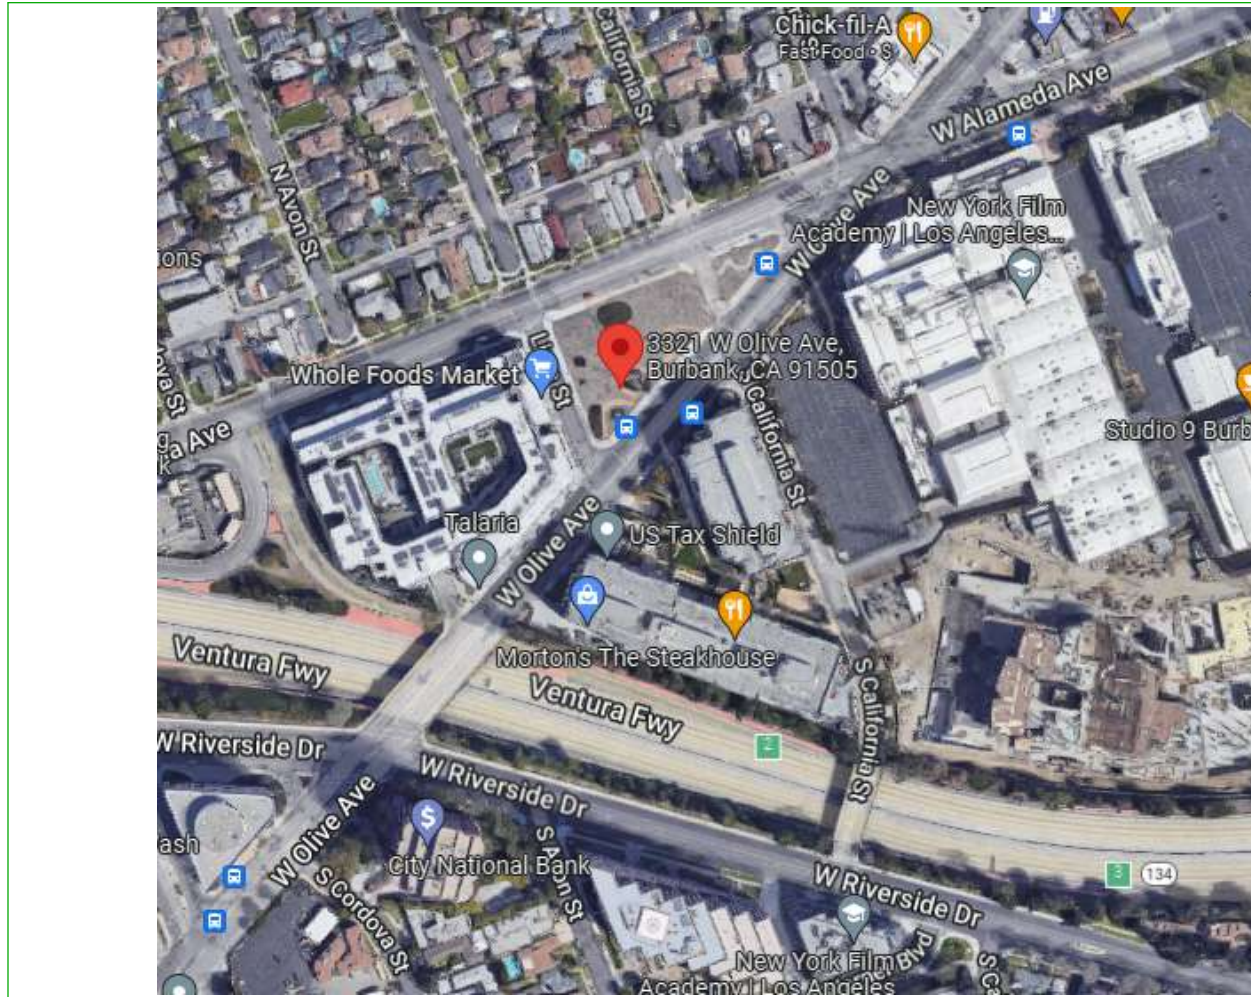

VICINITY MAP

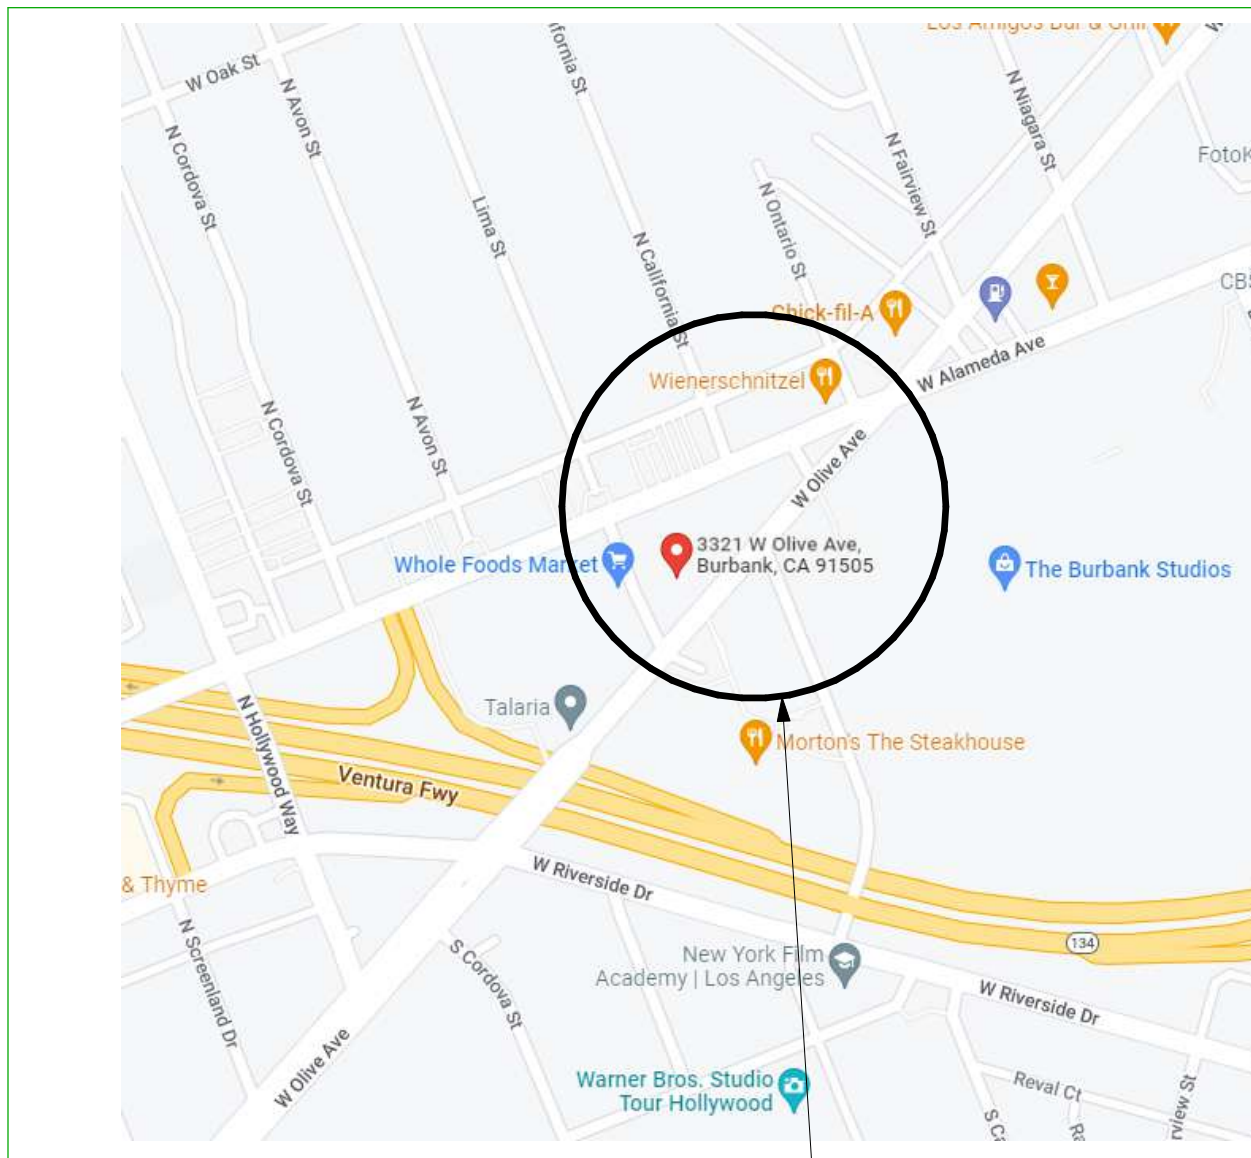

GRAPHIC SYMBOLS

	BUILDING STRUCTURAL GRID LINES
	DETAIL NUMBER SHEET NUMBER
	SECTION NUMBER SHEET NUMBER
	SINGLE ELEVATION IDENTIFICATION: ELEVATION NUMBER SHEET NUMBER
	INTERIOR ELEVATION IDENTIFICATION: ELEVATION NUMBER
	SHEET NUMBER
	BULLETIN (OR AMENDUM): AREA OF REVISION REVISION NUMBER
	FINISH FLOOR ELEVATION SYMBOL F.F.E.
	ROOM NAME ROOM NUMBER
	STAIR/RAMP DIRECTION: ARROW POINTS UP #% SLOPE
	ALIGN
	PLAN NORTH REFERENCE
	KEYNOTE SYMBOL
	DOOR NUMBER
	WALL SYMBOL TYPE
	*NOT IN CONTRACT: NO WORK IN THIS AREA
	EXISTING TO REMAIN
	NEW
	DEMO
	RELOCATE EXISTING/SALVAGE FOR RELOCATION (AT DEMO PLAN)

PROJECT TEAM

ARCHITECT: WOLCOTT ARCHITECTURE 1708 N. ALEXANDRIA AVE LOS ANGELES, CA 90027 PHONE: 310.204.2290 EMAIL: SPADDOCK@WOLCOTTAL.COM CONTACT: STEPHEN PADDOCK SECONDARY: ROBBIE MEHRING EMAIL: RMHEHRING@WOLCOTTAL.COM	CLIENT: WORTHE REAL ESTATE GROUP 100 WILSHIRE BLVD SUITE 2100 SANTA MONICA, CA 90401 PHONE: 310.393.9653 EMAIL: JADENR@WORTHE.COM CONTACT: JADEN ROBBINS
---	---

CIVIL: PSOMAS 555 FLOWER ST. SUITE 4300 PHONE: 661.705.4410 EMAIL: JEREMY.JOHNSON@PSOMAS.COM CONTACT: JEREMY JOHNSON

LANDSCAPE: GLLS STUDIO LOS ANGELES, CA PHONE: 310.625.2029 EMAIL: EGIBSON@GLLBSTUDIO.COM CONTACT: ERIC GIBSON

PROJECT DESCRTPTION

SCOPE OF WORK: LOCATED AT 3201 W. OLIVE AVE., ALSO KNOWN AS THE BOB HOPE SITE, THE PROJECT CONSISTS OF A NEW CONTEMPORARY STYLE MULTI-STORY RESIDENTIAL APARTMENT BUILDING OF 117 LIVING UNITS, INCLUDING POOL AND GYM AMENITIES, TO BE BUILT ON A VACANT LOT. THE LIVING UNITS WILL BE A MIX OF STUDIO, 1-BEDROOM AND 2-BEDROOM UNITS WITH BALCONIES.
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SHEET INDEX

DRAWING NUMBER	DRAWING TITLE	PLANNING DEV. STANDARDS	SCHEMATIC DESIGN	DESIGN DEVELOPMENT	CONSTRUCTION DOCUMENTS
ARCHITECTURAL					
A000	COVER SHEET	•			
A001	PROJECT DATA	•			
A002	PROJECT REVISIONS	•			
ARCHITECTURAL					
A111	AVERAGE SETBACK DIAGRAM - 2ND FLOOR	•			
CIVIL					
C000	CIVIL DRAWING PACKAGE	•			
ARCHITECTURAL					
A110	SITE PLAN - PROPOSED	•			
A200	FLOOR PLAN - 1ST FLOOR	•			
A201	FLOOR PLAN - 2ND-4TH FLOOR	•			
A203	ROOF PLAN	•			
A204	FLOOR PLAN - P-1	•			
A205	FLOOR PLAN - P-2	•			
A300	EXTERIOR ELEVATIONS	•			
A301	ENLARGED EXTERIOR ELEVATIONS	•			
A302	ENLARGED EXTERIOR ELEVATIONS	•			
A303	ENLARGED EXTERIOR ELEVATIONS	•			
A400	BUILDING SECTIONS	•			
A410	ENLARGED SECTIONS	•			
A600	ENLARGED PLANS - TYP. UNITS	•			
A601	ENLARGED PLAN 1ST FLOOR - AREA A	•			
A602	ENLARGED PLAN 1ST FLOOR - AREA B	•			
A603	ENLARGED PLAN 2ND FLOOR - AREA A	•			
A604	ENLARGED PLAN 2ND FLOOR - AREA B	•			
A710	SCHEDULE - FINISH AND FIXTURE	•			
A900	SITE CONTEXT PHOTOS	•			
A901	VIEWS AND IMAGES	•			
LANDSCAPE					
L1.0	OVERALL LANDSCAPE CONCEPT PLAN	•			
L1.1	HARDSCAPE CONCEPT PLAN	•			
L1.2	LANDSCAPE ELEVATIONS	•			
L1.3	CONCEPTUAL PLANTING PLAN	•			
L1.4	PLANT IMAGES	•			
L1.5	PLANT IMAGES	•			

BURBANK PLANNING TABULATIONS

DEVELOPMENT AGREEMENT (INCLUDES DENSITY BONUS, CONCESSIONS, INCENTIVES & WAIVERS PER SB 35)		LOT COVERAGE: (INCLUDES GARAGE RAMP AREA)	ALLOWABLE 35,037 SF (60%)	PROPOSED 29,424 SF
STATE DENSITY BONUS (SDB) WE ARE REQUESTING A 50% DENSITY BONUS AND WILL ALLOCATE 15% OF OUR BASE PROJECT'S UNITS TO VERY LOW INCOME TENANTS. SATISFY'S BURBANK'S INCLUSIONARY HOUSING REQ. OF 15% OF BASE PROJECT FOR AFFORDABLE HOUSING.		FLOOR AREA RATIO (USING NET LOT AREA AND LIMITED TO COMMERCIAL - ANGLUARY FOOTING, EXCLUDING RESIDENTIAL AREA)	ALLOWABLE 1.1 FAR (58,395 SF * 1.1 = 64,234 SF)	PROPOSED 0.02 FAR (1,058 SF RETAIL / 58,395 SF)
LOT AREA GROSS LOT AREA: (FOR PURPOSE OF CALCULATING DWELLING UNIT COUNT)	71,829 SF (1.649 ACRES)	TOTAL BUILDING AREA (EXCLUDES SHAFTS & STAIRS)	PROPOSED 1,058 SF 130,666 SF	
NET LOT AREA: (INCLUDES CALIFORNIA ST. AND EASEMENT FOR PURPOSES OF CALCULATING FAR)	58,395 SF (1.34 ACRES)	UNIT COUNT:		
RETAIL AREA EXISTING PD 2001-2 LAND AREA PD 2001-2 RESIDENTIAL DENSITY	1,058 SF 1.65 ACRES (71,829 SF) 58 DU/ACRE			
BASE DENSITY ALLOWED BASE DENSITY ALLOWED, ROUNDED UP PER SDB 65915(Q) BASE PROJECT PROPOSED	77.72 DU 78 DU 78 DU			
% AFFORDABLE (VERY LOW) AFFORDABLE UNITS AFFORDABLE UNITS, ROUNDED UP PER SDB 65915(Q)	15% 11.7 DU 12 DU			
STATE DENSITY BONUS (50% ROUNDED UP) TOTAL RESIDENTIAL DENSITY	39 DU 117 DU			
APPLICABLE ADDRESSES:	3201 W. OLIVE AVE, BURBANK, CA 91505 3004 W. OLIVE AVE, BURBANK, CA 91505 3305 W. OLIVE AVE, BURBANK, CA 91505 3311 W. OLIVE AVE, BURBANK, CA 91505 3321 W. OLIVE AVE, BURBANK, CA 91505 (3 PARCELS ON PROPOSED SITE LISTED AS "NO ADD.")			
ASSESSOR'S PARCEL #(S):	2484-024-401, 2483-023-419, 2483-023-420, 2483-023-421, 2483-023-422, 2483-023-431, 2483-023-432			
TRACT:	10135 MB 141-21-22			
MAP REFERENCE:	MR 43 - 47 - 99			
ZONE:	MEDIA DISTRICT COMMERCIAL (MDC-2) DEVELOPMENT STANDARDS BASED ON MDC-2 ARTICLE 21 10-1-2101 (MDM-1)			
ZONING SETBACKS RESIDENTIAL (NOT A RESIDENTIAL ZONE - NONE REQ'D.)	REQUIRED PROPOSED			
COMMERCIAL PER MEDIA DISTRICT PLAN: MIN 5'	5' - 0"	5' - 0"	(APPLIES TO SINGLE STORY RETAIL BUILDING)	
PORTION OF BUILDING TALLER THAN 15' IN HT. MUST HAVE AN AVG. SETBACK OF 20% FROM STREET RIGHT-OF-WAY (PROP. LINE)	8' - 11" (44' - 8" BLDG HT X 0.2)	10' - 0" AVG. BLDG. ENVELOPE 8' - 0" AVG. OVERHANG / PROJECTION		
FENCE, WALL, HEDGE HEIGHTS WITHIN SETBACKS FENCE AND WALL HEDGE OUTSIDE OF SETBACKS FENCE AND WALL HEDGE	ALLOWABLE 4' - 0" 6' - 0" 8' - 0" 12' - 0"	PROPOSED 3' - 0" MAX. 6' - 0" MAX. 8' - 0" MAX. 6' - 0" MAX.		
BUILDING HEIGHT (MEASURED FROM AVG. NATURAL GRADE TO CEILING HEIGHT OF THE HIGHEST ROOM OF OCCUPANCY)	ALLOWABLE 50' 70'	ACTUAL 44' - 6" 44' - 6"		
DISTANCE FROM R-1, R-2 LOT LINE 150' - 300' 300' - 500'				
# OF STORIES:	2	4		



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DRAWN BY: RM CHECKED BY: SP

PROJECT MANAGER: CC

DRAWING SCALE: As indicated

SHEET SIZE: 30x42

DRAWING TITLE:

PROJECT DATA

SHEET NO:

A001

PROJECT REVISION

REVISION #02: PLANNING AND DEVELOPMENT STANDARDS

- A000
- UPDATED COVER SHEET TO LATEST SUBMITTAL

- A001
- UPDATED PROJECT DATA UNIT COUNTS
 - REMOVED A202 FROM INDEX
 - REVISED CLIENT ADDRESS
 - REVISED PARKING COUNT REQUIREMENTS
 - REVISED BASE DENSITY ALLOWED AND DENSITY BONUS
 - UPDATED SETBACK REQUIREMENTS
 - UPDATED NUMBER OF STORIES

- A002
- ADDED PROJECT REVISION SHEET

- A110
- REVISED SIDEWALK TO (E) CONDITION ALONG ALAMEDA AVE.
 - ADDED DOOR TO (N) LEASING OFFICE ALONG ALAMEDA AVE.
 - REVISED TO A 4-STORY APARTMENT BUILDING
 - ADDED TRANSFORMER VAULT LOCATION
 - RECESSED STAIRWAY EXIT DOORS TO COVER DOORWAYS
 - UPDATED SITE TO SHOW LANDSCAPE PER LANDSCAPE DRAWINGS
 - ADDED DESIGN ARTICULATION TO POOL WALL ALONG OLIVE AVE.

- A111
- REVISED AVERAGE SETBACK CALCULATIONS BASED ON NEW HEIGHTS

- A200
- ADDED LEASING OFFICE AND MAILROOM(RM 128)
 - CHANGED MAINTENANCE ROOM TO ELECTRICAL ROOM(RM 161) AND DATA ROOM(RM133)
 - REVISED "STAIR-A" FOOTPRINT
 - REVISED TRASH ENCLOSURE, CHUTES, AND ADDED TRASH ENCLOSURE VESTIBULE
 - ADDED TRANSFORMER VAULT LOCATION
 - REMOVED (5) STUDIO UNITS AND (1) 1-BEDROOM AND ADDED (2) 2-BEDROOM UNITS

- A201
- REMOVED (2) 1-BEDROOM UNITS AND ADDED (1) 2-BEDROOM UNIT
 - ADDED TRASH ENCLOSURE ROOM
 - ADDED BALCONIES TO UNITS 221, 227, AND 204
 - ADDED ROOF DRAIN TO RETAIL
 - REVISED LAYOUT ON UNITS:
 - UNIT 203, 212, 215, 217, 219, AND 224

- A202
- REMOVED SHEET, NO LONGER USED

- A203
- CHANGED ROOF DRAIN TYPE TO HAVE BOTH PRIMARY AND OVERFLOW DRAINS AS ONE TYPE.
 - ADDED 5'-6" RETURN TO CANOPY

- A204 & A205
- RELOCATED STAIR NO. 01 TO ALIGN W/ STAIRCASE ON LEVELS 2-4

- A300
- REMOVED 5TH FLOOR
 - REVISED LEVEL HEIGHTS TO HAVE 10'-06" FLOOR TO FLOOR HEIGHT ON LEVELS 2-4
 - ADDED ELEVATION LOCATION MARKERS
 - ADDED TRANSFORMER VAULT LOCATION (1/A300)
 - ADDED BALCONIES TO UNITS. SEE A201 FOR LOCATIONS ON PLAN

- A301-A303
- UPDATED GLAZING PANEL LOCATIONS AND DIMENSIONS
 - REVISED LEVEL HEIGHTS TO HAVE 10'-06" FLOOR TO FLOOR HEIGHT ON LEVELS 2-4
 - REMOVED 5TH FLOOR

- A400-A410
- REVISED LEVEL HEIGHTS TO HAVE 10'-06" FLOOR TO FLOOR HEIGHT ON LEVELS 2-4
 - REMOVED 5TH FLOOR

- A601-A604
- UPDATED ENLARGED PLANS WITH REVISED LAYOUT PER A200 AND A201

- A901
- UPDATED RENDERS PER REMOVAL OF 5TH FLOOR



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PROJECT MANAGER: JH

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SHEET SIZE: 30x42

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PROJECT REVISIONS

SHEET NO:

A002



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2

SITE PLAN - PROPOSED

1/16" = 1'-0"

1

CLIENT SIGNATURE:

SIGNATURE:

DATE: 05.30.2023

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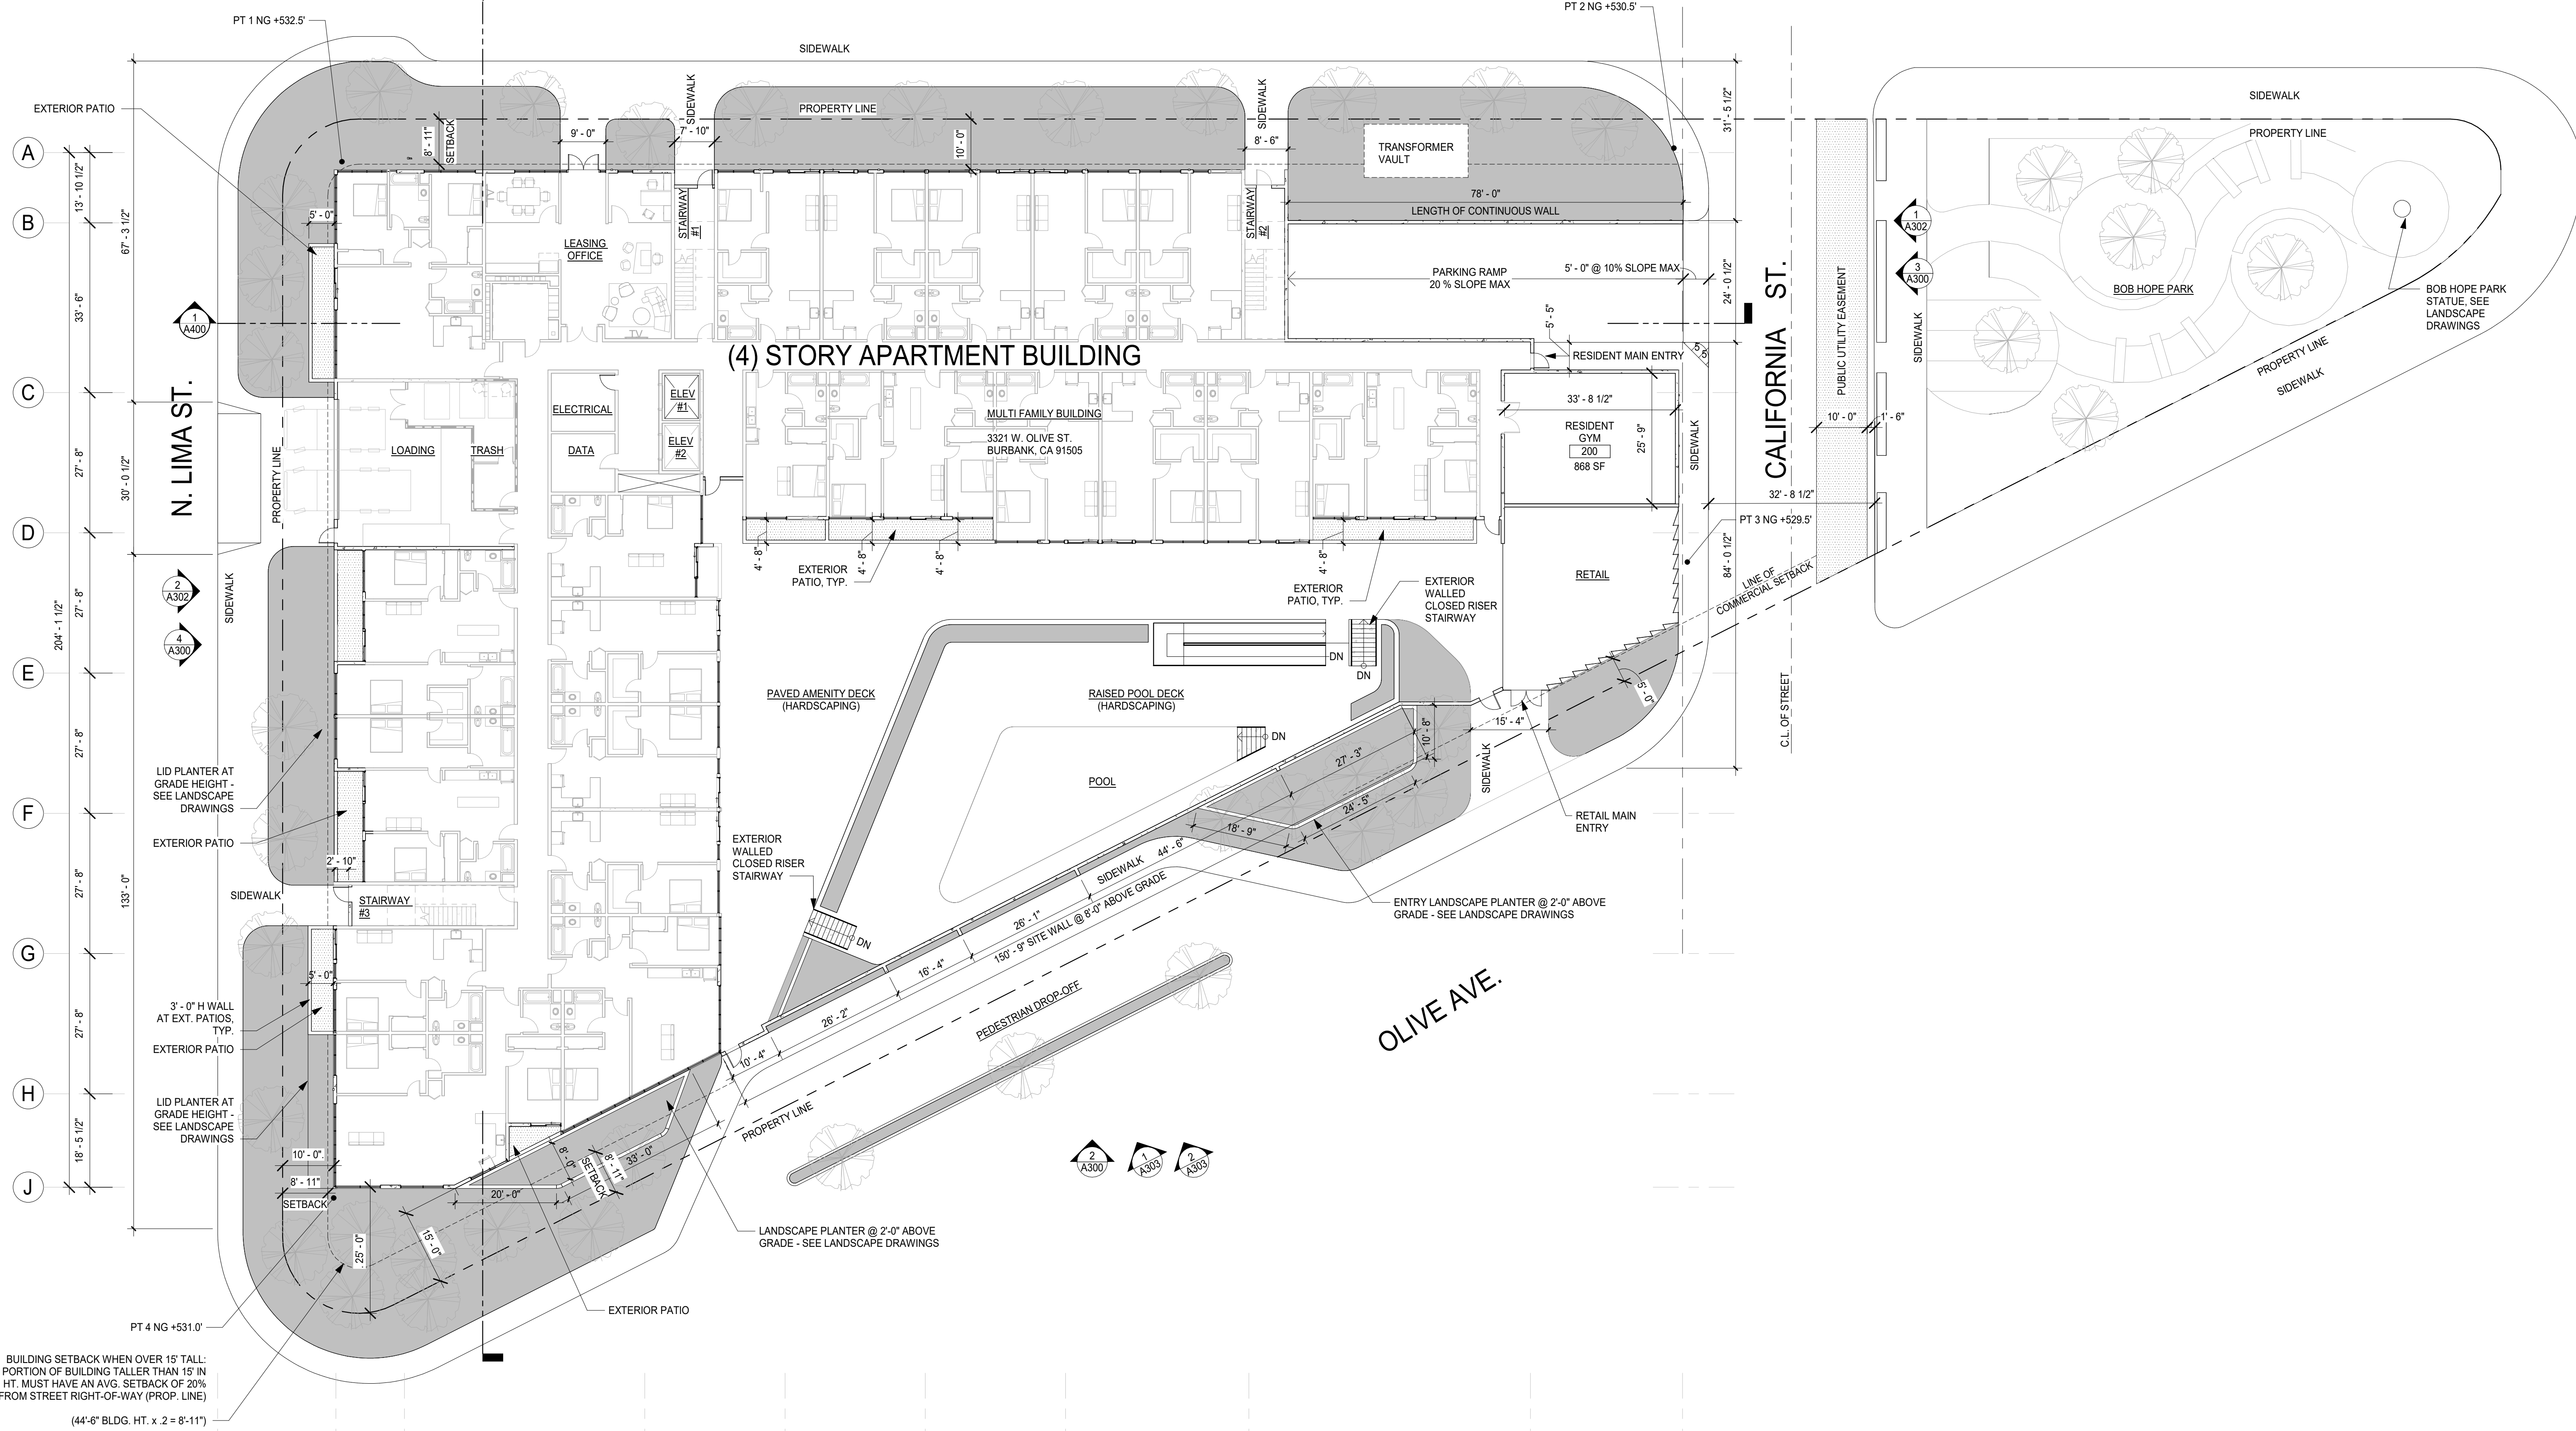
SITE PLAN - PROPOSED

SHEET NO:

A110

2

1 2 3 4 5 6 7 8 9 10
23'-4" 13'-6 1/2" 47'-5" 27'-8" 27'-8" 286'-11 1/2" 27'-8" 38'-2" 55'-6 1/2" 30'-0"
ALAMEDA AVE.



AVERAGE NATURAL GRADE TAB

KEYNOTES

GENERAL NOTES

LEGEND

PT 1 EL. +532.5'
PT 2 EL. +530.5'
PT 3 EL. +529.5'
PT 4 EL. +531.0'
TOTAL 2123.5
ANG = 2123.5 / 4
= 530.875'

- SEE SHEETS A003 AND A004 FOR GENERAL NOTES.
- REFER TO SHEET A001 FOR SYMBOLS AND ABBREVIATIONS LEGEND.
- ALL WORK SHALL COMPLY WITH CURRENTLY ADOPTED ICC, NFPA, IAPMO, ASME BY JURISDICTION HAVING AUTHORITY.
- IN NO CASE SHALL DIMENSIONS OR OBJECTS OF ANY KIND BE SCALED FROM ANY DRAWINGS. THE CONTRACTOR SHALL VERIFY ALL CONDITIONS AND DIMENSIONS IN THE FIELD BEFORE PROCEEDING WITH SUBSEQUENT WORK. CONTRACTOR SHALL BRING ANY DISCREPANCIES OR CLARIFICATIONS TO THE ARCHITECT'S ATTENTION PRIOR TO PROCEEDING WITH ANY RELATED WORK.
- ALL DIMENSIONS ARE TO FACE UNLESS NOTED OTHERWISE. FINISH FLOOR ELEVATIONS ARE TO TOP OF CONCRETE SLAB AND/OR TOP OF CONCRETE UNDERLAYMENT UNLESS NOTED OTHERWISE. CEILING HEIGHT DIMENSIONS ARE TO BE TO FINISHED SURFACES UNLESS NOTED OTHERWISE.
- DIMENSIONS MARKED "MIN." INDICATE A MINIMUM CLEARANCE THAT MUST BE MAINTAINED WHEN FINISH MATERIALS ARE INSTALLED.
- ALL NEW LANDSCAPE AND PLANTER BOXES TO RECEIVE DRIP IRRIGATION SYSTEM. SEE CIVIL AND IRRIGATION DRAWINGS FOR ADDITIONAL INFORMATION.
- PROVIDE (1) EV OUTLET AT (2) PARKING STALLS. REFER TO ELECTRICAL DRAWINGS FOR LOCATIONS.
- ALL EXTERIOR EXPOSED STAIR TREADS AND STEPS TO SLOPE 2% MAXIMUM TOWARD NOSE OF TREAD, TYP.
- ALL STAIR TREADS TO RECEIVE CAST-IN CONTRASTING WARNING STRIP, TYP.
- IN CASE OF CONFLICT OF INDICATED PAVING OR SLAB SLOPES WITH CIVIL DRAWINGS, THE CIVIL DRAWINGS SHALL GOVERN.
- ALL EXPOSED FLASHING AND BRAKE METAL TO BE PRIMED AND FIELD PAINTED TO MATCH ADJACENT WALL COLOR. VERIFY COLOR WITH ARCHITECT PRIOR TO PAINTING.
- WHENEVER UTILITY POLE IS SITUATED ON A LOT, REQUIRED YARD ACCESS SHALL BE MAINTAINED TO PROVIDE UNOBSTRUCTED ACCESS TO THE POLE. PER BMC 10-1-1206.
- UTILITY POLES SERVICING THE PROPERTY MAY EXTEND INTO THE SIDE YARD TWO (2) FEET FROM THE LOT LINE. PER BMC 10-1-1211 (F).
- NEW DEVELOPMENT SHALL NOT BLOCK RELAY OR COMMUNICATION PATHS OF MEDIA RELATED USES IN EXISTENCE AT THE TIME OF OVERLAY ZONE ADOPTION OR SHALL INCORPORATE IN THE DEVELOPMENT, AT NO EXPENSE TO THE TRANSMITTER, WHATEVER RELAY FACILITIES ARE NECESSARY TO ENSURE THE CONTINUATION OF EXISTING RELAY OR COMMUNICATION PATHS. THIS REQUIREMENT IS APPLICABLE DURING CONSTRUCTION AS WELL AS DURING OPERATION OF ANY FUTURE PROJECT.
- ALL LANDSCAPE AREAS SHALL BE MAINTAINED IN A HEALTHY AND GROWING CONDITION AND SHALL REQUIRE REGULAR PRUNING, FERTILIZING, MOWING AND TRIMMING. ALL LANDSCAPE AREAS SHALL BE KEPT FREE OF WEEDS AND DEBRIS. ALL IRRIGATION SYSTEMS SHALL BE KEPT OPERABLE, INCLUDING ADJUSTMENTS, REPLACEMENTS, REPAIRS AND CLEANING AS PART OF REGULAR MAINTENANCE. DAMAGED PLANTING AND IRRIGATION EQUIPMENT WILL BE REPAIRED OR REPLACED WITHIN 30 DAYS.
- ALL TREES SHALL BE STAKED WITH A DOUBLE STEEL PIPE AND SEALED WITH RUBBER OR PLASTIC STRIP OR OTHER COMMERCIAL TIE MATERIAL. WIRE SHALL NOT BE USED TO TIE THE TREE TO THE STAKES.
- GRADED MOUNDS SHALL NOT EXCEED A 3:1 SLOPE. MOUNDS OVER 30 INCHES HIGH SHALL NOT BE PLACED WITHIN TEN (10) FEET OF ANY STREET AND/OR ALLEY INTERSECTION.

- ALL LANDSCAPED AREAS SHALL BE PROVIDED WITH AN IRRIGATION SYSTEM APPROVED BY THE PARK, RECREATION AND COMMUNITY SERVICES DIRECTOR CONSISTING OF WATERLINES AND SPRINKLERS DESIGNED TO PROVIDE HEAD TO HEAD COVERAGE AND TO MINIMIZE OVERSPRAY ONTO STRUCTURES, WALKS AND WINDOWS.
- ENERGY CONSERVATION SHALL BE AN IMPORTANT CONSIDERATION IN NIGHTTIME LIGHTING PLANS. PLANS FOR THE DESIGN AND OPERATION OF LIGHTING AND ILLUMINATION SHALL BE DEVELOPED CONSISTENT WITH THE LATEST TECHNICAL AND OPERATIONAL ENERGY CONSERVATION CONCEPTS.
- ALL COMMERCIAL AND INDUSTRIAL REFUSE BINS SHALL BE EQUIPPED WITH NONMETALLIC LIDS, WHICH SHALL REMAIN CLOSED AT ALL TIMES EXCEPT WHEN REFUSE IS BEING DEPOSITED OR EMPTIED.

- N.I.C. NOT IN CONTRACT
- PROPERTY LINE
- CONCRETE PAVING
- PERVIOUS PAVING
- LANDSCAPE AREAS



WOLCOTT
ARCHITECTURE
527 W. 7TH ST., STE. 130A, LOS ANGELES, CA 90014
310.204.2290 | WWW.WOLCOTTAI.COM

CONSULTANT:

CERTIFICATION:

NOT FOR CONSTRUCTION.
DRAWINGS ARE FOR
CONCEPTUAL DESIGN ONLY
AND ARE SUBJECT TO
REVIEW AND APPROVAL
FROM LOCAL JURISDICTION.

PROJECT:

BOB HOPE CENTRAL -
RESIDENTIAL
3201 W OLIVE AVE.
BURBANK, CA 91505

FLOOR/LEVEL:

ISSUE OR REVISION NOTES:

NO.	DATE	DESCRIPTION
	06.22.22	PLANNING DEVELOPMENT STANDARDS
		SUBMITTAL
1	10.01.22	BURBANK PLANNING COMMENTS
2	06.22.2023	PLANNING DEVELOPMENT STANDARDS
		RESUBMITTAL

CLIENT SIGNATURE:

SIGNATURE: DATE: 06.09.2023

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Written dimensions on these drawings shall have precedence over unnoted dimensions. Dimensions shall only be used for reference and any variations from the dimensions and conditions shown by these drawings, shop details must be submitted to this office for approval before proceeding with fabrication.

PROJECT NO: 21-2779-1

DRAWN BY: RM CHECKED BY: SP

PROJECT MANAGER: CC

DRAWING SCALE: 1/16" = 1'-0"

SHEET SIZE: 30x42

DRAWING TITLE:

AVERAGE SETBACK
DIAGRAM - 2ND FLOOR

SHEET NO:

A111

1 2 3 4 5 6 7 8 9 10
23'-4" 13'-6 1/2" 47'-5" 27'-8" 27'-8" 286'-11 1/2" 36'-2" 55'-6 1/2" 30'-0" 7'-0 1/2"

ALAMEDA AVE.

N. LIMA ST.

CALIFORNIA ST.

OLIVE AVE.

AVERAGE SETBACK CALCULATION

LIMA ST.
REQUIRED: 204.126' X 8.9' = 1,816.71
PROVIDED: 204.125' X 10.167' = 2,075.34

ALAMEDA:
REQUIRED: 290.000' X 8.9' = 2,581.43
PROVIDED: 290.000' X 10.0' = 2,900.00

CALIFORNIA:
REQUIRED: 74.5' X 8.9' = 663.05
PROVIDED: 74.5' X 96.02' = 7,132.57

OLIVE AVE:
REQUIRED: 299.417' X 8.9' = 2,664.81
PROVIDED: (SUM OF BELOW) = 14,544.299

21.167' X 20.147' = 432.167
59.083' X 15.083' = 891.149
45.417' X 59.917' = 2,721.250
173.667' X 60.459' = 10,499.733

TOTAL REQUIRED X BLDG LENGTHS = 7,726.0
TOTAL PROVIDED X BLDG LENGTHS = 26,822.293

BUILDING SETBACK WHEN OVER 15' TALL:
PORTION OF BUILDING TALLER THAN 15' IN
HT. MUST HAVE AN AVG. SETBACK OF 20%
FROM STREET RIGHT-OF-WAY (PROP. LINE)

(44'-6" BLDG. HT. X 2 = 8'-11")



WOLCOTT
ARCHITECTURE
527 W. 11TH ST., STE. 100A, LOS ANGELES, CA 90014
310.204.2790 | WWW.WOLCOTTAI.COM

CONSULTANT:

CERTIFICATION:

NOT FOR CONSTRUCTION.
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AND ARE SUBJECT TO
REVIEW AND APPROVAL
FROM LOCAL JURISDICTION.

PROJECT:

BOB HOPE CENTRAL - RESIDENTIAL

3201 W OLIVE AVE.
BURBANK, CA 91505

FLOOR/LEVEL:

ISSUE OR REVISION NOTES:

NO.	DATE	DESCRIPTION
1	06.22.22	PLANNING DEVELOPMENT STANDARDS SUBMITTAL
2	10.01.22	BURBANK PLANNING COMMENTS
2	06.22.2023	PLANNING DEVELOPMENT STANDARDS RESUBMITTAL

CLIENT SIGNATURE:

SIGNATURE:

DATE: 06.02.2023

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PROJECT NO: 21-2779-1

DRAWN BY: RM CHECKED BY: SL

PROJECT MANAGER: CC

DRAWING SCALE: As indicated

SHEET SIZE: 30x42

DRAWING TITLE:

FLOOR PLAN - 1ST
FLOOR

SHEET NO:

A200

KEYNOTES

GENERAL NOTES

- SEE SHEETS A003 AND A004 FOR GENERAL NOTES.
- REFER TO SHEET A001 FOR SYMBOLS AND ABBREVIATIONS LEGEND.
- ALL WORK SHALL COMPLY WITH CURRENTLY ADOPTED ICC, NFPA, IAPMO, ASME BY JURISDICTION HAVING AUTHORITY.
- IN NO CASE SHALL DIMENSIONS OR OBJECTS OF ANY KIND BE SCALED FROM ANY DRAWINGS. THE CONTRACTOR SHALL VERIFY ALL CONDITIONS AND DIMENSIONS IN THE FIELD BEFORE PROCEEDING WITH SUBSEQUENT WORK. CONTRACTOR SHALL BRING ANY DISCREPANCIES OR CLARIFICATIONS TO THE ARCHITECT'S ATTENTION PRIOR TO PROCEEDING WITH ANY RELATED WORK.
- ALL DIMENSIONS ARE TO FACE UNLESS OTHERWISE NOTED. FINISH FLOOR ELEVATIONS ARE TO TOP OF CONCRETE SLAB AND/OR TOP OF CONCRETE UNDERLAYMENT UNLESS OTHERWISE NOTED. CEILING HEIGHT DIMENSIONS ARE TO BE FINISHED SURFACES UNLESS OTHERWISE NOTED.
- DIMENSIONS MARKED "MIN" INDICATE A MINIMUM CLEARANCE THAT MUST BE MAINTAINED WHEN FINISH MATERIALS ARE INSTALLED.
- ALL FRAMING MEMBERS SHALL BE SO ARRANGED AND SPACED AS TO PERMIT INSTALLATION OF PIPE CONDUITS AND DUCTWORK WITH A MINIMUM OF CUTTING. CONTRACTOR SHALL PROVIDE AND INSTALL ALL STIFFENERS, BRACES, BACK-UP PLATES AND SUPPORTING BRACKETS AS REQUIRED FOR THE INSTALLATION OF ALL WALL MOUNTED OR SUSPENDED MECHANICAL AND ELECTRICAL EQUIPMENT, FIXTURES, BATHROOM ACCESSORIES, GRAB BARS, MILLWORK.
- ALL WOOD FRAMING IN EXTERIOR WALLS TO BE FIRE-RETARDANT TREATED WOOD COMPLYING WITH CBC SECTION 2303.2. WOOD FRAMING TO INCLUDE BUT NOT LIMITED TO: STUDS, BLOCKING, EXTERIOR PLYWOOD SHEATHING, SILL PLATES, TOP PLATES, ETC.
- ADJUST FRAMING CONFIGURATION AT ALL FAN COIL UNITS WITHIN FLOOR/CEILING ASSEMBLY AS REQUIRED TO MAINTAIN FIRE-RATED ASSEMBLY. REFER TO MECHANICAL AND STRUCTURAL DRAWINGS FOR ADDITIONAL INFORMATION.
- ALL WOOD FRAMING IN CONTACT WITH CONCRETE IS TO BE PRESSURE TREATED.
- ALL FINISH WALL SURFACES TO BE FLUSH UNLESS OTHERWISE NOTED. PROVIDE FURRING AS REQUIRED.
- ALL GYPSUM BOARD WALLS AND CEILINGS TO BE TAPED, SANDED, AND PRIMED TO LEVEL 4 FINISH UNLESS OTHERWISE NOTED.
- REFER TO SHEET A000 FOR WALL TYPES.
- REFER TO SHEET A700 FOR DOOR SCHEDULE AND DETAILS AND WINDOW SCHEDULE AND DETAILS.
- REFER TO SHEET A710 FOR FINISH, LIGHT FIXTURE, APPLIANCE, EQUIPMENT, AND PLUMBING FIXTURE SCHEDULES.
- ALL LIGHTING TO BE SHIELDED TO ELIMINATE GLARE ONTO ADJACENT PROPERTIES PER BMC 10-1-2017 (H) (1) CARPORTS, GARAGES, PARKING AREAS, AND DRIVEWAYS SHALL CONTAIN SECURITY LIGHTING. PRIMARY PEDESTRIAN SAFETY PER BMC 10-1-2017 (G)(2).
- (NOT USED)
- LIGHTS CONFORMING TO STANDARDS PRESCRIBED BY THE PUBLIC WORKS DIRECTOR SHALL BE INSTALLED IN ALL NIGHTTIME PARKING LOTS USED FOR PUBLIC PARKING OR FOR COMMERCIAL PURPOSES. PER BMC 10-1-1420.
- PER TABLE N-5 OF THE BURBANK 2035 GENERAL PLAN THIS PROJECT WILL BE CONSTRUCTED IN A WAY TO ACHIEVE INTERIOR NOISE LEVELS US 45DBA MAX. PER TABLE N-3 MAXIMUM ALLOWABLE NOISE EXPOSURE. TRANSPORTATION SOURCES OF THE GENERAL PLAN.
- THIS PROJECT WILL BE CONSTRUCTED INCORPORATING BUILDING DESIGN FEATURES THAT MINIMIZE THE CONSUMPTION OF ENERGY, WATER, AND OTHER NATURAL RESOURCES CONSISTENT WITH THE CITY'S BUILDING AND ENERGY CODES.


LEGEND


	NOT IN CONTRACT		ALIGN ELEMENTS
	EXISTING MILLWORK		ROOM NAME AND NUMBER
	NEW MILLWORK		FIRE EXTINGUISHER CABINET
	EXISTING PARTITION		NEW PLUMBING FIXTURES
	EXISTING DOOR		
	WALL TAG. REFER TO A800		
	NEW PARTITION PER PLAN		
	NEW DOOR		
	DOOR NUMBER. REFER TO A700		
	WINDOW TAG. REFER TO A700		
	NEW PLUMBING FIXTURE, APPLIANCE, OR EQUIPMENT. REFER TO A710		

FLOOR PLAN - 1ST FLOOR

1/16" = 1'-0"

1

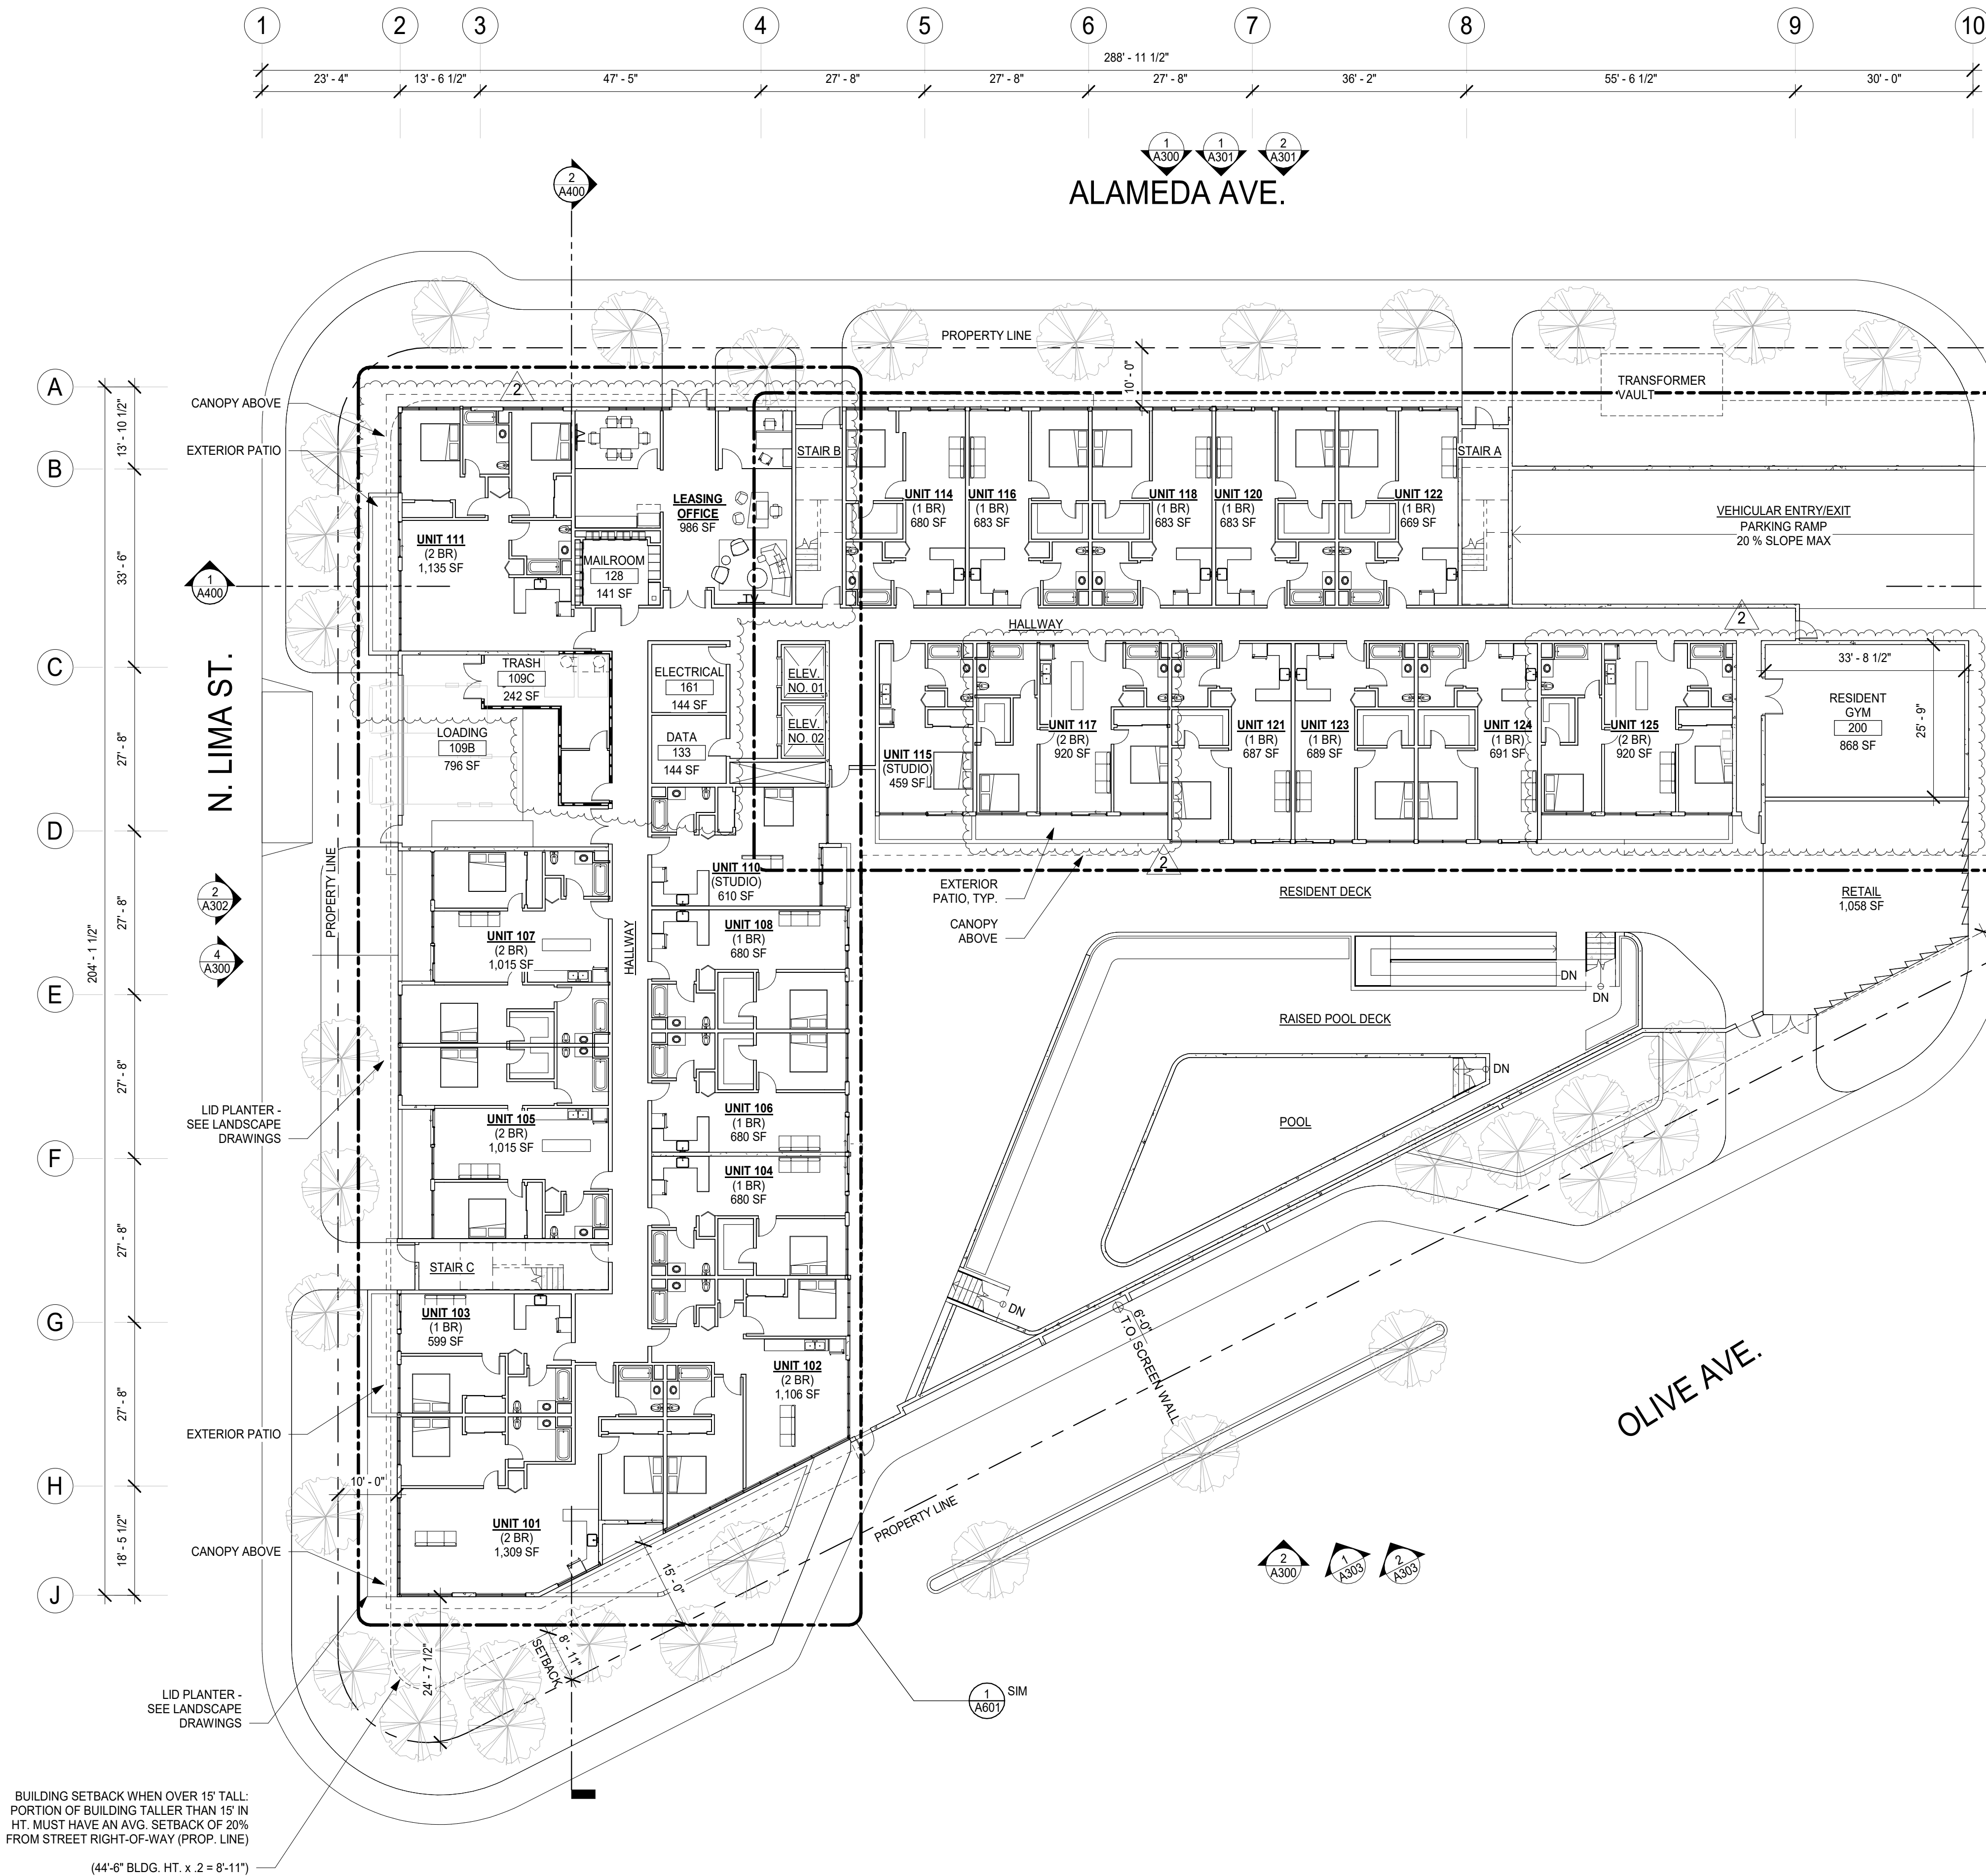

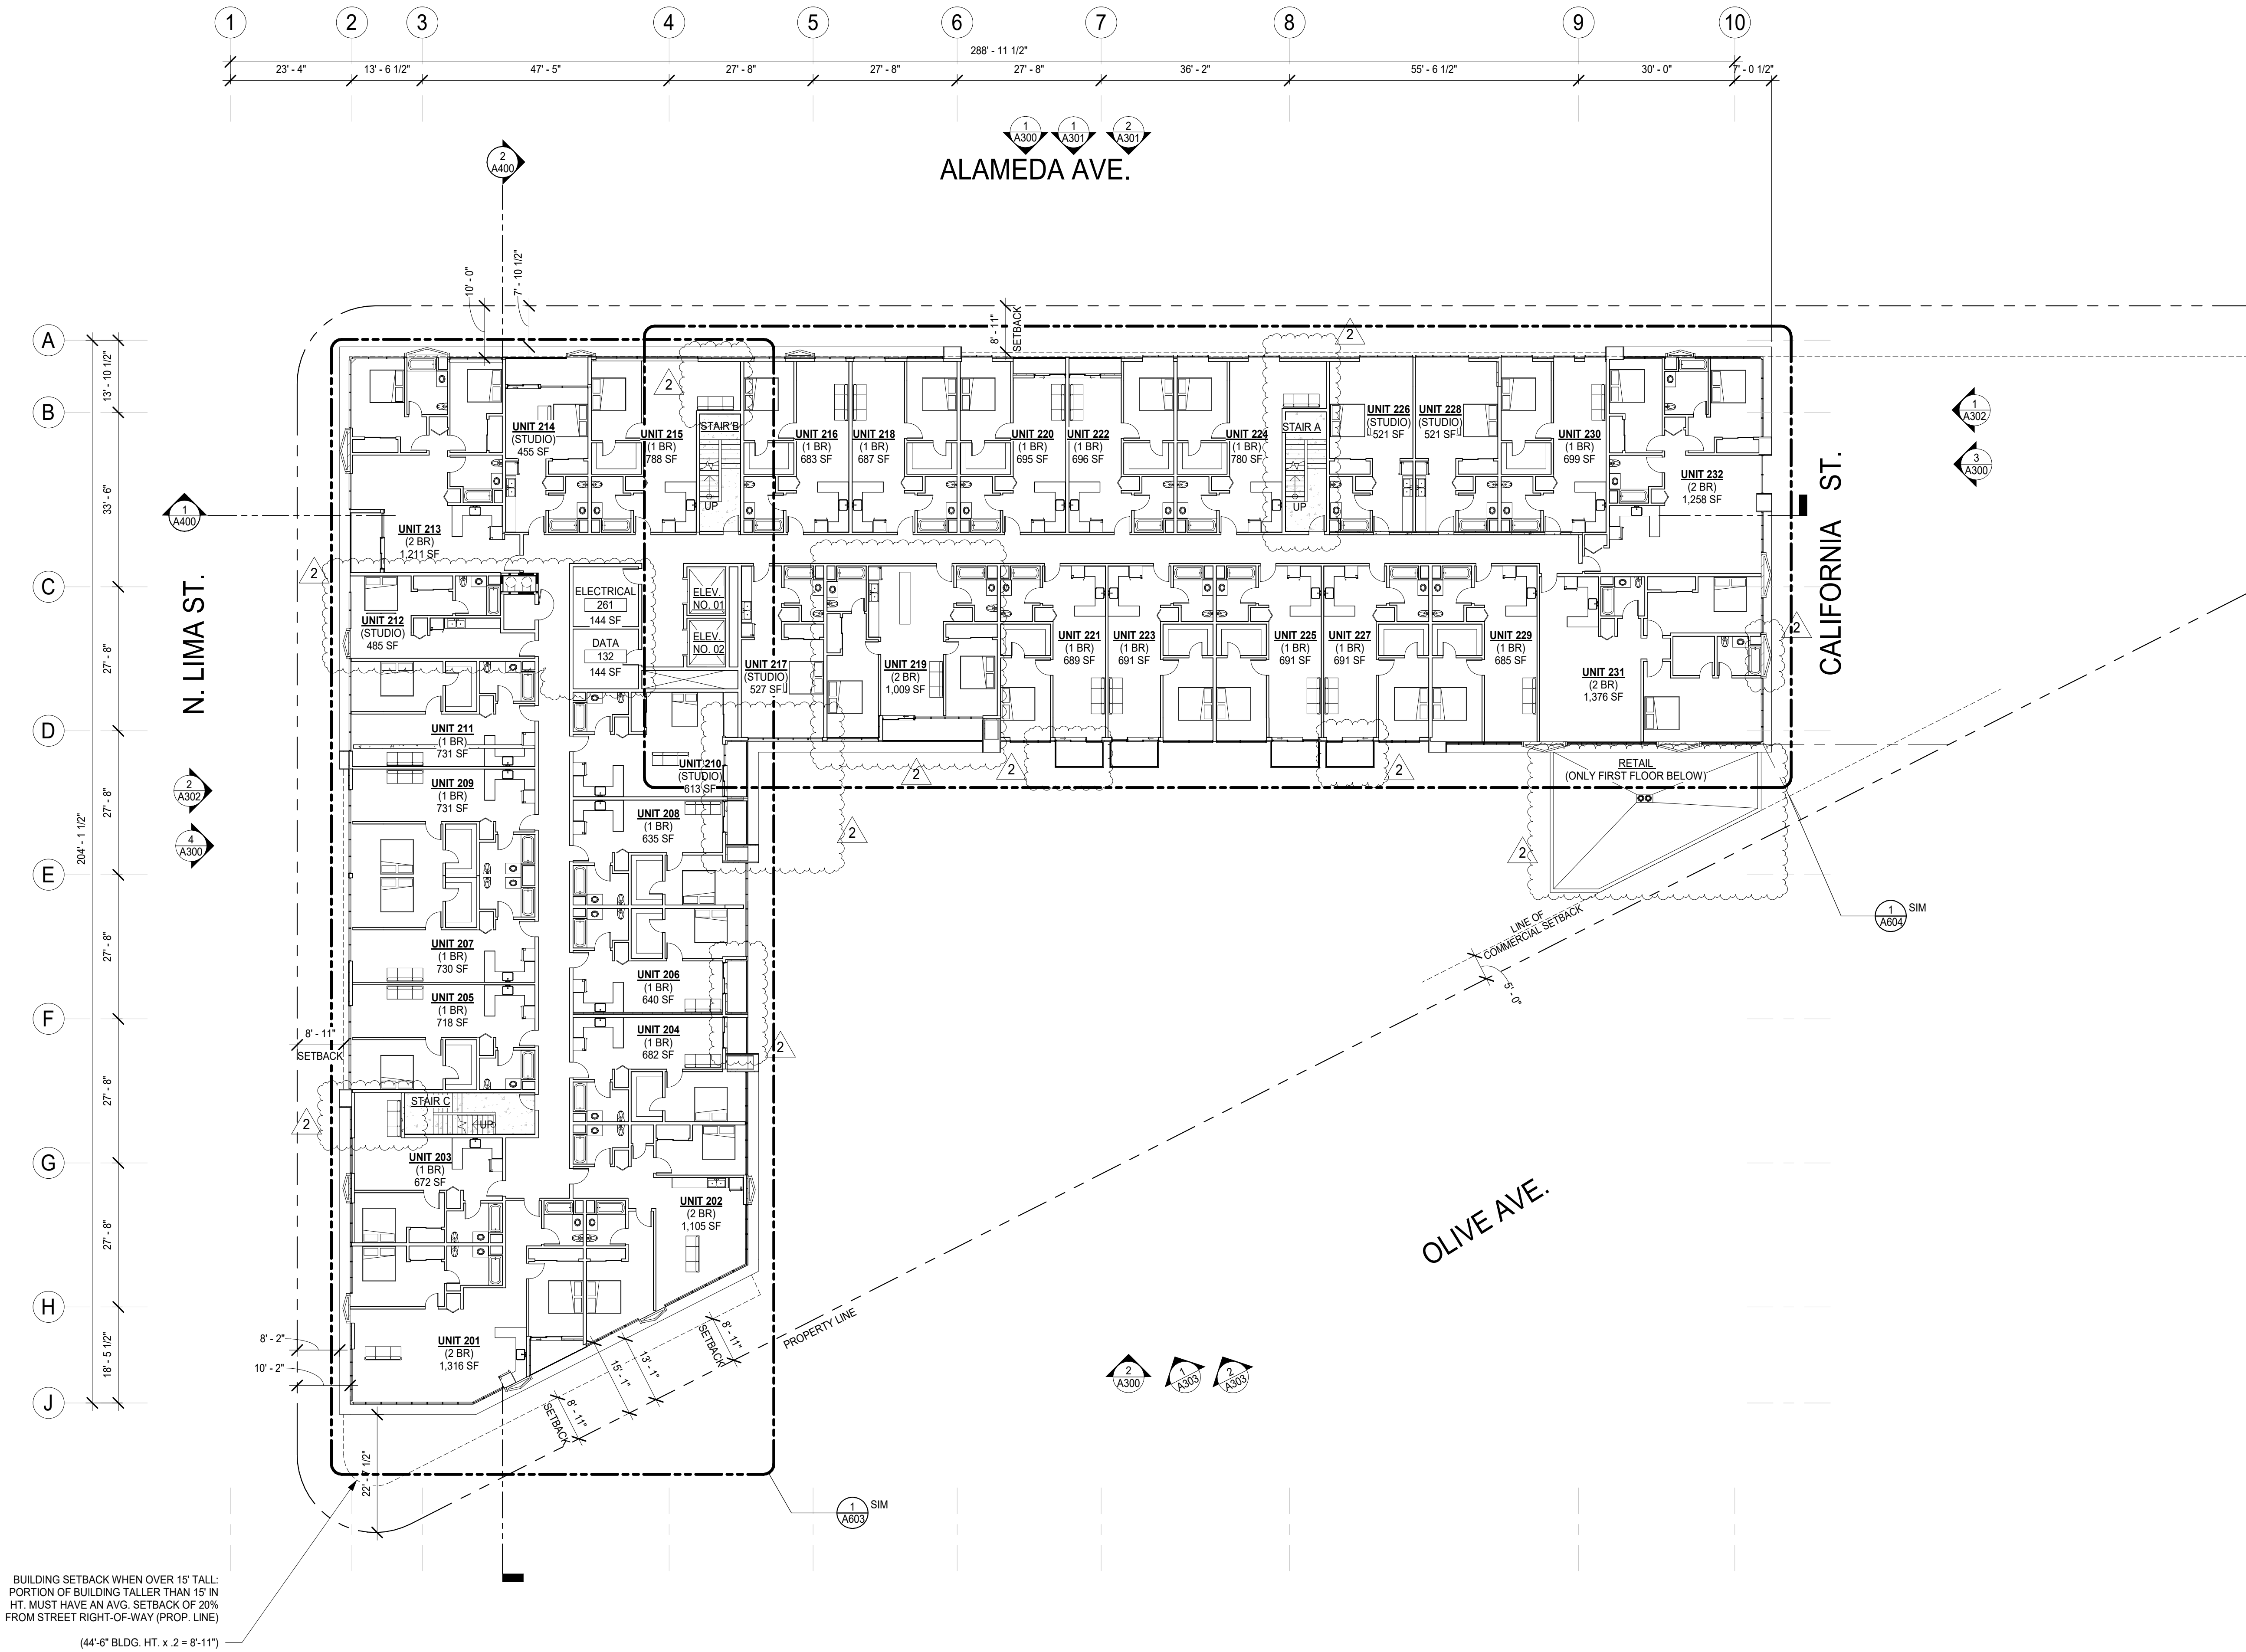

KEYNOTES

- SEE SHEETS A003 AND A004 FOR GENERAL NOTES.
- REFER TO SHEET A001 FOR SYMBOLS AND ABBREVIATIONS LEGEND.
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- ALL WOOD FRAMING IN EXTERIOR WALLS TO BE FIRE-RETARDANT TREATED WOOD COMPLYING WITH CBC SECTION 2303.2 WOOD FRAMING TO INCLUDE BUT NOT LIMITED TO: STUDS, BLOCKING, EXTERIOR PLYWOOD SHEATHING, SILL PLATES, TOP PLATES, ETC.
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- ALL GYPSUM BOARD WALLS AND CEILINGS TO BE TAPED, SANDED, AND PRIMED TO LEVEL 4 FINISH U.O.N.
- REFER TO SHEET A000 FOR WALL TYPES.
- REFER TO SHEET A700 FOR DOOR SCHEDULE AND DETAILS AND WINDOW SCHEDULE AND DETAILS.
- REFER TO SHEET A710 FOR FINISH, LIGHT FIXTURE, APPLIANCE, EQUIPMENT, AND PLUMBING FIXTURE SCHEDULES.
- ALL LIGHTING TO BE SHIELDED TO ELIMINATE GLARE ONTO ADJACENT PROPERTIES PER BMC 10-1-2017 (H) (1) CARPORTS, GARAGES, PARKING AREAS, AND DRIVEWAYS SHALL CONTAIN SECURITY LIGHTING. PRIMARY PEDESTRIAN SAFETY PER BMC 10-1-2017 (G)(2)
- (NOT USED)
- LIGHTS CONFORMING TO STANDARDS PRESCRIBED BY THE PUBLIC WORKS DIRECTOR SHALL BE INSTALLED IN ALL NIGHTTIME PARKING LOTS USED FOR PUBLIC PARKING OR FOR COMMERCIAL PURPOSES. PER BMC 10-1-1420.
- PER TABLE N-5 OF THE BURBANK 2035 GENERAL PLAN THIS PROJECT WILL BE CONSTRUCTED IN A WAY TO ACHIEVE INTERIOR NOISE LEVELS US 45DBA MAX. PER TABLE N-3 MAXIMUM ALLOWABLE NOISE EXPOSURE - TRANSPORTATION SOURCES OF THE GENERAL PLAN.
- THIS PROJECT WILL BE CONSTRUCTED INCORPORATING BUILDING DESIGN FEATURES THAT MINIMIZE THE CONSUMPTION OF ENERGY, WATER, AND OTHER NATURAL RESOURCES CONSISTENT WITH THE CITY'S BUILDING AND ENERGY CODES.

LEGEND

	NOT IN CONTRACT		ALIGN ELEMENTS
	EXISTING MILLWORK		ROOM NAME AND NUMBER
	NEW MILLWORK		FIRE EXTINGUISHER CABINET
	EXISTING PARTITION		NEW PLUMBING FIXTURES
	EXISTING DOOR		
	WALL TAG. REFER TO A800		
	NEW PARTITION PER PLAN		
	NEW DOOR		
	DOOR NUMBER. REFER TO A700		
	WINDOW TAG. REFER TO A700		
	NEW PLUMBING FIXTURE, APPLIANCE, OR EQUIPMENT. REFER TO A710		

FLOOR PLAN - 2ND FLOOR

1/16" = 1'-0"

1



WOLCOTT
ARCHITECTURE
527 W. 7TH ST., STE. 100A, LOS ANGELES, CA 90014
310.204.2790 | WWW.WOLCOTTAI.COM

CONSULTANT:

CERTIFICATION:

NOT FOR CONSTRUCTION.
DRAWINGS ARE FOR
CONCEPTUAL DESIGN ONLY
AND ARE SUBJECT TO
REVIEW AND APPROVAL
FROM LOCAL JURISDICTION.

PROJECT:

BOB HOPE CENTER - RESIDENTIAL

3201 W OLIVE AVE.
BURBANK, CA 91505

FLOOR/LEVEL:

ISSUE OR REVISION NOTES:

NO.	DATE	DESCRIPTION
	06.22.22	PLANNING DEVELOPMENT STANDARDS SUBMITTAL
1	10.01.22	BURBANK PLANNING COMMENTS
2	06.22.2023	PLANNING DEVELOPMENT STANDARDS RESUBMITTAL

CLIENT SIGNATURE:

SIGNATURE: DATE: -

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PROJECT NO: 21-2779-1

DRAWN BY: RM, CS, GD CHECKED BY: SL

PROJECT MANAGER: CC


DRAWING SCALE: As indicated

SHEET SIZE: 30x42

DRAWING TITLE:
FLOOR PLAN - 2ND-4TH
FLOOR

SHEET NO:

A201

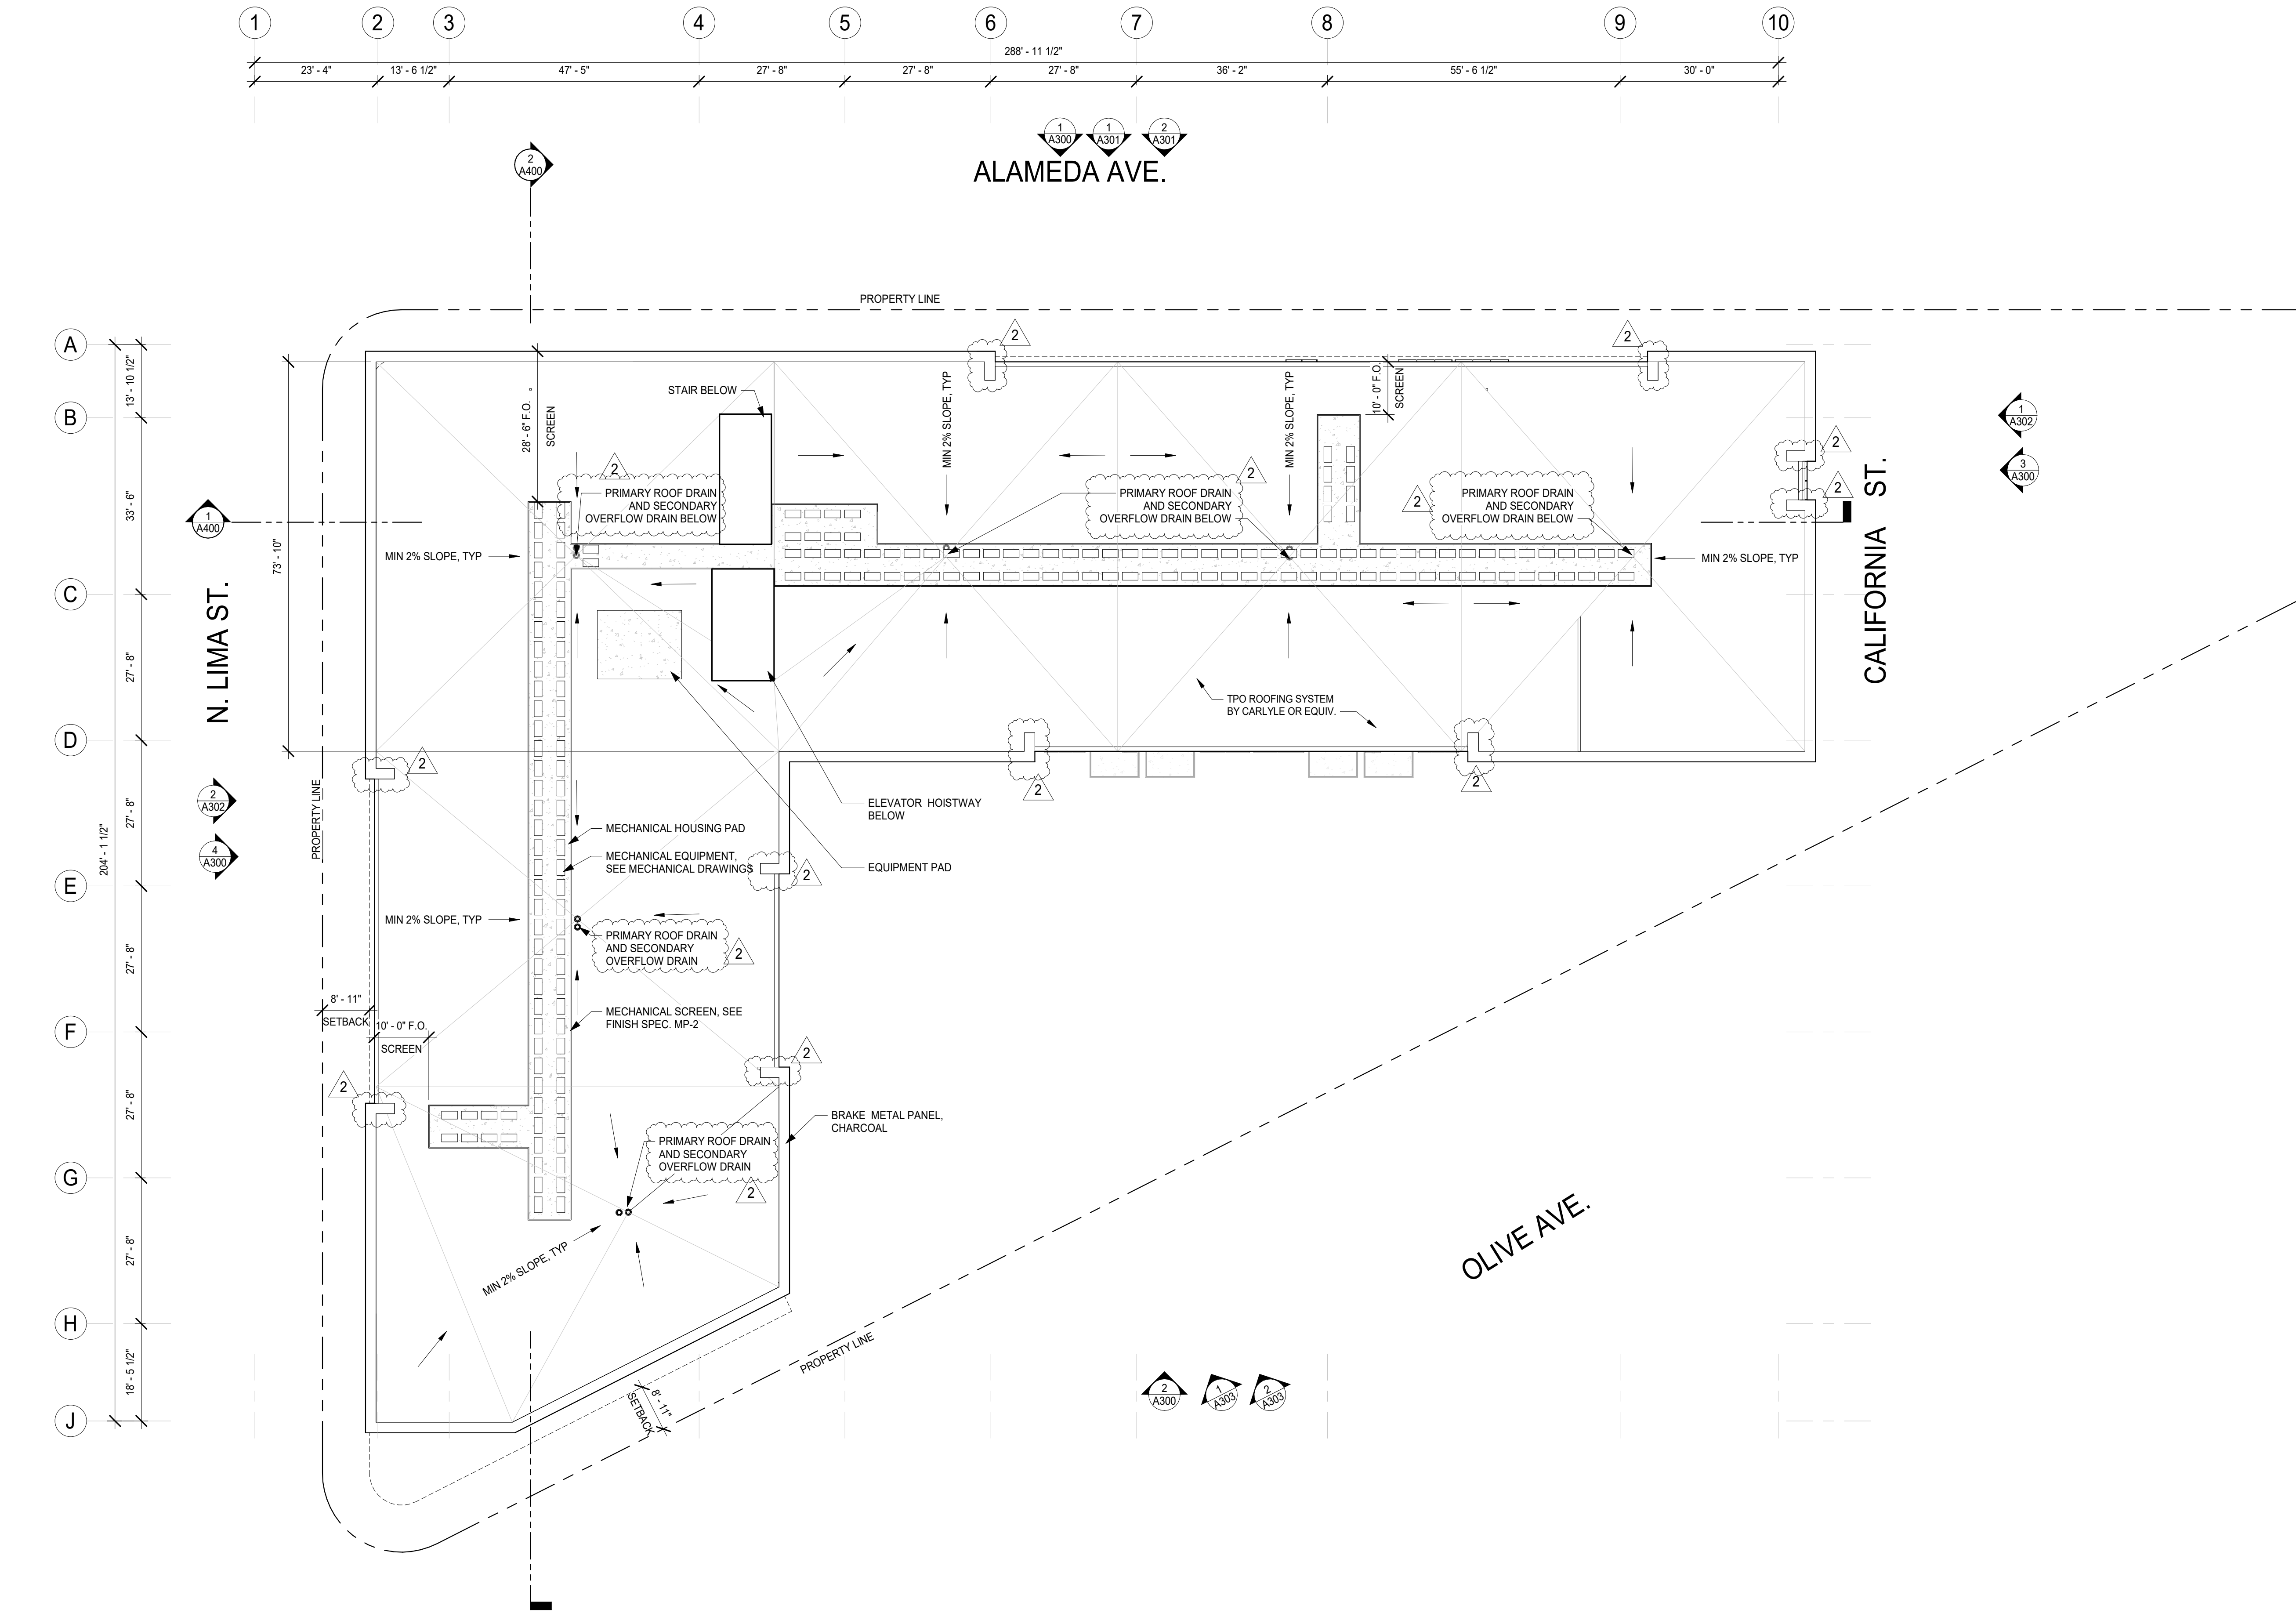

ROOF PLAN
1/16" = 1'-0"

1

KEYNOTES



CONSULTANT:

CERTIFICATION:

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REVIEW AND APPROVAL
FROM LOCAL JURISDICTION.

PROJECT:

BOB HOPE CENTER -
RESIDENTIAL
3201 W OLIVE AVE.
BURBANK, CA 91505

GENERAL NOTES

- SEE SHEETS A003 AND A004 FOR GENERAL NOTES.
- PROVIDE NEW UL CLASS 'A' ROOF THROUGHOUT ENTIRE ROOF AREA, UP AND AROUND ALL WALL, PARAPETS, CRICKETS, MECHANICAL PLATFORMS AND VENTS.
- ROOFING SPECIFICATIONS: ROOFING MEMBRANE AND INSULATION BY GAF, PROVIDE GAF MECHANICALLY ATTACHED SINGLE-PLY EVERGUARD TPO 80 MIL ROOFING MEMBRANE SYSTEM (UL1308) WITH 2 LAYERS OF 2" POLYISO INSULATION (DO NOT EXCEED 3" THICK INSULATION) FOR A MINIMUM R-30 R VALUE.
- PROVIDE GAF ROOFING ACCESSORIES INCLUDING: VENTS BOOTS, SQUARE TUBE WRAP, 36" CORNER CURB WRAP, INSIDE CORNER, DETAILING MEMBRANE, FLASHING STRIP, SEALER POCKET AND TPO COATED METAL DRAINS.
- INSTALL ALL ROOFING ACCESSORIES AND ROOFING SYSTEM PER MANUFACTURER'S REQUIREMENTS. PROVIDE NEW ROOF WITH MINIMUM 2% SLOPE TO DRAINS.
- SEE SHEET AXXX FOR ROOF PENETRATION DETAILS.
- ALL LIGHTING TO BE SHIELDED TO ELIMINATE GLARE ONTO ADJACENT PROPERTIES PER BMC 10-1-2017 (H) (1).
- CARPORTS, GARAGES, PARKING AREAS, AND DRIVEWAYS SHALL CONTAIN SECURITY LIGHTING. PRIMARY PEDESTRIAN SAFETY PER BMC 10-1-2017 (G)(2).
- LIGHTS CONFORMING TO STANDARDS PRESCRIBED BY THE PUBLIC WORKS DIRECTOR SHALL BE INSTALLED IN ALL NIGHTTIME PARKING LOTS USED FOR PUBLIC PARKING OR FOR COMMERCIAL PURPOSES. PER BMC 10-1-1420.
- PER TABLE N-5 OF THE BURBANK 2035 GENERAL PLAN THIS PROJECT WILL BE CONSTRUCTED IN A WAY TO ACHIEVE INTERIOR NOISE LEVELS US 45DBA MAX, PER TABLE N-3 MAXIMUM ALLOWABLE NOISE EXPOSURE - TRANSPORTATION SOURCES OF THE GENERAL PLAN.
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LEGEND

- | | | |
|--|----------------------------------|-----------------|
| | N.I.C. | NOT IN CONTRACT |
| | ROOF DRAIN | |
| | ROOF CRICKET | |
| | ROOF SLOPE | |
| | ROOF HATCH | |
| | WALK PAD | |
| | ALIGN ELEMENTS | |
| | PARAPET WALL TYPE TO MATCH BELOW | |

FLOOR/LEVEL:

ISSUE OR REVISION NOTES:

NO.	DATE	DESCRIPTION
	06.22.22	PLANNING DEVELOPMENT STANDARDS SUBMITTAL
1	10.01.22	BURBANK PLANNING COMMENTS
2	06.22.2023	PLANNING DEVELOPMENT STANDARDS RESUBMITTAL

CLIENT SIGNATURE:

SIGNATURE:

DATE: 06.01.2023

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PROJECT NO: 21-2779-1

DRAWN BY: CS

CHECKED BY: SP

PROJECT MANAGER: JH

DRAWING SCALE: As indicated

SHEET SIZE: 30x42


DRAWING TITLE:

ROOF PLAN

SHEET NO:

A203

A204 

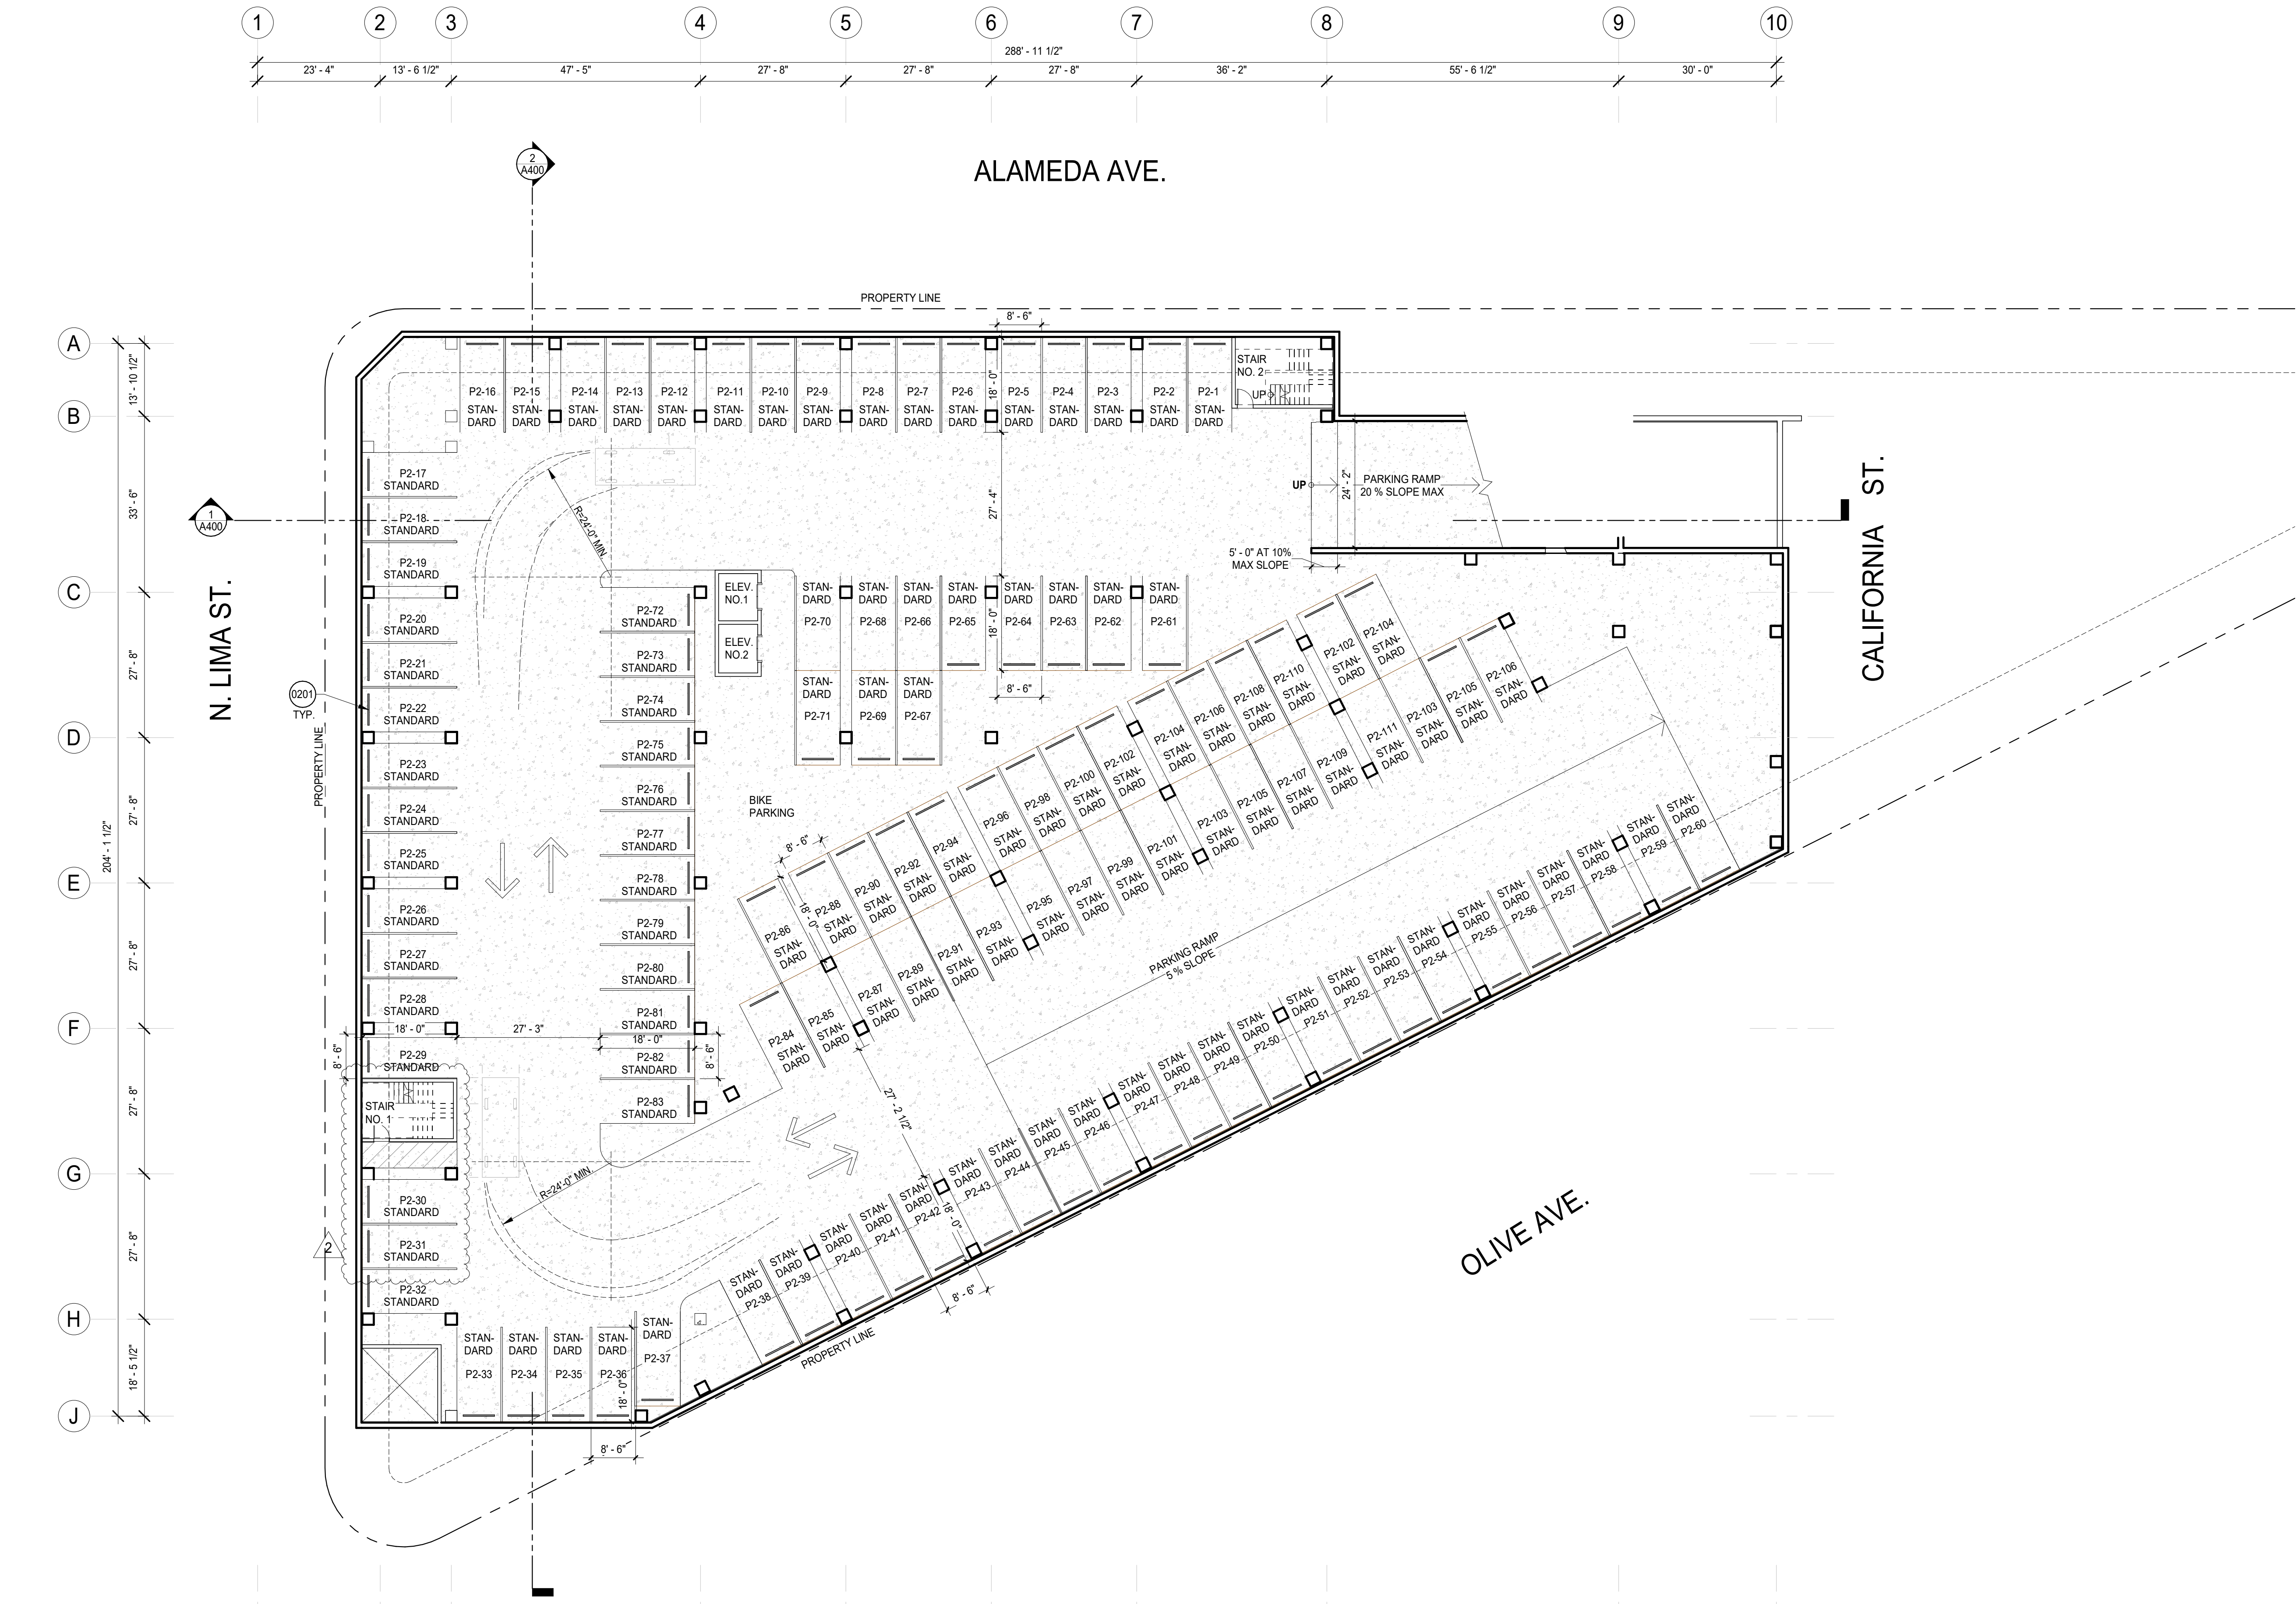

FLOOR PLAN - P-2
1/16" = 1'-0"

KEYNOTES

(201) WHEELSTOP, TYP. AT ALL STALLS.

GENERAL NOTES

- SEE SHEETS A003 AND A004 FOR GENERAL NOTES.
- REFER TO SHEET A001 FOR SYMBOLS AND ABBREVIATIONS LEGEND.
- ALL WORK SHALL COMPLY WITH CURRENTLY ADOPTED ICC, NFPA, IAPMO, ASME BY JURISDICTION HAVING AUTHORITY.
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- DIMENSIONS MARKED "MIN" INDICATE A MINIMUM CLEARANCE THAT MUST BE MAINTAINED WHEN FINISH MATERIALS ARE INSTALLED.
- ALL FRAMING MEMBERS SHALL BE SO ARRANGED AND SPACED AS TO PERMIT INSTALLATION OF PIPE CONDUITS AND DUCTWORK WITH A MINIMUM OF CUTTING. CONTRACTOR SHALL PROVIDE AND INSTALL ALL STIFFENERS, BRACES, BACK-UP PLATES AND SUPPORTING BRACKETS AS REQUIRED FOR THE INSTALLATION OF ALL WALL MOUNTED OR SUSPENDED MECHANICAL AND ELECTRICAL EQUIPMENT, FIXTURES, BATHROOM ACCESSORIES, GRAB BARS, MILLWORK.
- ALL WOOD FRAMING IN EXTERIOR WALLS TO BE FIRE-RETARDANT TREATED WOOD COMPLYING WITH CBC SECTION 2303.2. WOOD FRAMING TO INCLUDE BUT NOT LIMITED TO: STUDS, BLOCKING, EXTERIOR PLYWOOD SHEATHING, SILL PLATES, TOP PLATES, ETC.
- ADJUST FRAMING CONFIGURATION AT ALL FAN COIL UNITS WITHIN FLOOR/CEILING ASSEMBLY AS REQUIRED TO MAINTAIN FIRE-RATED ASSEMBLY. REFER TO MECHANICAL AND STRUCTURAL DRAWINGS FOR ADDITIONAL INFORMATION.
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- REFER TO SHEET A000 FOR WALL TYPES.
- REFER TO SHEET A700 FOR DOOR SCHEDULE AND DETAILS AND WINDOW SCHEDULE AND DETAILS.
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- (NOT USED)
- LIGHTS CONFORMING TO STANDARDS PRESCRIBED BY THE PUBLIC WORKS DIRECTOR SHALL BE INSTALLED IN ALL NIGHTTIME PARKING LOTS USED FOR PUBLIC PARKING OR FOR COMMERCIAL PURPOSES. PER BMC 10-1-1420.
- PER TABLE N-6 OF THE BURBANK 2035 GENERAL PLAN THIS PROJECT WILL BE CONSTRUCTED IN A WAY TO ACHIEVE INTERIOR NOISE LEVELS US 45DBA MAX. PER TABLE N-3 MAXIMUM ALLOWABLE NOISE EXPOSURE - TRANSPORTATION SOURCES OF THE GENERAL PLAN.
- THIS PROJECT WILL BE CONSTRUCTED INCORPORATING BUILDING DESIGN FEATURES THAT MINIMIZE THE CONSUMPTION OF ENERGY, WATER, AND OTHER NATURAL RESOURCES CONSISTENT WITH THE CITY'S BUILDING AND ENERGY CODES.

LEGEND

N.I.C.

NOT IN CONTRACT

EXISTING MILLWORK

NEW MILLWORK

EXISTING PARTITION

EXISTING DOOR

WALL TAG. REFER TO A800

NEW PARTITION PER PLAN

NEW DOOR

DOOR NUMBER. REFER TO A700

WINDOW TAG. REFER TO A700

NEW GLAZING OR STOREFRONT SYSTEM PER SCHEDULE.

NEW PLUMBING FIXTURE, APPLIANCE, OR EQUIPMENT. REFER TO A710

ALIGN

ALIGN ELEMENTS

RM NAME #

ROOM NAME AND NUMBER

F.E.C.

FIRE EXTINGUISHER CABINET

NEW PLUMBING FIXTURES

CLIENT SIGNATURE:

SIGNATURE: _____ DATE: _____

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PROJECT NO: 21-2779-1

DRAWN BY: RM, CS, GD CHECKED BY: SL

PROJECT MANAGER: CC

DRAWING SCALE: As indicated

SHEET SIZE: 30x42

DRAWING TITLE: FLOOR PLAN - P-2

SHEET NO: A205

WOLCOTT ARCHITECTURE

527 W. 11TH ST., STE. 100A, LOS ANGELES, CA 90014
310.204.2790 | WWW.WOLCOTTARCH.COM

CONSULTANT:

CERTIFICATION:

NOT FOR CONSTRUCTION. DRAWINGS ARE FOR CONCEPTUAL DESIGN ONLY AND ARE SUBJECT TO REVIEW AND APPROVAL FROM LOCAL JURISDICTION.

PROJECT:

BOB HOPE CENTER - RESIDENTIAL


3201 W OLIVE AVE.
BURBANK, CA 91505

PROJECT

3201 W OLIVE AVE.
BURBANK, CA 91505

7000

A300

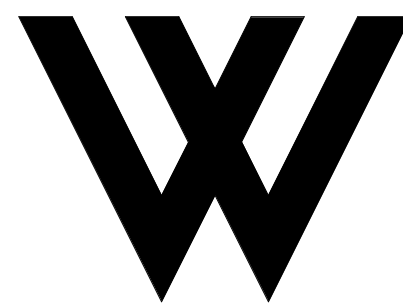

WOLCOTT
ARCHITECTURE
527 W. 7TH ST., STE. 1304, LOS ANGELES, CA 90014
310.204.2790 | WWW.WOLCOTTAI.COM

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FROM LOCAL JURISDICTION.

PROJECT:

BOB HOPE CENTRAL - RESIDENTIAL

3201 W OLIVE AVE.
BURBANK, CA 91505

FLOOR/LEVEL:

ISSUE OR REVISION NOTES:

NO.	DATE	DESCRIPTION
	06.22.22	PLANNING DEVELOPMENT STANDARDS SUBMITTAL
1	10.01.22	BURBANK PLANNING COMMENTS
2	06.22.2023	PLANNING DEVELOPMENT STANDARDS RESUBMITTAL

CLIENT SIGNATURE:

SIGNATURE: DATE: -

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PROJECT NO: 21-2779-1

DRAWN BY: RM, CS, GD CHECKED BY: SL

PROJECT MANAGER: CC

DRAWING SCALE: 1/8" = 1'-0"


SHEET SIZE: 30x42

DRAWING TITLE:

ENLARGED EXTERIOR
ELEVATIONS


SHEET NO:

A301

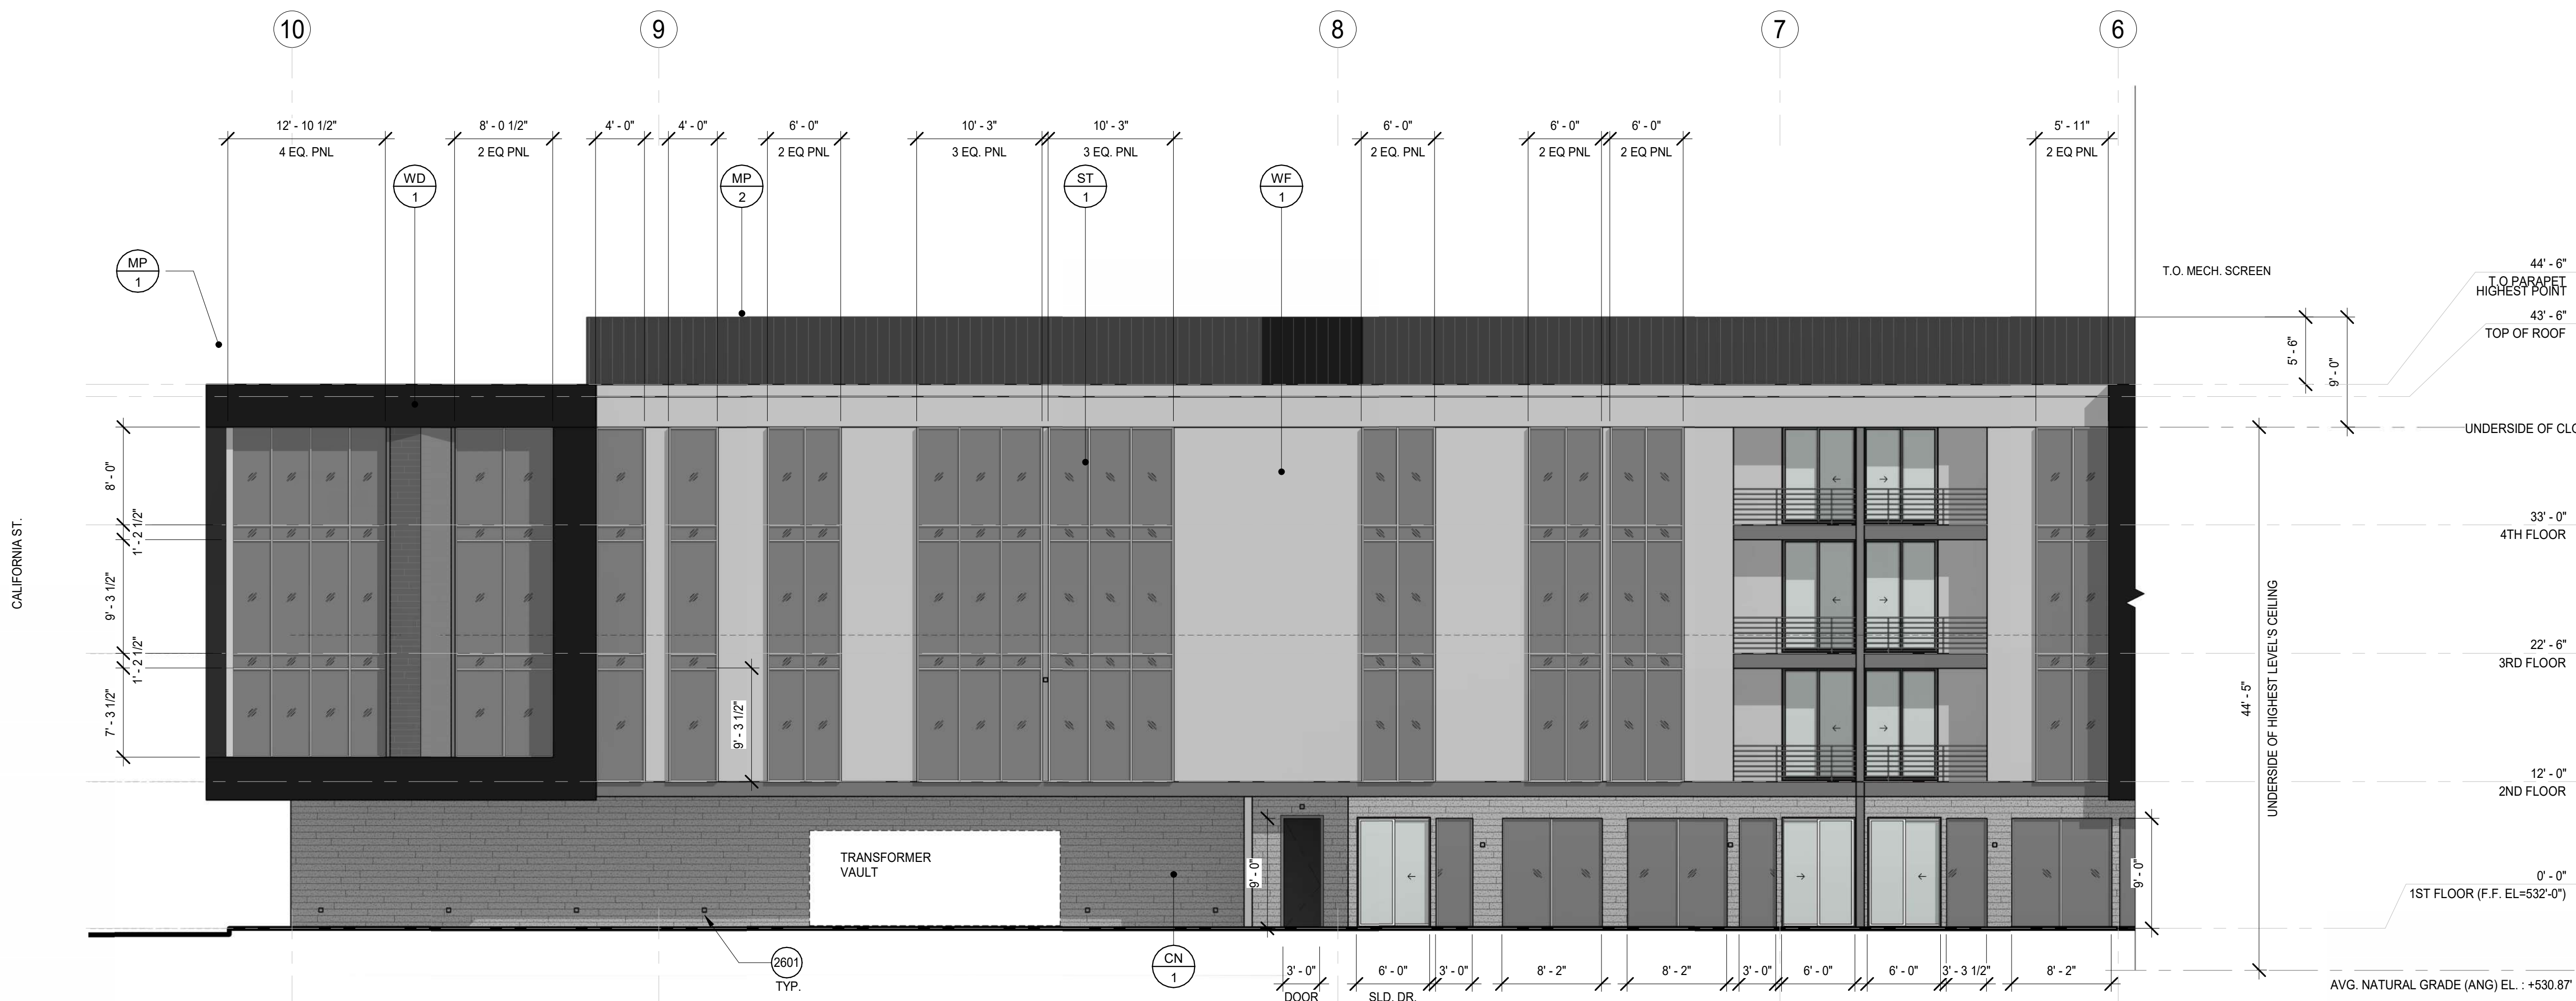

ENLARGED NORTH ELEVATION (W. ALAMEDA AVE.)

SCALE
1/8" = 1'-0"

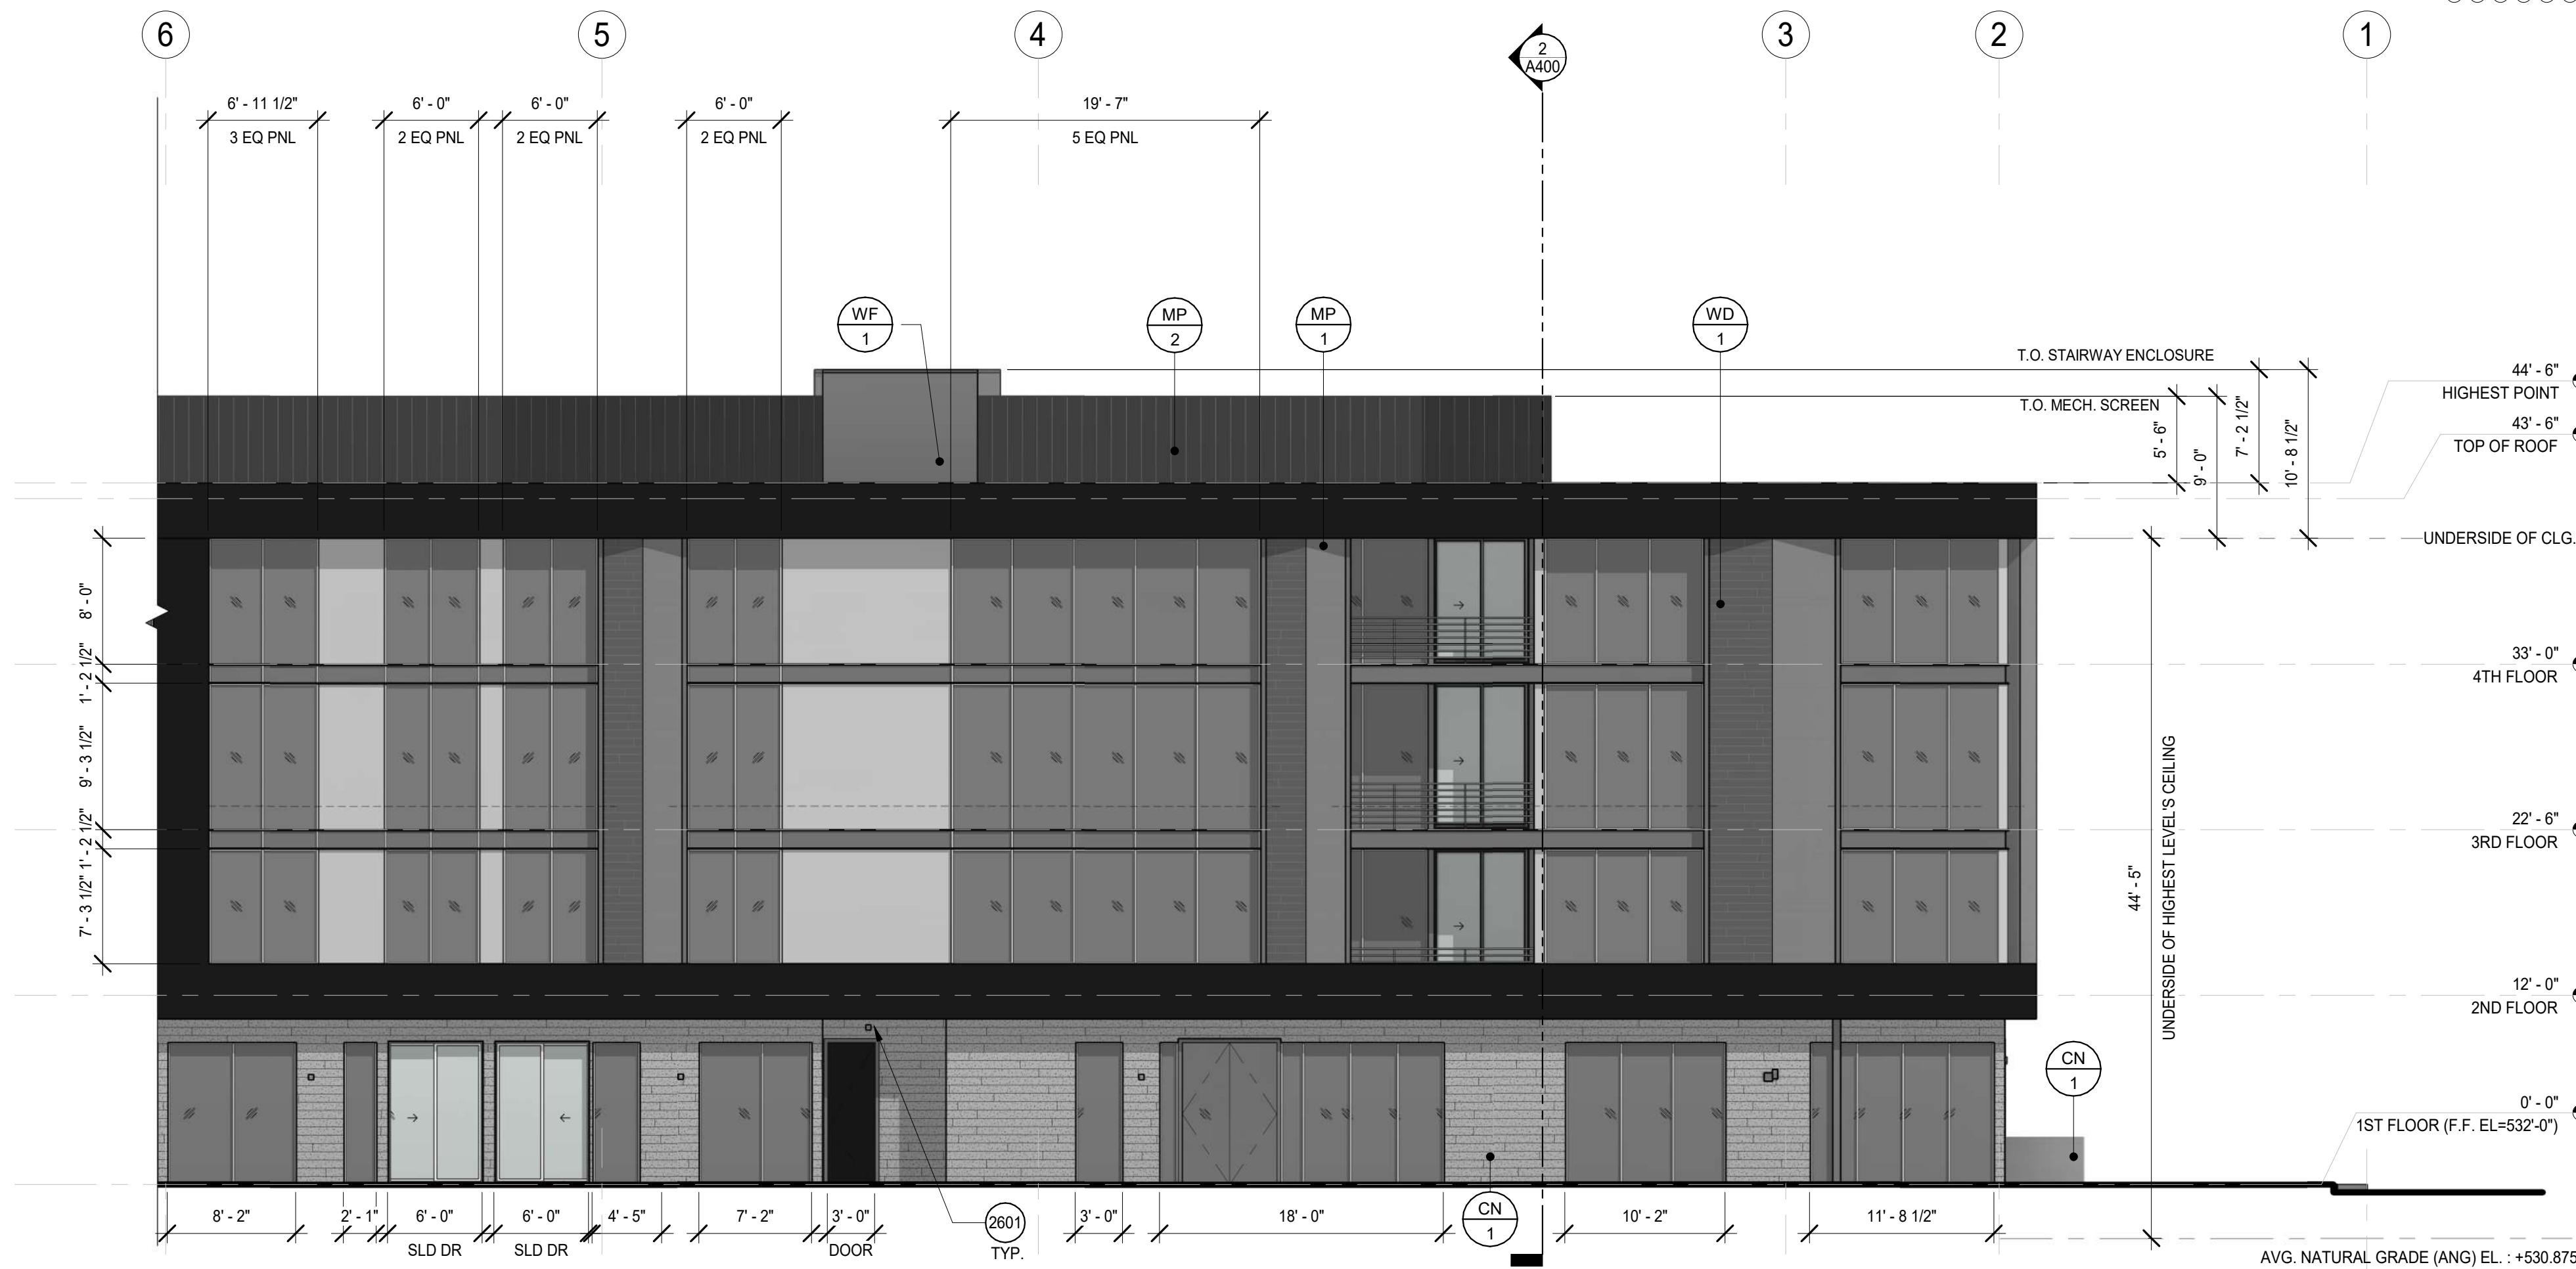

ENLARGED NORTH ELEVATION (W. ALAMEDA AVE.)

1/8" = 1'-0"

MATERIAL FINISHES

FINISH NO.	DESCRIPTION	MANUFACTURER	SPECIFICATION	LOCATION	NOTES
CN-1	CONCRETE	-	BOARD-FORMED CONCRETE	SEE FINISH ELEVATION	DAVIS COLORS, DARK GREY (CARBON) 8084
MP-1	METAL PANEL	ALUMABOARD	ALUMABOARD FW-10, CHARCOAL	SEE FINISH ELEVATION	-
MP-2	METAL PANEL	METAL SALES	TLC-1, 22 GA. FLAT SEAM METAL PANEL	SEE FINISH ELEVATION	COLOR TO MATCH PT-1
ST-1	STEEL	-	STEEL BARSTOCK HANDRAIL	SEE FINISH ELEVATION	COLOR TO MATCH PT-2
WD-1	WOOD COMPOSITE PANEL	TRESPA	METEON-LIFT BROWN	SEE FINISH ELEVATION	-
WF-1	WALL FINISH	EIFS	EIFS, PAINTED	SEE FINISH ELEVATION	PAINTED PT-1

KEYNOTES

2601 (N) EXTERIOR WALL MOUNTED LIGHTING BY SISTEMALUX OR EQUIV.

GENERAL NOTES


- (N) EXTERIOR GLAZING SYSTEMS BY ARCADIA OR EQUIV. MFR.
- (N) EXTERIOR WINDOW SYSTEMS BY ARCADIA OR EQUIV. MFR.
- (N) EXTERIOR DOOR SYSTEMS BY ARCADIA OR EQUIV. MFR.
- SEE MATERIAL FINISH LEGEND FOR OTHER MATERIAL FINISHES
- NO MECHANICAL VENTING SHALL FACE A RESIDENTIAL ZONE, UNLESS SUCH MECHANICAL VENTING IS MORE THAN 300 FEET FROM THE NEAREST RESIDENTIALLY ZONED PROPERTY. FURTHERMORE, NO MECHANICAL VENTING SHALL BE LOCATED ANYWHERE ON THE BUILDING WITHIN 50 FEET FROM THE NEAREST RESIDENTIALLY ZONED PROPERTY.
- ALL PROJECT LIGHTING SHOULD BE DESIGNED TO ELIMINATE GLARE ONTO ADJACENT PROPERTIES. THE DESIGN OF LIGHT STANDARDS SHALL BE COMPATIBLE WITH THE BUILDING ARCHITECTURE AND ADJACENT LIGHT STANDARDS IN THE PUBLIC RIGHT-OF-WAY AND ADJACENT PROPERTIES.
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- BUILDING ELEVATIONS FACING A RESIDENTIAL ZONE WITH 50 PERCENT OR MORE OF THE BUILDING SURFACE IN GLASS SHALL BE LIMITED TO A MAXIMUM OF 15 PERCENT REFLECTIVITY FOR THOSE MATERIALS. BUILDING ELEVATIONS FACING A RESIDENTIAL ZONE WITH LESS THAN 50 PERCENT OF SURFACE IN GLASS SHALL BE LIMITED TO A MAXIMUM OF 20 PERCENT REFLECTIVITY FOR THOSE MATERIALS.

GLAZING PRODUCTS:
ARCADIA ACOUSTIC GLAZING PRODUCTS, T237 STC 43 DOUBLE GLAZED WITH OUTBOARD GLASS 1/2" THK AIR SPACE OF 1/2", 1/4" INSBOARD GLAZING.

LEGEND

ABBREVIATION	FINISH TYPE
B	CARPET
GL	GLASS
P	PAINT
PL	PLASTIC LAMINATE
SC	SEALED CONCRETE
SDT	STATIC DISSIPATIVE TILE
SS	SOLID SURFACING
SST	STAINLESS STEEL
ST	STONE
SV	SHEET VINYL
T	TILE
VT	VINYL TILE
VCT	VINYL COMPOSITION TILE
W	WALL COVERING
WD	WOOD
WS	WAINSCOT
WT	WINDOW TREATMENT

1. SEE SHEETS A003 AND A004 FOR GENERAL NOTES.

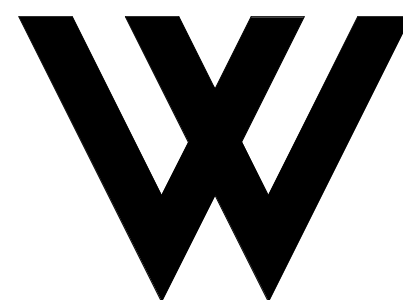

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PROJECT:

BOB HOPE CENTRAL -
RESIDENTIAL

3201 W OLIVE AVE.
BURBANK, CA 91505

FLOOR/LEVEL:

ISSUE OR REVISION NOTES:

NO.	DATE	DESCRIPTION
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1	10.01.22	SUBMITTAL
2	06.22.2023	BURBANK PLANNING COMMENTS
		PLANNING DEVELOPMENT STANDARDS
		RESUBMITTAL

2

CLIENT SIGNATURE:

SIGNATURE:

DATE: -

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PROJECT NO: 21-2779-1

DRAWN BY: RM, CS, GD CHECKED BY: SL

PROJECT MANAGER: CC

DRAWING SCALE: 1/8" = 1'-0"

SHEET SIZE: 30x42


DRAWING TITLE:

ENLARGED EXTERIOR
ELEVATIONS

SHEET NO:

A302


2

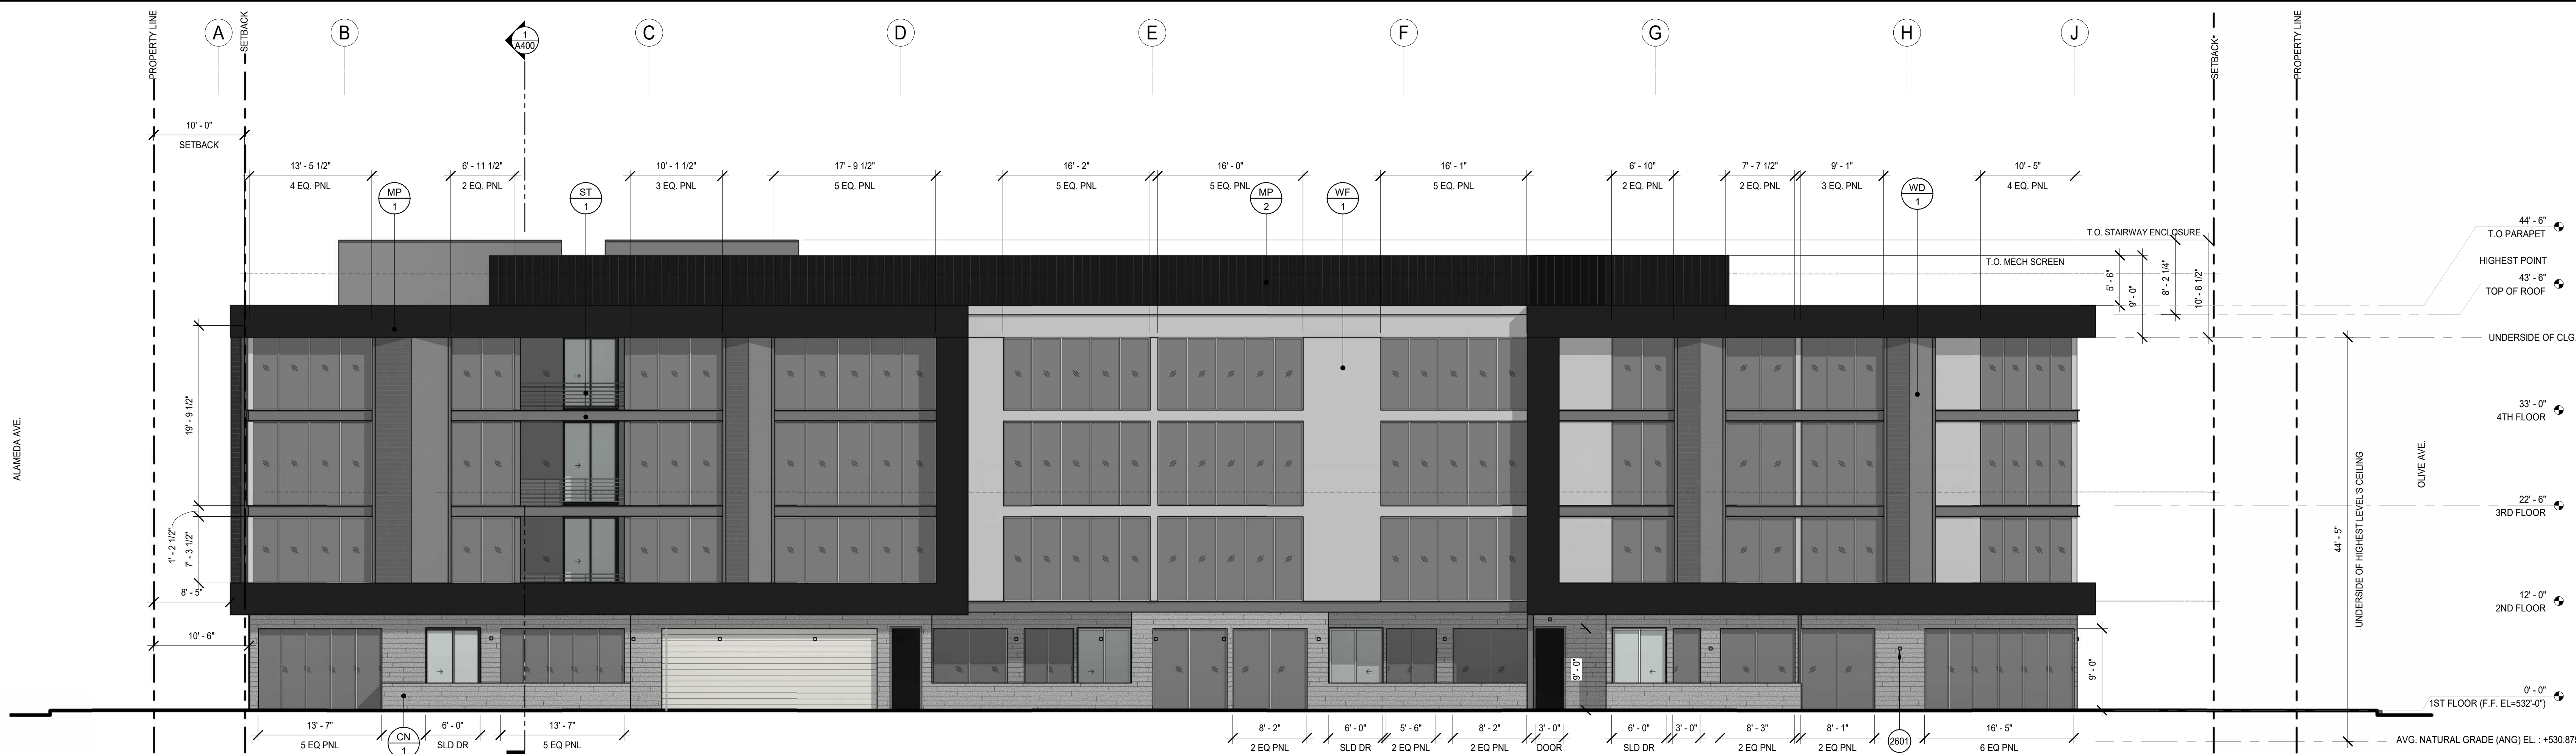

2 WEST ELEVATION (LIMA ST.)

SCALE
1/8" = 1'-0"

2

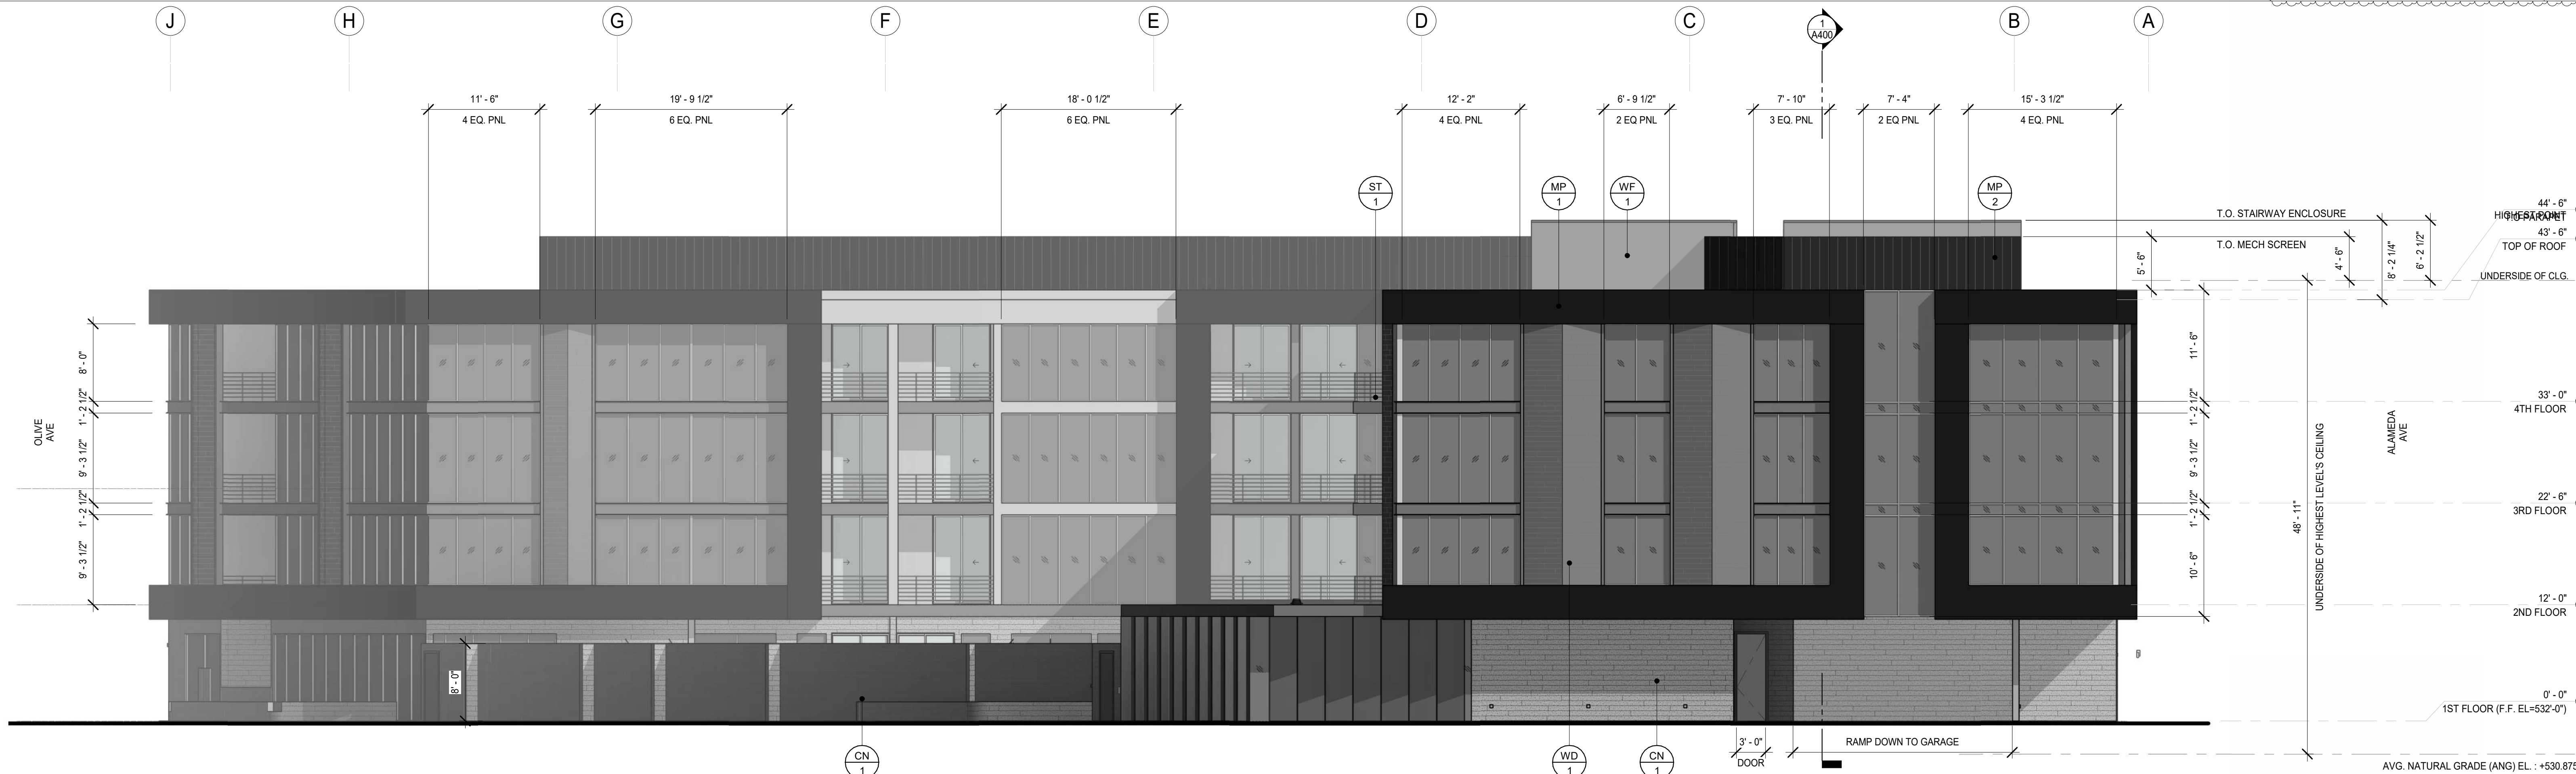

2 EAST ELEVATION (CALIFORNIA ST.)

1/8" = 1'-0"

1

MATERIAL FINISHES

FINISH NO.	DESCRIPTION	MANUFACTURER	SPECIFICATION	LOCATION	NOTES
CN-1	CONCRETE	-	BOARD-FORMED CONCRETE	SEE FINISH ELEVATION	DAVIS COLORS, DARK GREY (CARBON) 8084
MP-1	METAL PANEL	ALUMABOARD	ALUMABOARD FW-10, CHARCOAL	SEE FINISH ELEVATION	-
MP-2	METAL PANEL	METAL SALES	TLC-1, 22 GA. FLAT SEAM METAL PANEL	SEE FINISH ELEVATION	COLOR TO MATCH PT-1
ST-1	STEEL	-	STEEL BARSTOCK HANDRAIL	SEE FINISH ELEVATION	COLOR TO MATCH PT-2
WD-1	WOOD COMPOSITE PANEL	TRESPA	METEON-LIFT BROWN	SEE FINISH ELEVATION	-
WF-1	WALL FINISH	EIFS	EIFS, PAINTED	SEE FINISH ELEVATION	PAINTED PT-1

KEYNOTES

2B01 (N) EXTERIOR WALL MOUNTED LIGHTING BY SISTEMALUX OR EQUIV.

GENERAL NOTES

- (N) EXTERIOR GLAZING SYSTEMS BY ARCADIA OR EQUIV. MFR.
- (N) EXTERIOR WINDOW SYSTEMS BY ARCADIA OR EQUIV. MFR.
- (N) EXTERIOR DOOR SYSTEMS BY ARCADIA OR EQUIV. MFR.
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ARCADIA ACOUSTIC GLAZING PRODUCTS, T237 STC 43 DOUBLE GLAZED WITH OUTBOARD GLASS 1/2" THK AIR SPACE OF 1/2", 1/4" INSBOARD GLAZING.

LEGEND


ABBREVIATION	FINISH TYPE
B	BASE FINISH
C	CARPET
GL	GLASS
P	PAINT
PL	PLASTIC LAMINATE
SC	SEALED CONCRETE
SDT	STATIC DISSIPATIVE TILE
SS	SOLID SURFACING
SST	STAINLESS STEEL
ST	STONE
SV	SHEET VINYL
T	TILE
VT	VINYL TILE
VCOT	VINYL COMPOSITION TILE
W	WALL COVERING
WD	WOOD
WS	WAINSCOT
WT	WINDOW TREATMENT

NOT IN CONTRACT


ALIGN ELEMENTS

FINISH SYMBOL

GLAZING

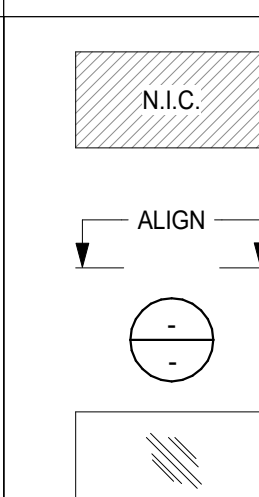

1. SEE SHEETS A003 AND A004 FOR GENERAL NOTES.

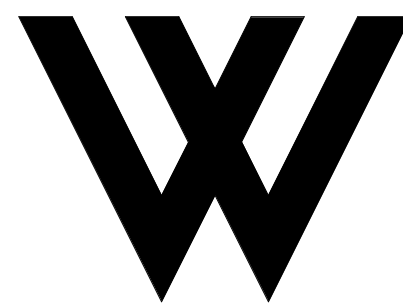

WOLCOTT
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PROJECT:

BOB HOPE CENTRAL -
RESIDENTIAL
3201 W OLIVE AVE.
BURBANK, CA 91505

FLOOR/LEVEL:

ISSUE OR REVISION NOTES:

NO.	DATE	DESCRIPTION
1	06.22.22	PLANNING DEVELOPMENT STANDARDS SUBMITTAL
2	10.01.22	BURBANK PLANNING COMMENTS
2	06.22.2023	PLANNING DEVELOPMENT STANDARDS RESUBMITTAL

2

CLIENT SIGNATURE:

SIGNATURE: DATE: -

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PROJECT NO: 21-2779-1

DRAWN BY: RM, CS, GD CHECKED BY: SL

PROJECT MANAGER: CC

DRAWING SCALE: 1/8" = 1'-0"


SHEET SIZE: 30x42

DRAWING TITLE:

ENLARGED EXTERIOR
ELEVATIONS

SHEET NO:


A303

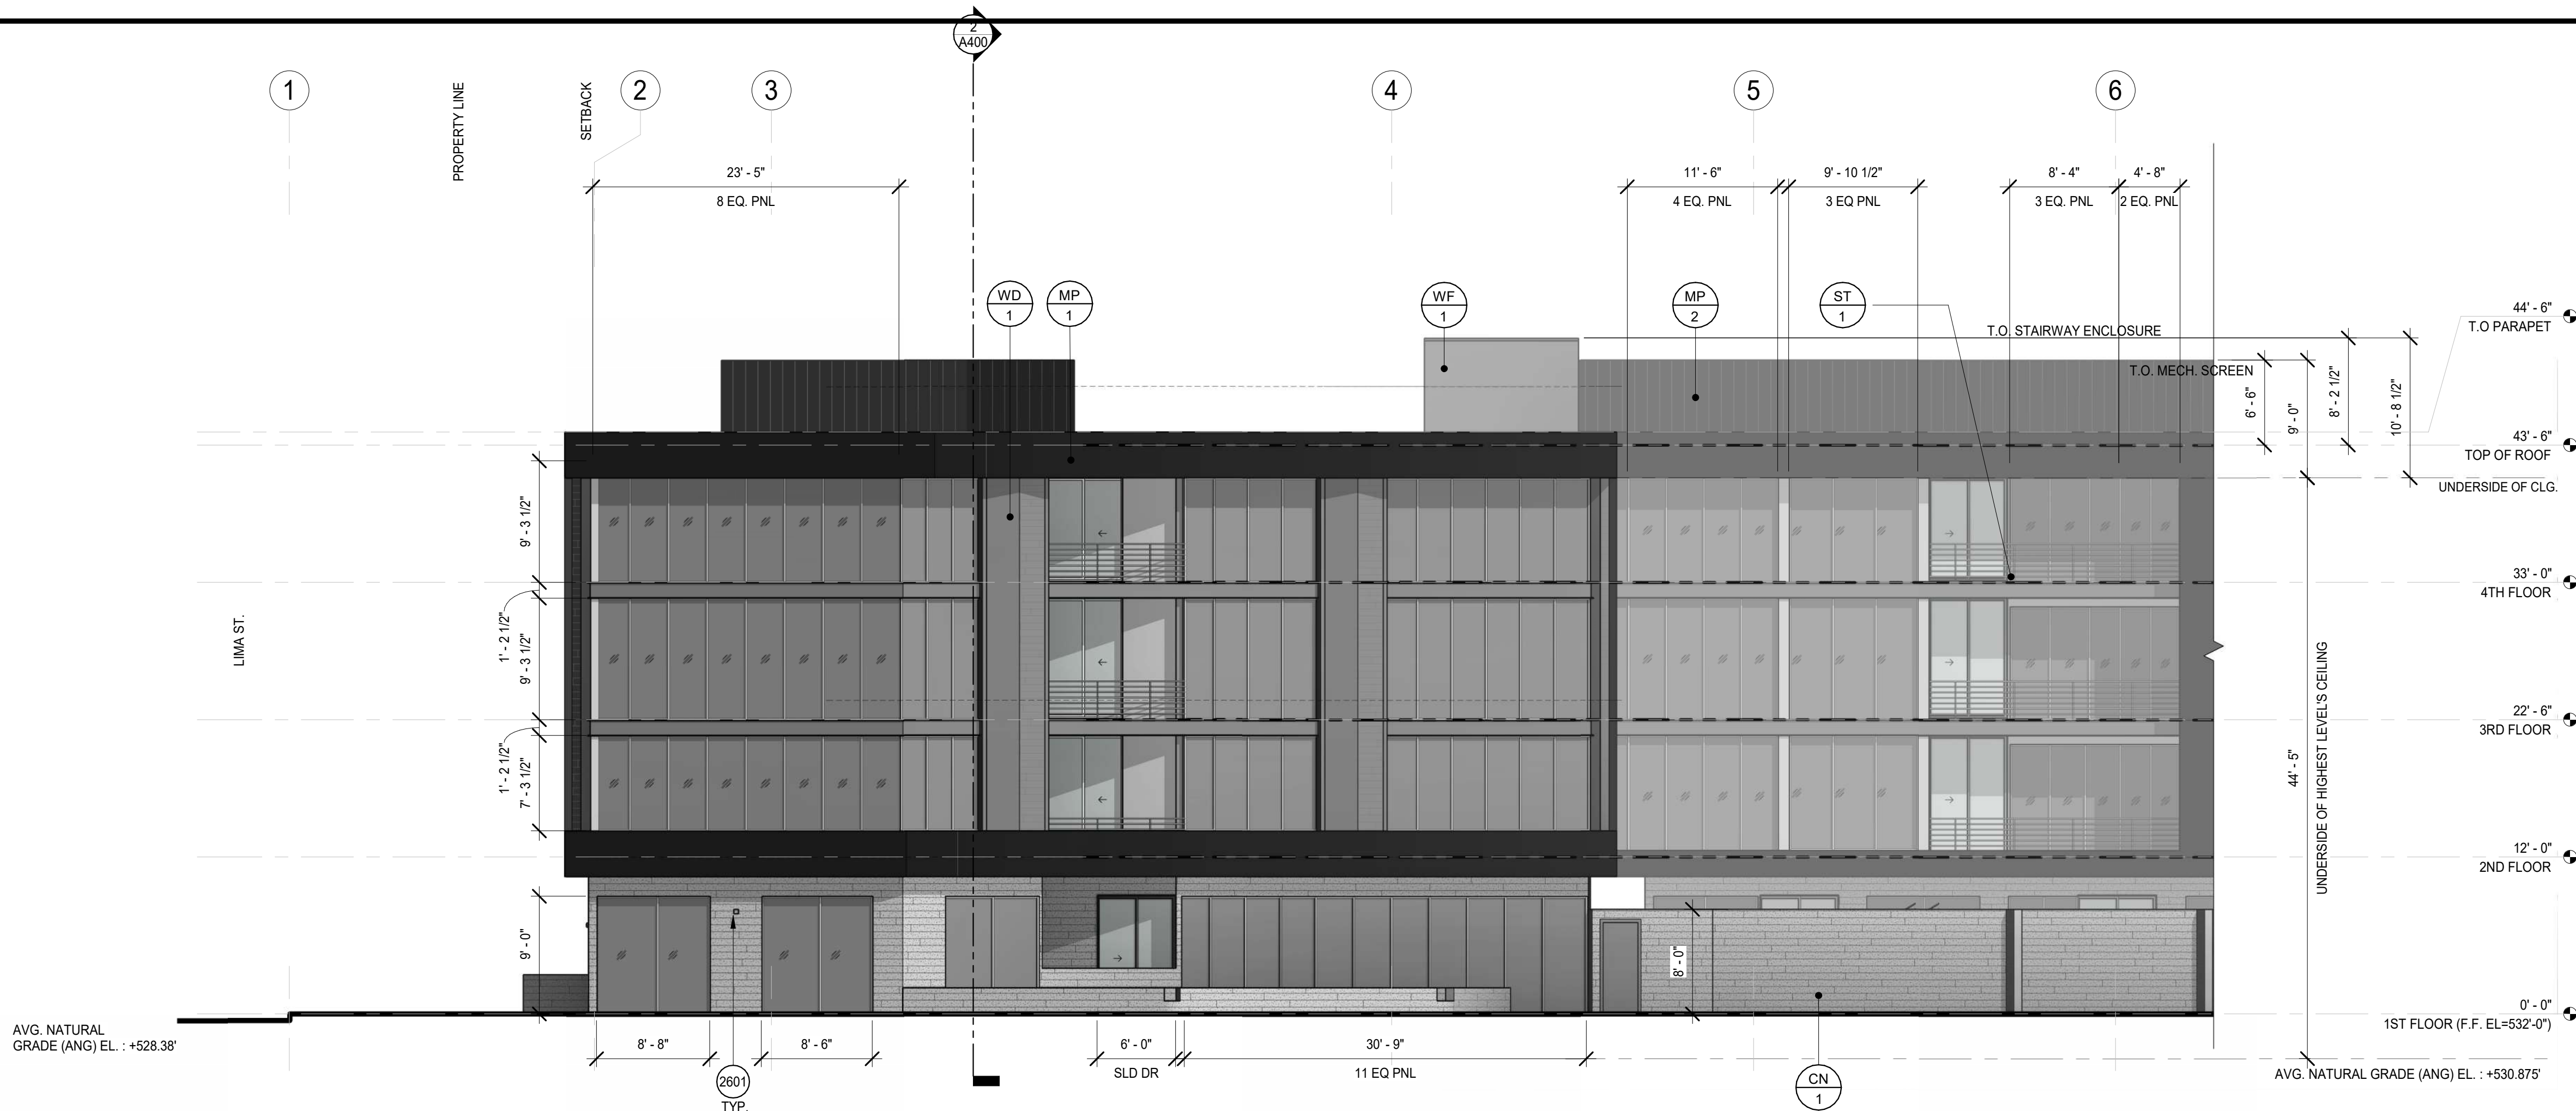

2 SOUTH ELEVATION (W. OLIVE AVE.)

SCALE
1/8" = 1'-0"

2

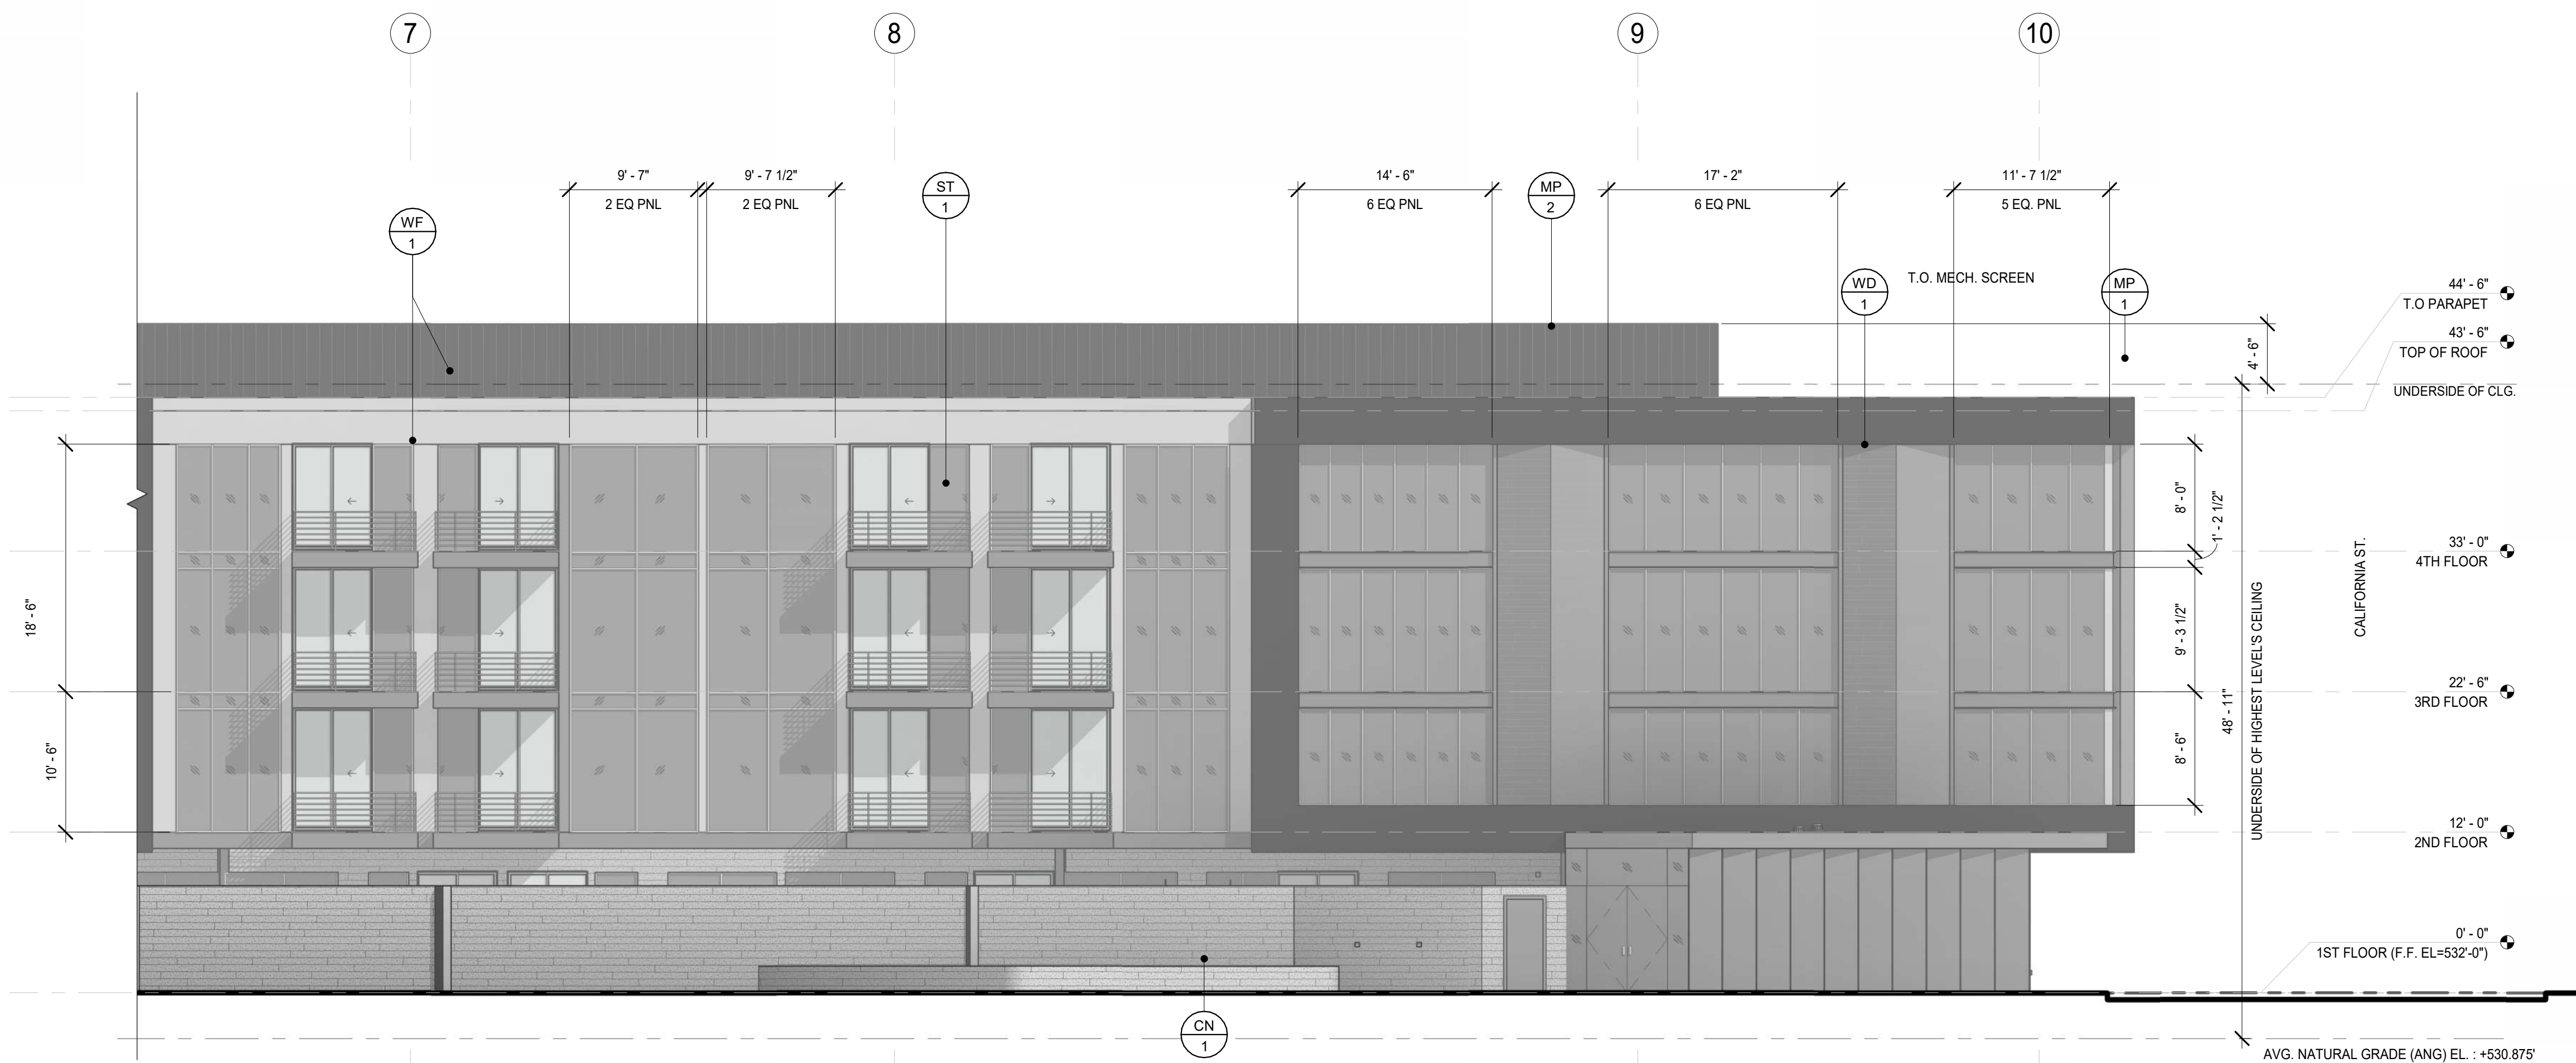

2 SOUTH ELEVATION (W. OLIVE AVE.)

1/8" = 1'-0"

1

MATERIAL FINISHES

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CN-1	CONCRETE	-	BOARD-FORMED CONCRETE	SEE FINISH ELEVATION	DAVIS COLORS, DARK GREY (CARBON) 8084
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WD-1	WOOD COMPOSITE PANEL	TRESPA	METEON-LOFT BROWN	SEE FINISH ELEVATION	-
WF-1	WALL FINISH	EIFS	EIFS, PAINTED	SEE FINISH ELEVATION	PAINTED PT-1

KEYNOTES

2801 (N) EXTERIOR WALL MOUNTED LIGHTING BY SISTEMALUX OR EQUIV.

GENERAL NOTES

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LEGEND

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GL	GLASS
P	PAINT
PL	PLASTIC LAMINATE
SC	SEALED CONCRETE
SDT	STATIC DISSIPATIVE TILE
SS	SOLID SURFACING
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T	TILE
VT	VINYL TILE
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W	WALL COVERING
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WT	WAINSCOT
WT	WINDOW TREATMENT

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PROJECT:

BOB HOPE CENTRAL -
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FLOOR/LEVEL:

ISSUE OR REVISION NOTES:

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PROJECT NO: 21-2779-1

DRAWN BY: RM, CS, GD CHECKED BY: SL

PROJECT MANAGER: CC

DRAWING SCALE: As indicated


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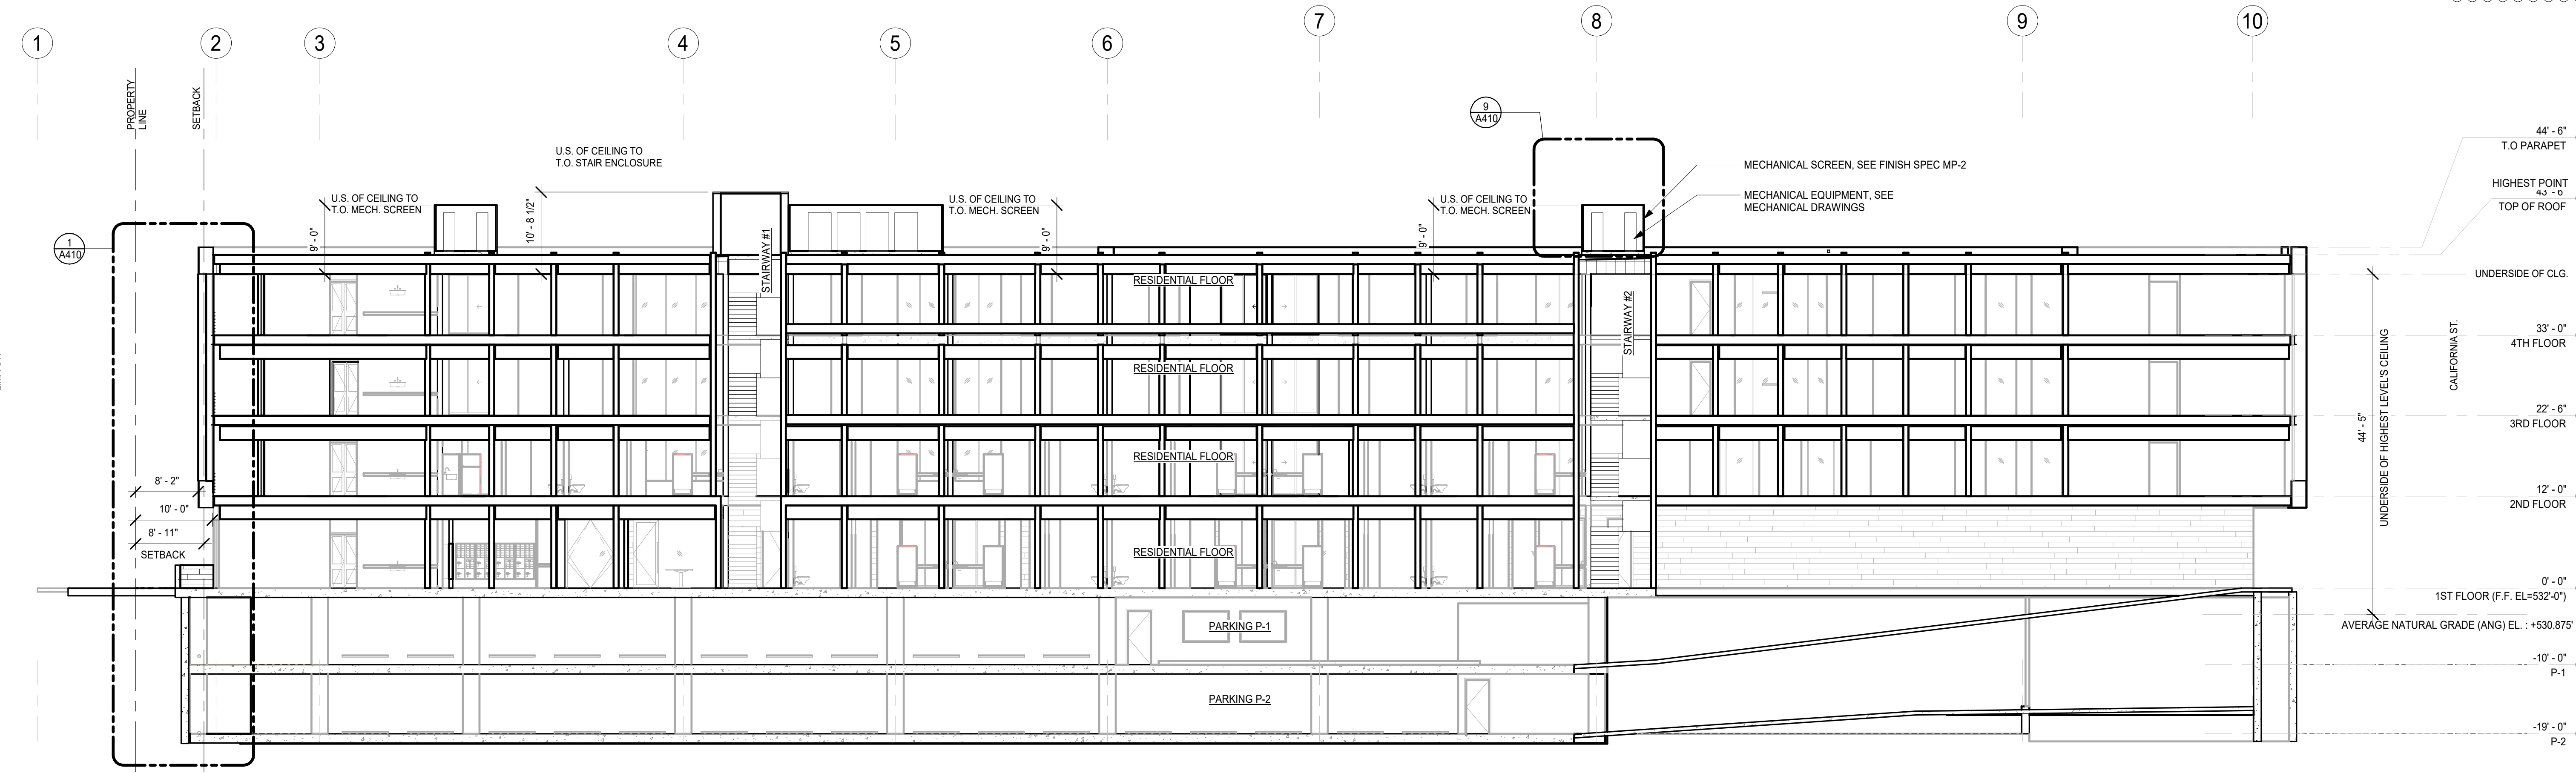
BUILDING SECTIONS

SHEET NO:

A400



2 NORTH-SOUTH SECTION 2
3/32" = 1'-0"

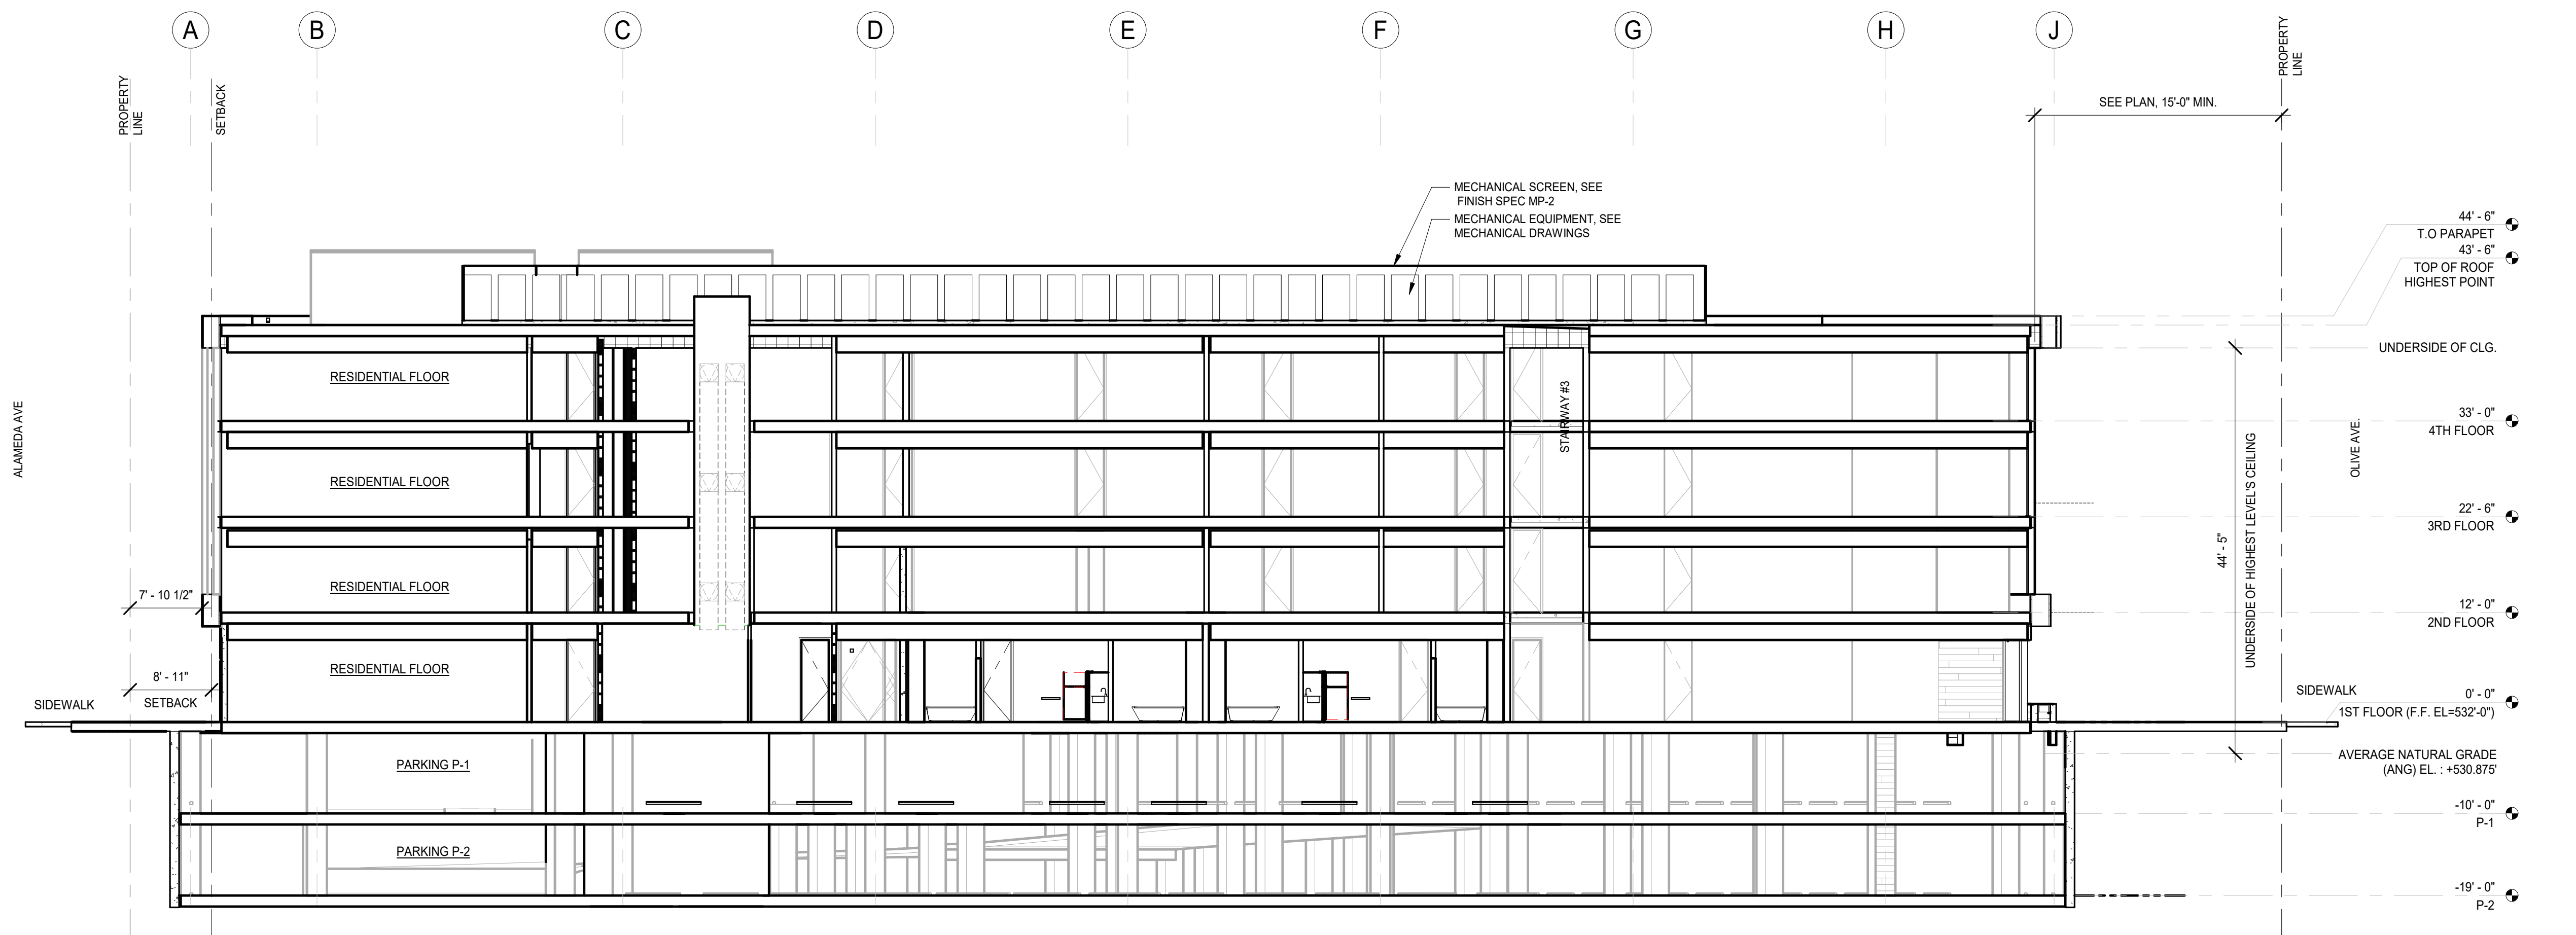

2 EAST-WEST SECTION 1
3/32" = 1'-0"

KEYNOTES


GENERAL NOTES

1. SEE SHEETS A003 AND A004 FOR GENERAL NOTES.

LEGEND

- N.I.C. NOT IN CONTRACT
- ALIGN ALIGN ELEMENTS
- MATERIAL MATERIAL
- MATERIAL MATERIAL
- MATERIAL MATERIAL


FILE NAME: Autodesk Docs\B22_BHC-Residential\21-2779-1_BobHopeCenter-Resi.rvt
DATE STAMP: 6/22/2023 2:34:03 PM

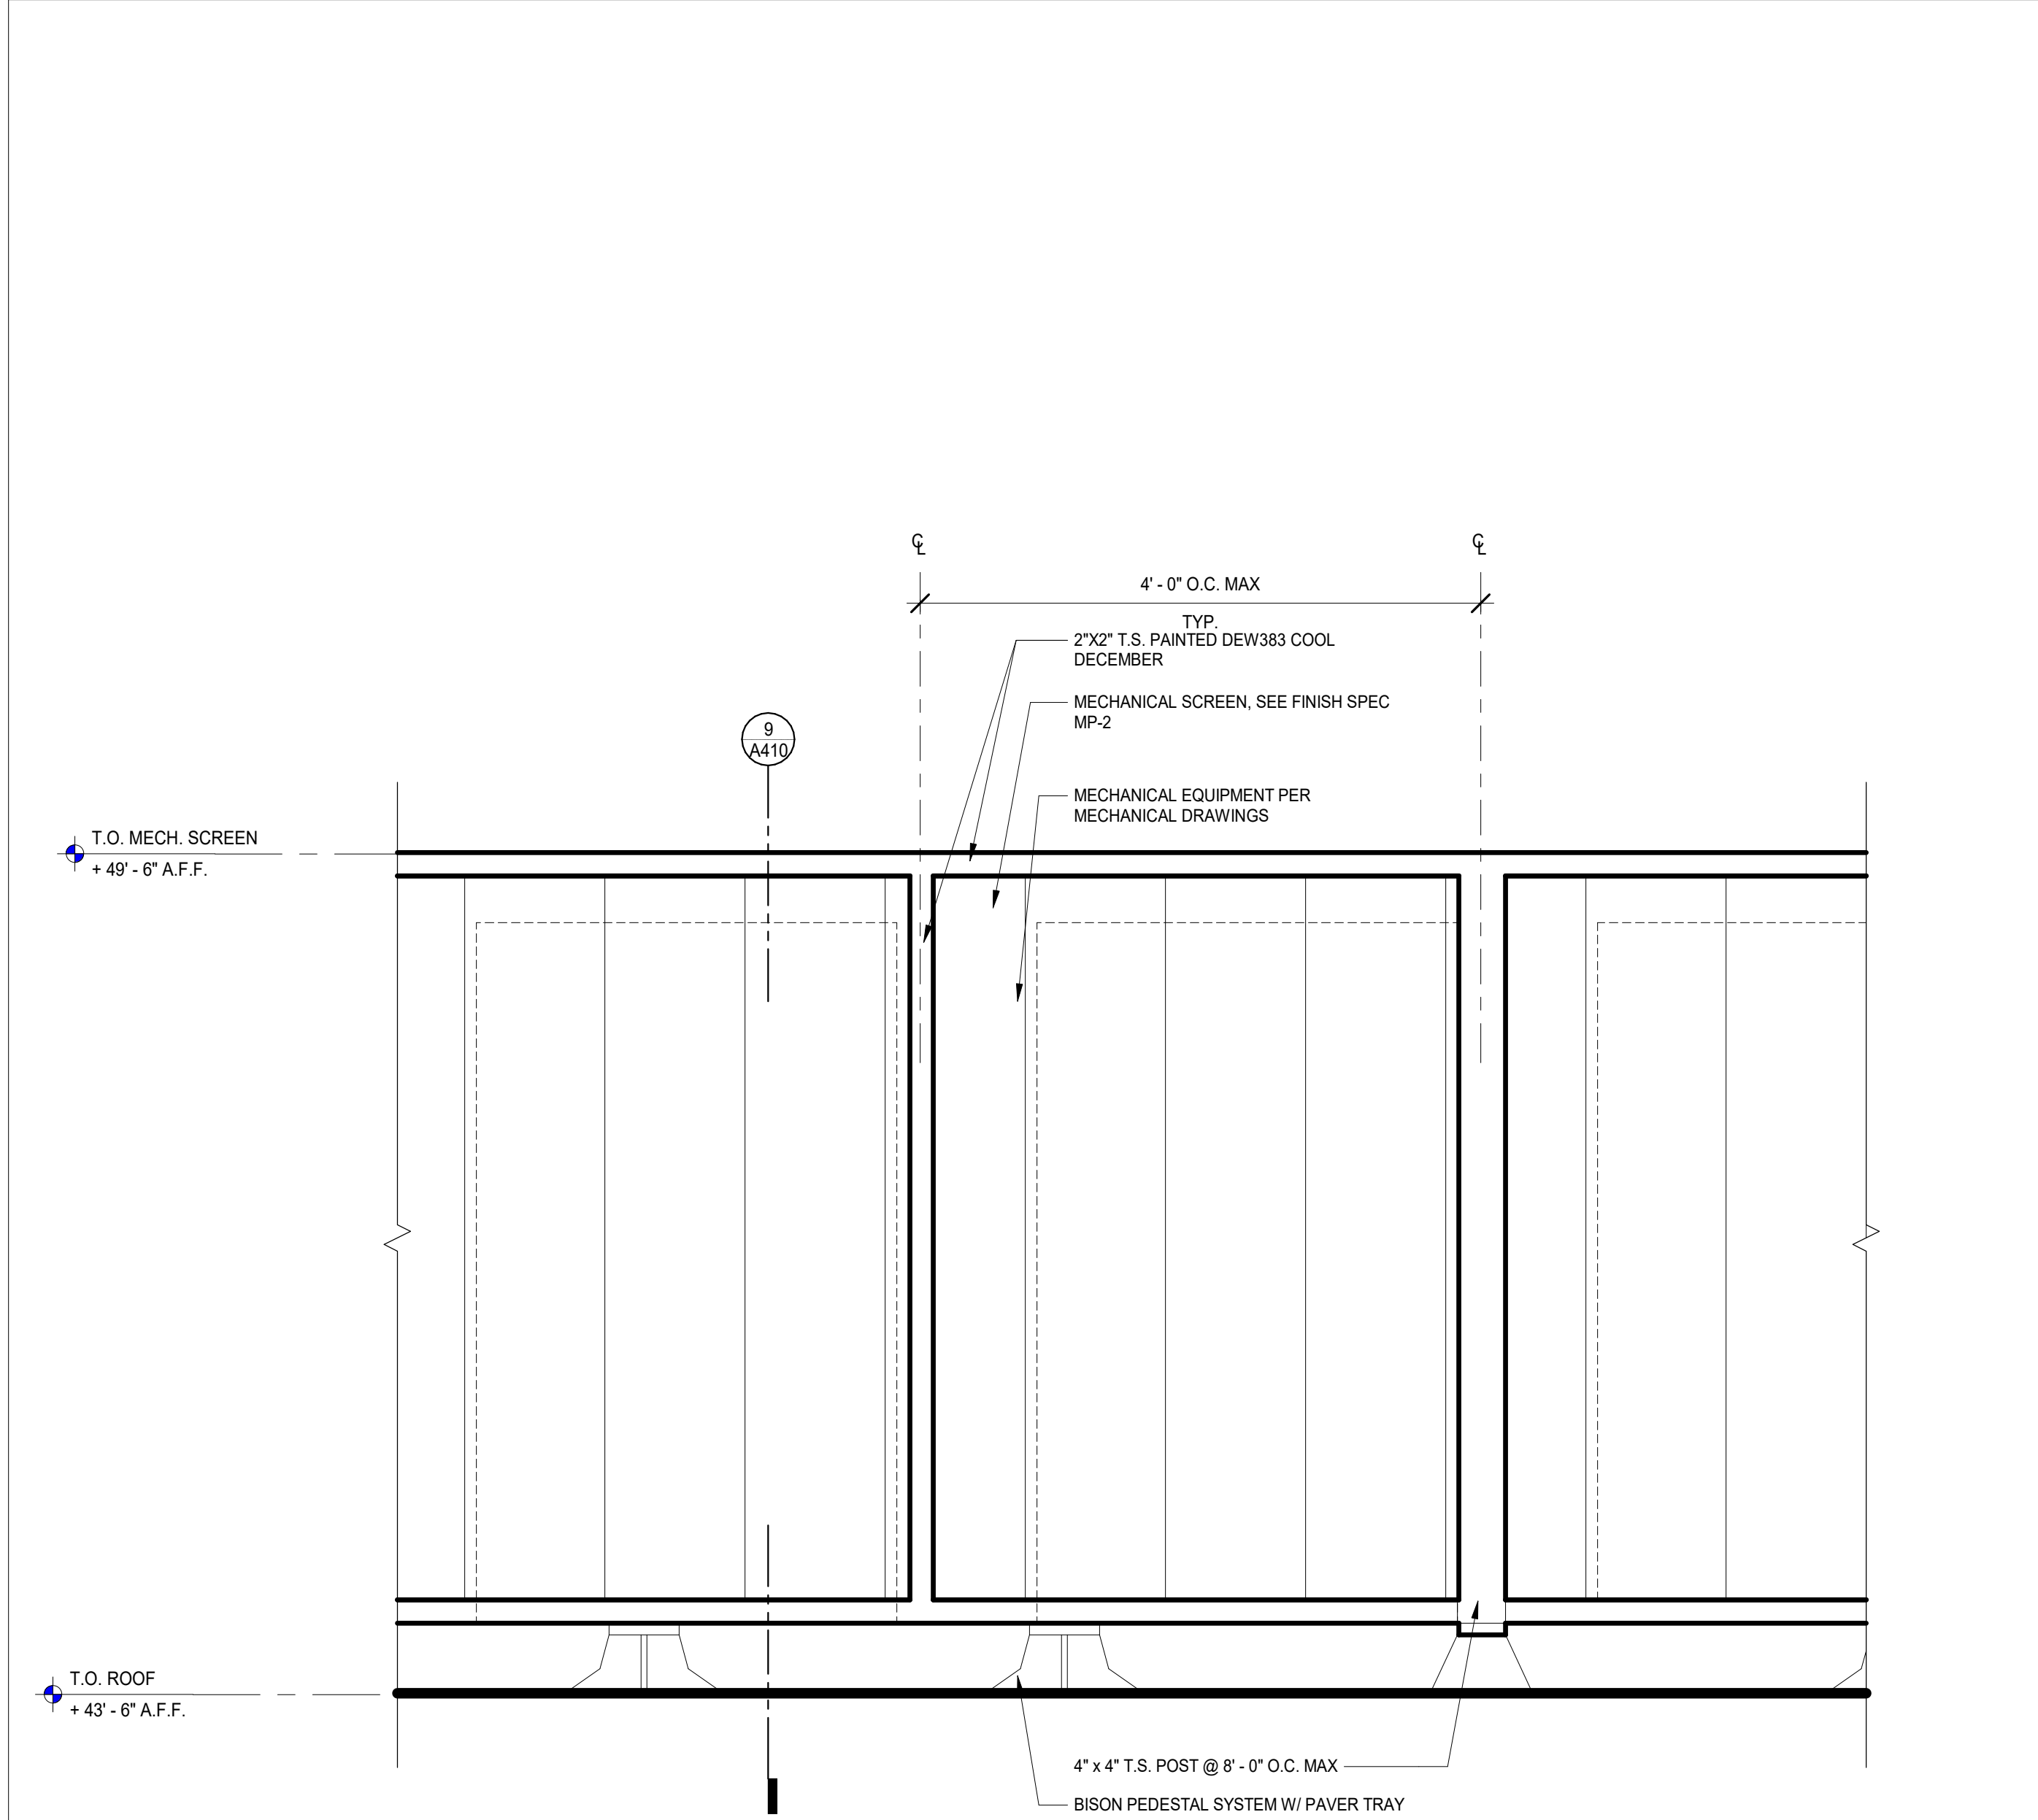

SECTION DETAIL @ MECHANICAL SCREEN

SCALE
1" = 1'-0"


13

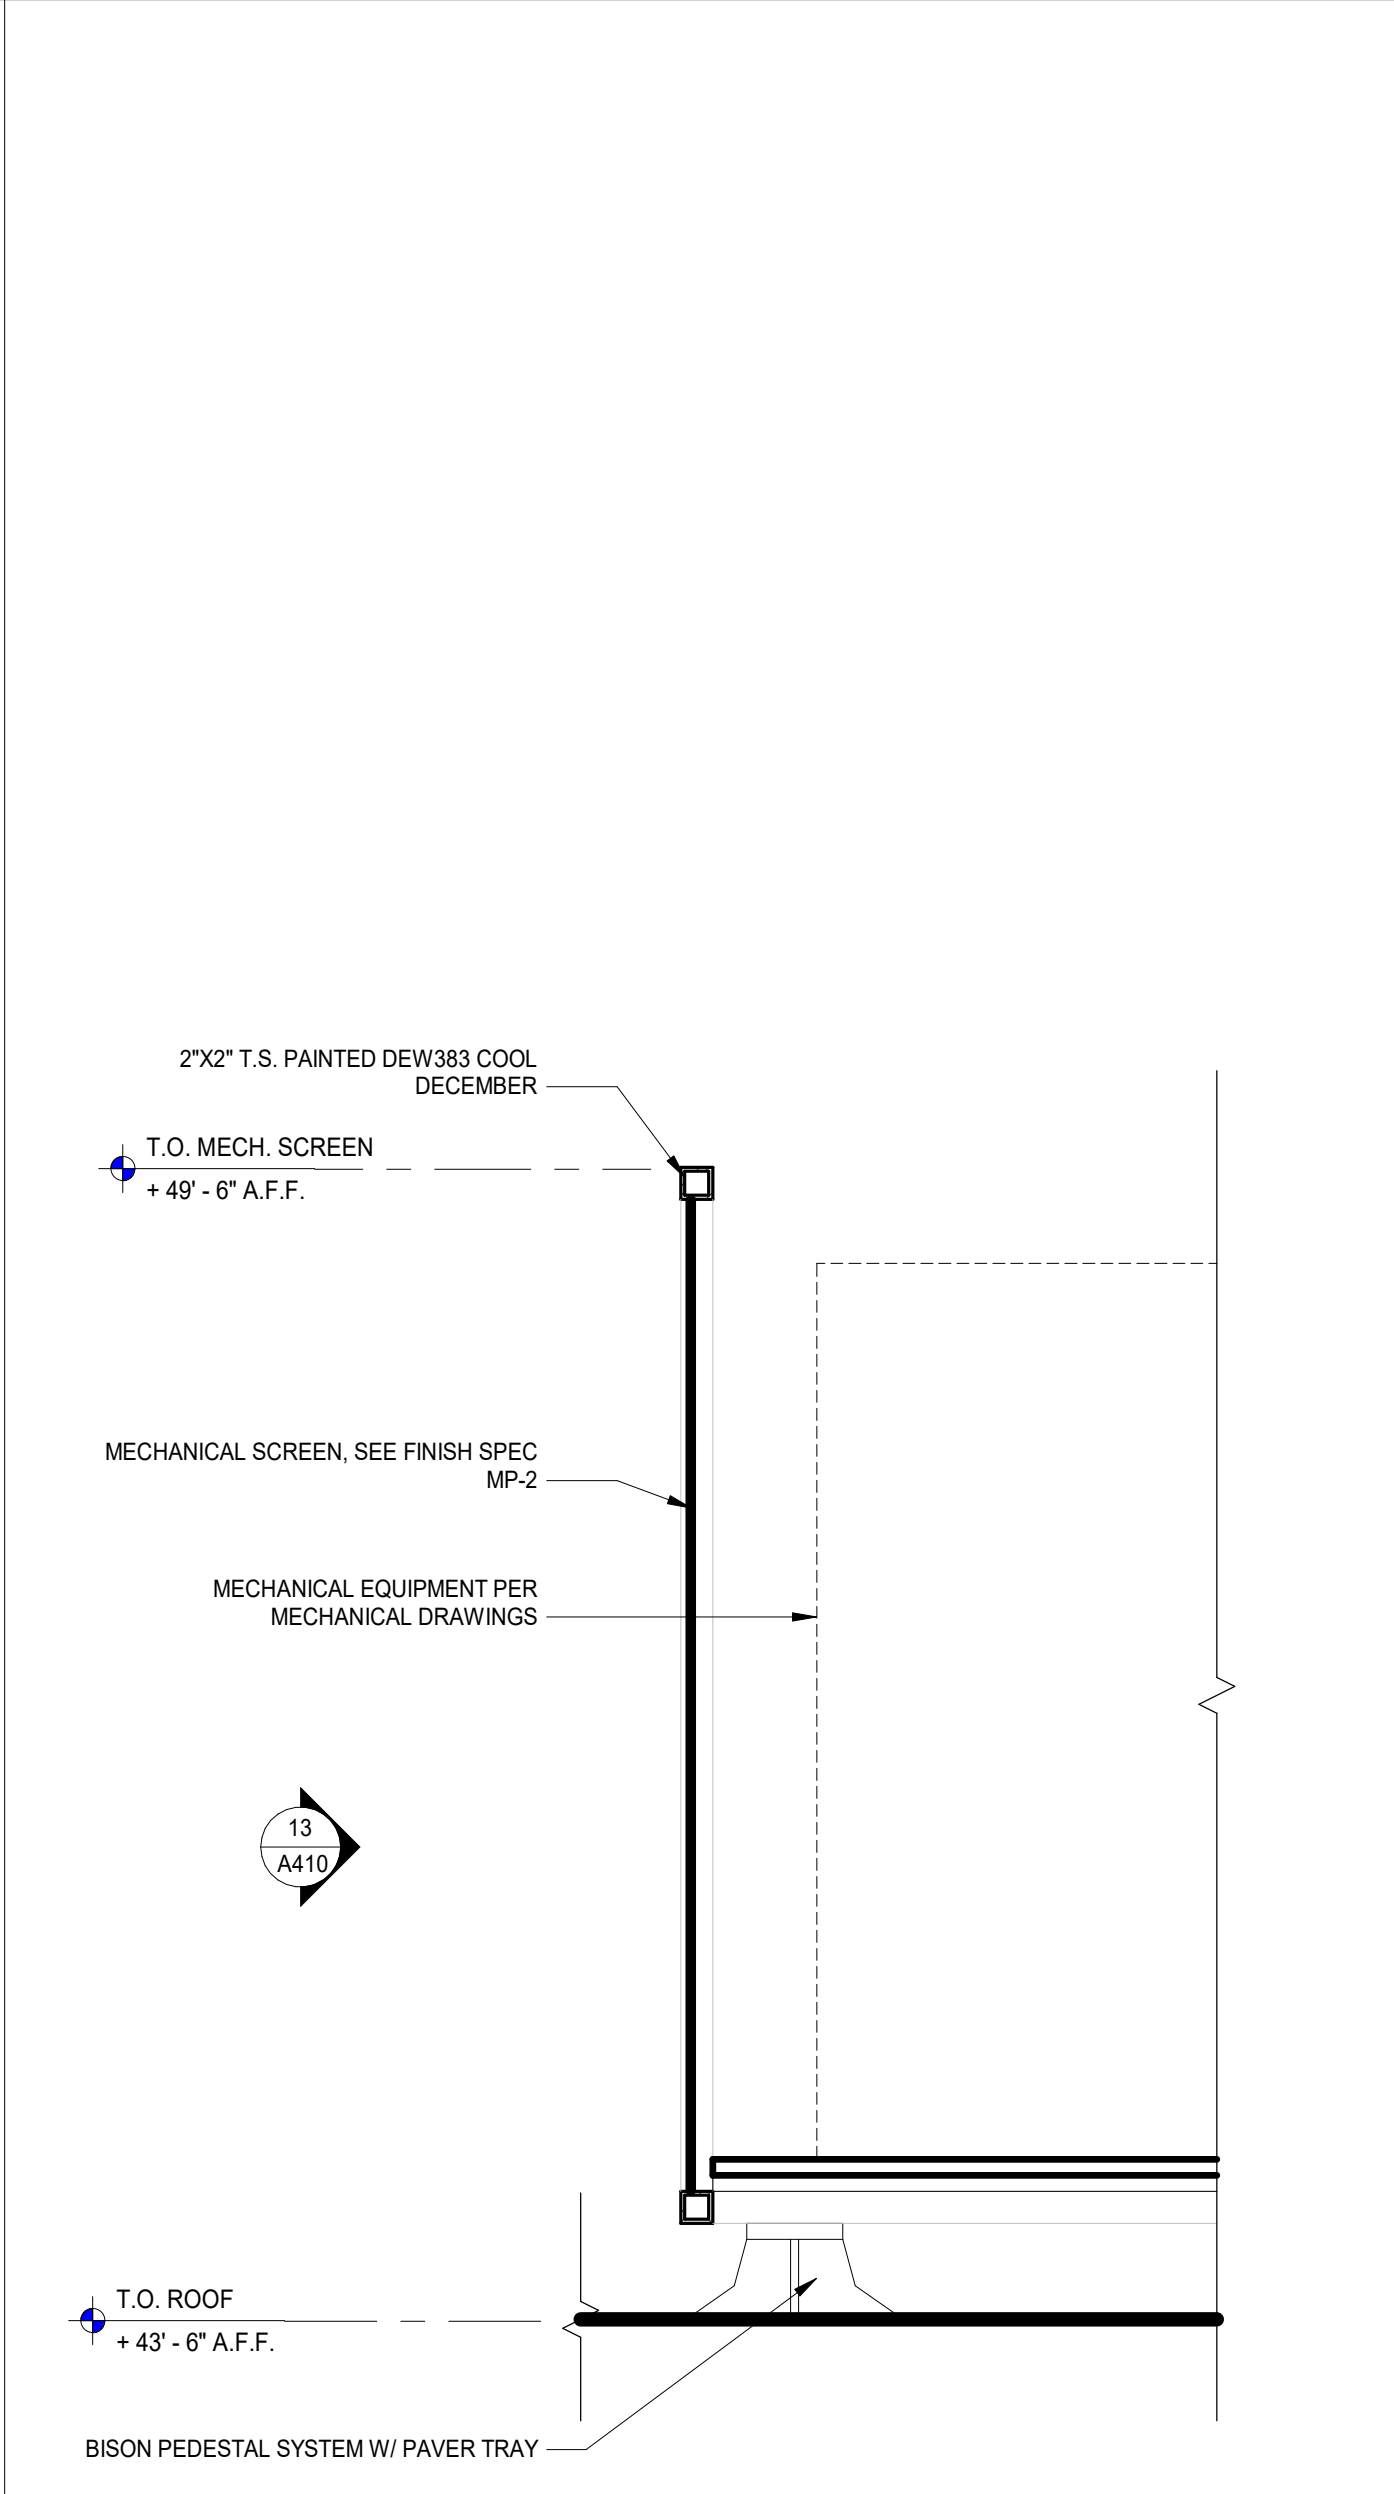

SECTION DETAIL @ MECH. SCREEN

SCALE
1" = 1'-0"

9

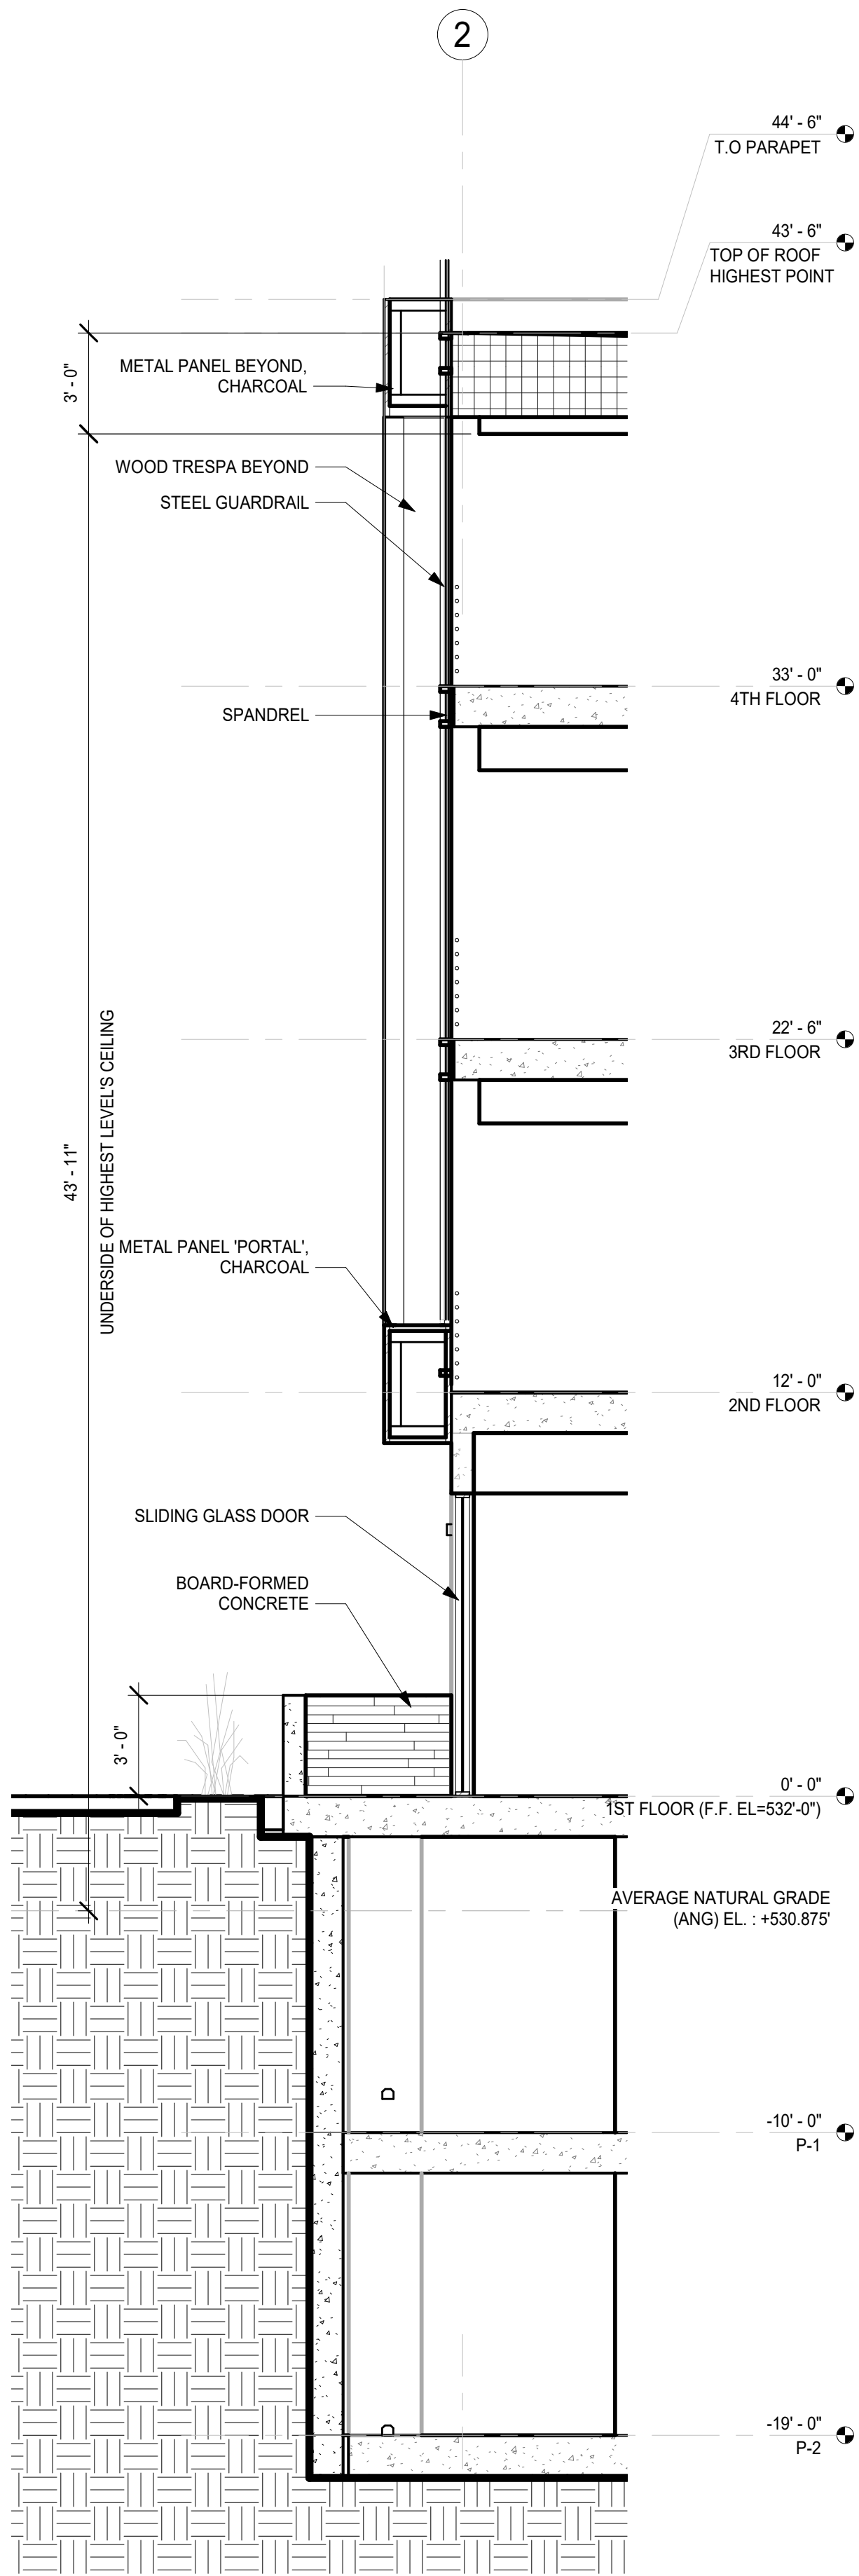

WALL SECTION @ GRID-LINE 2

SCALE
1/4" = 1'-0"

1



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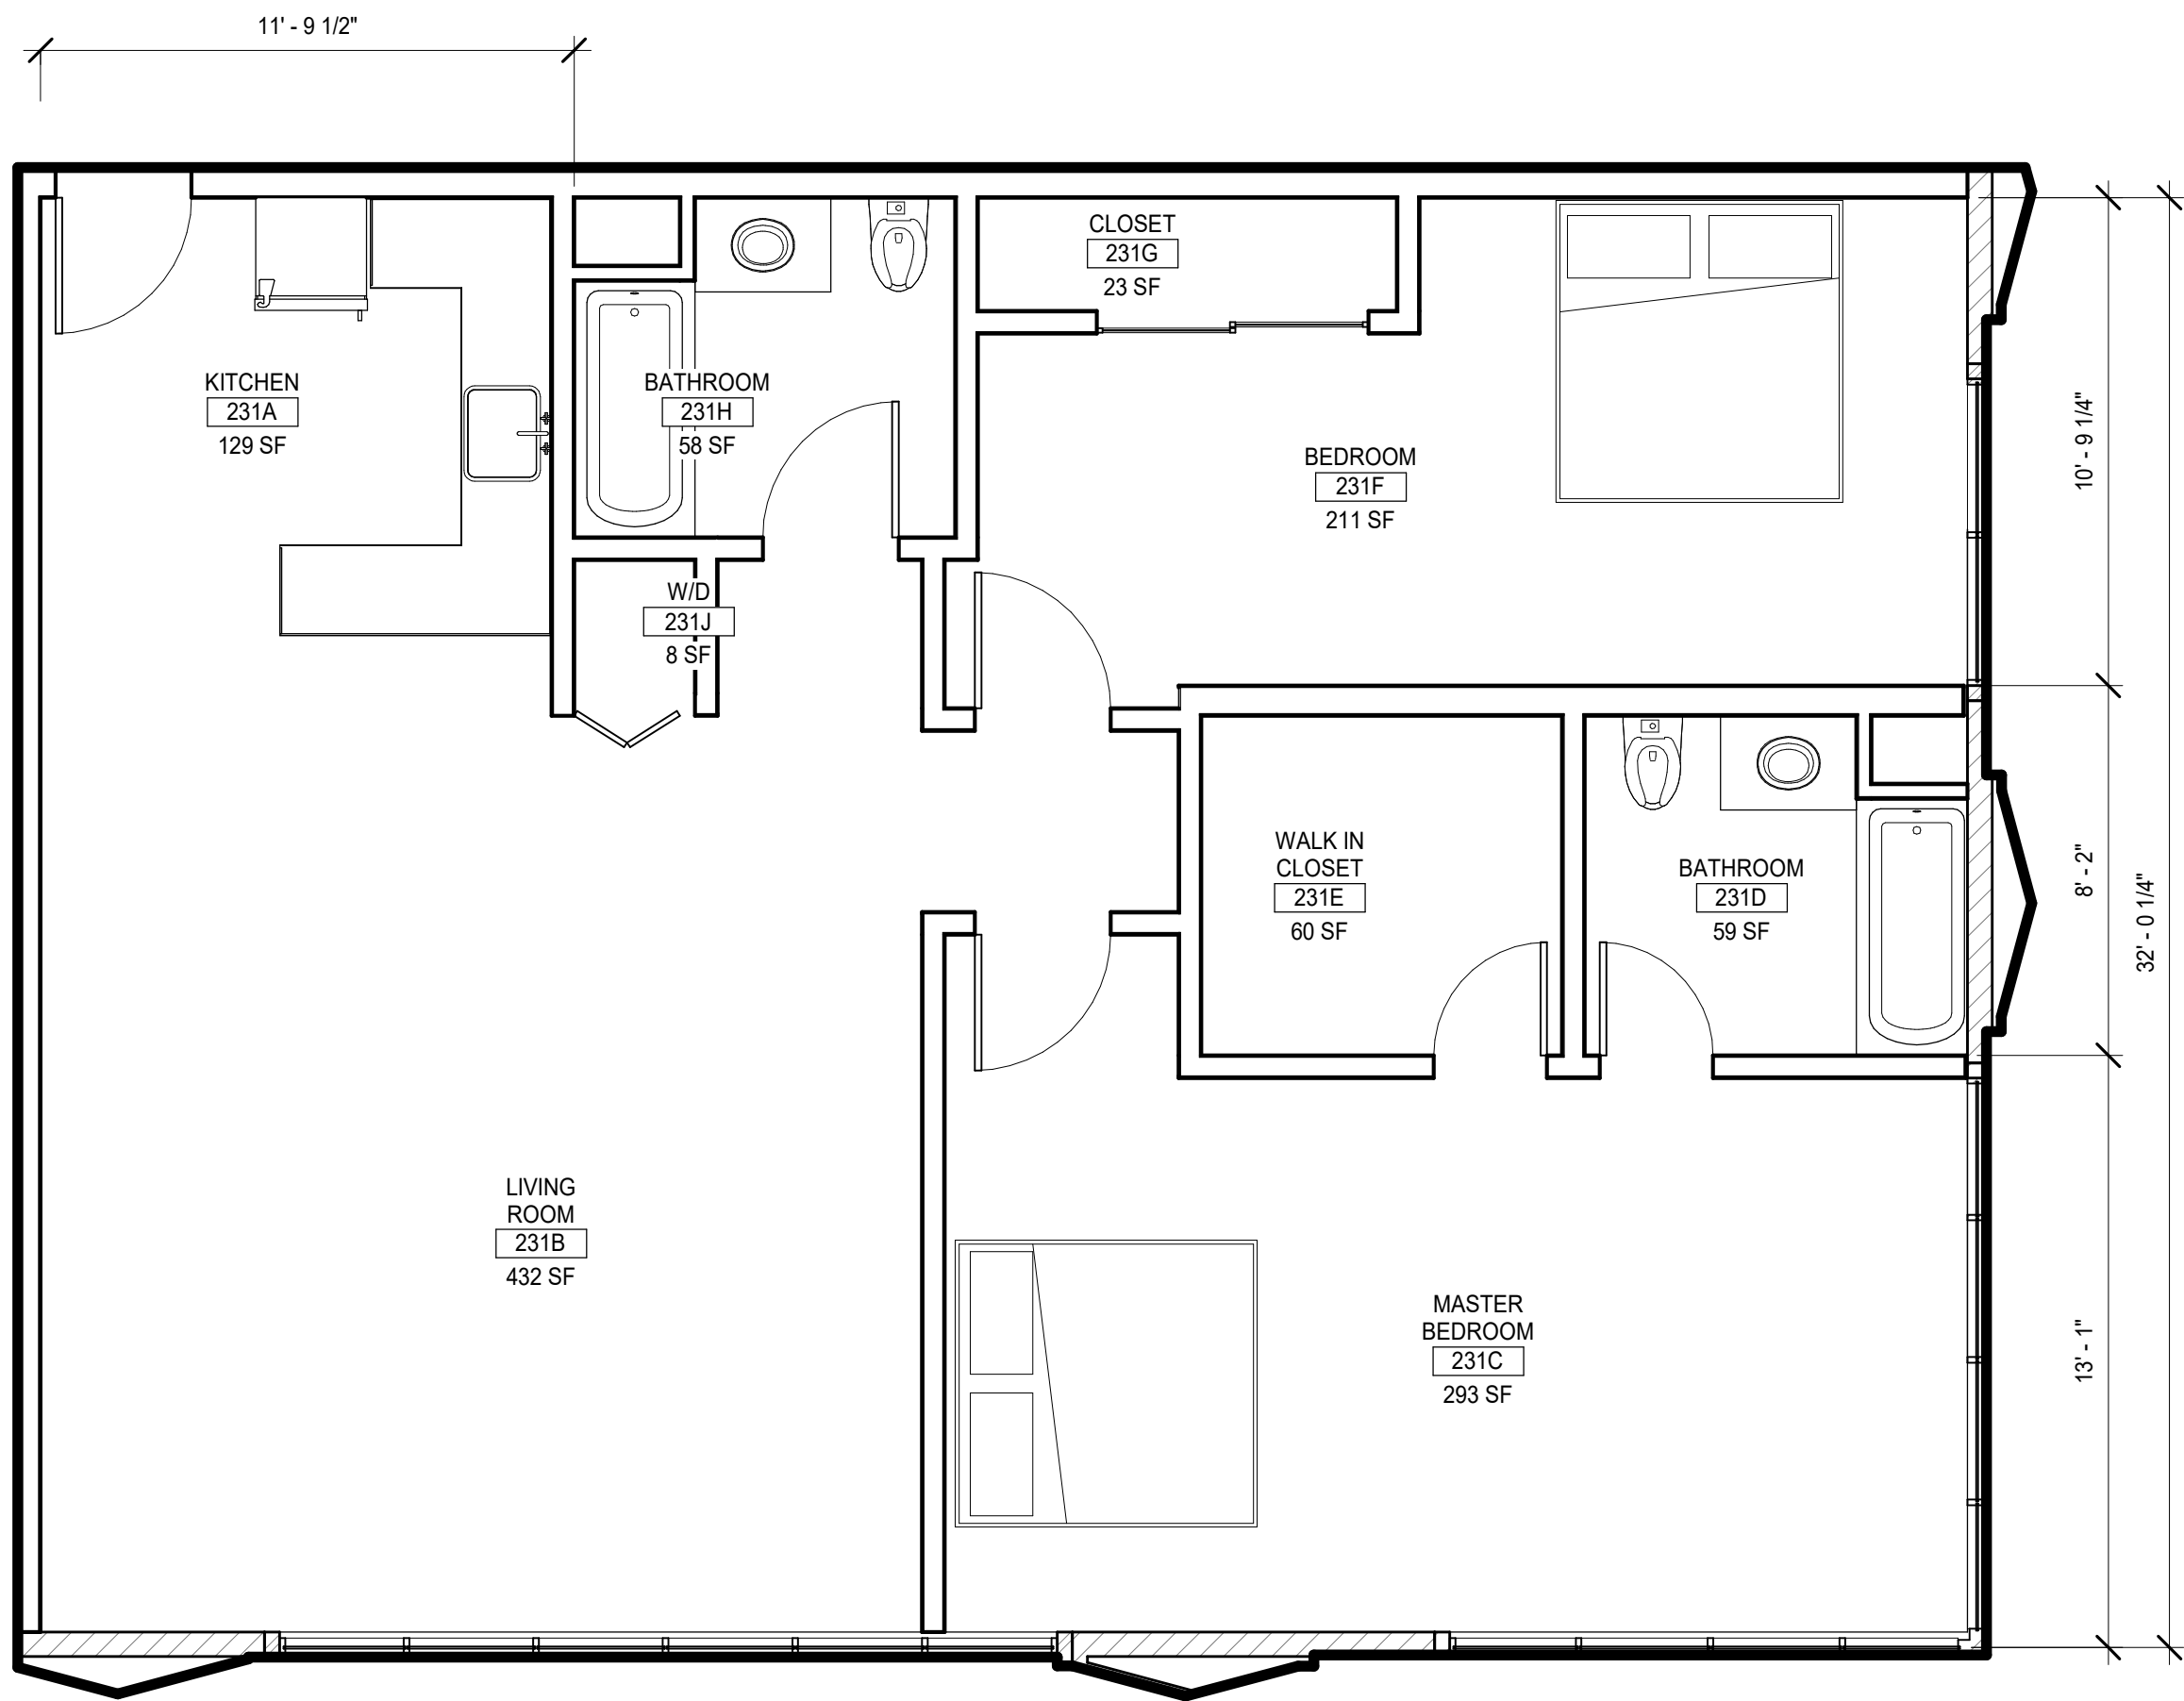
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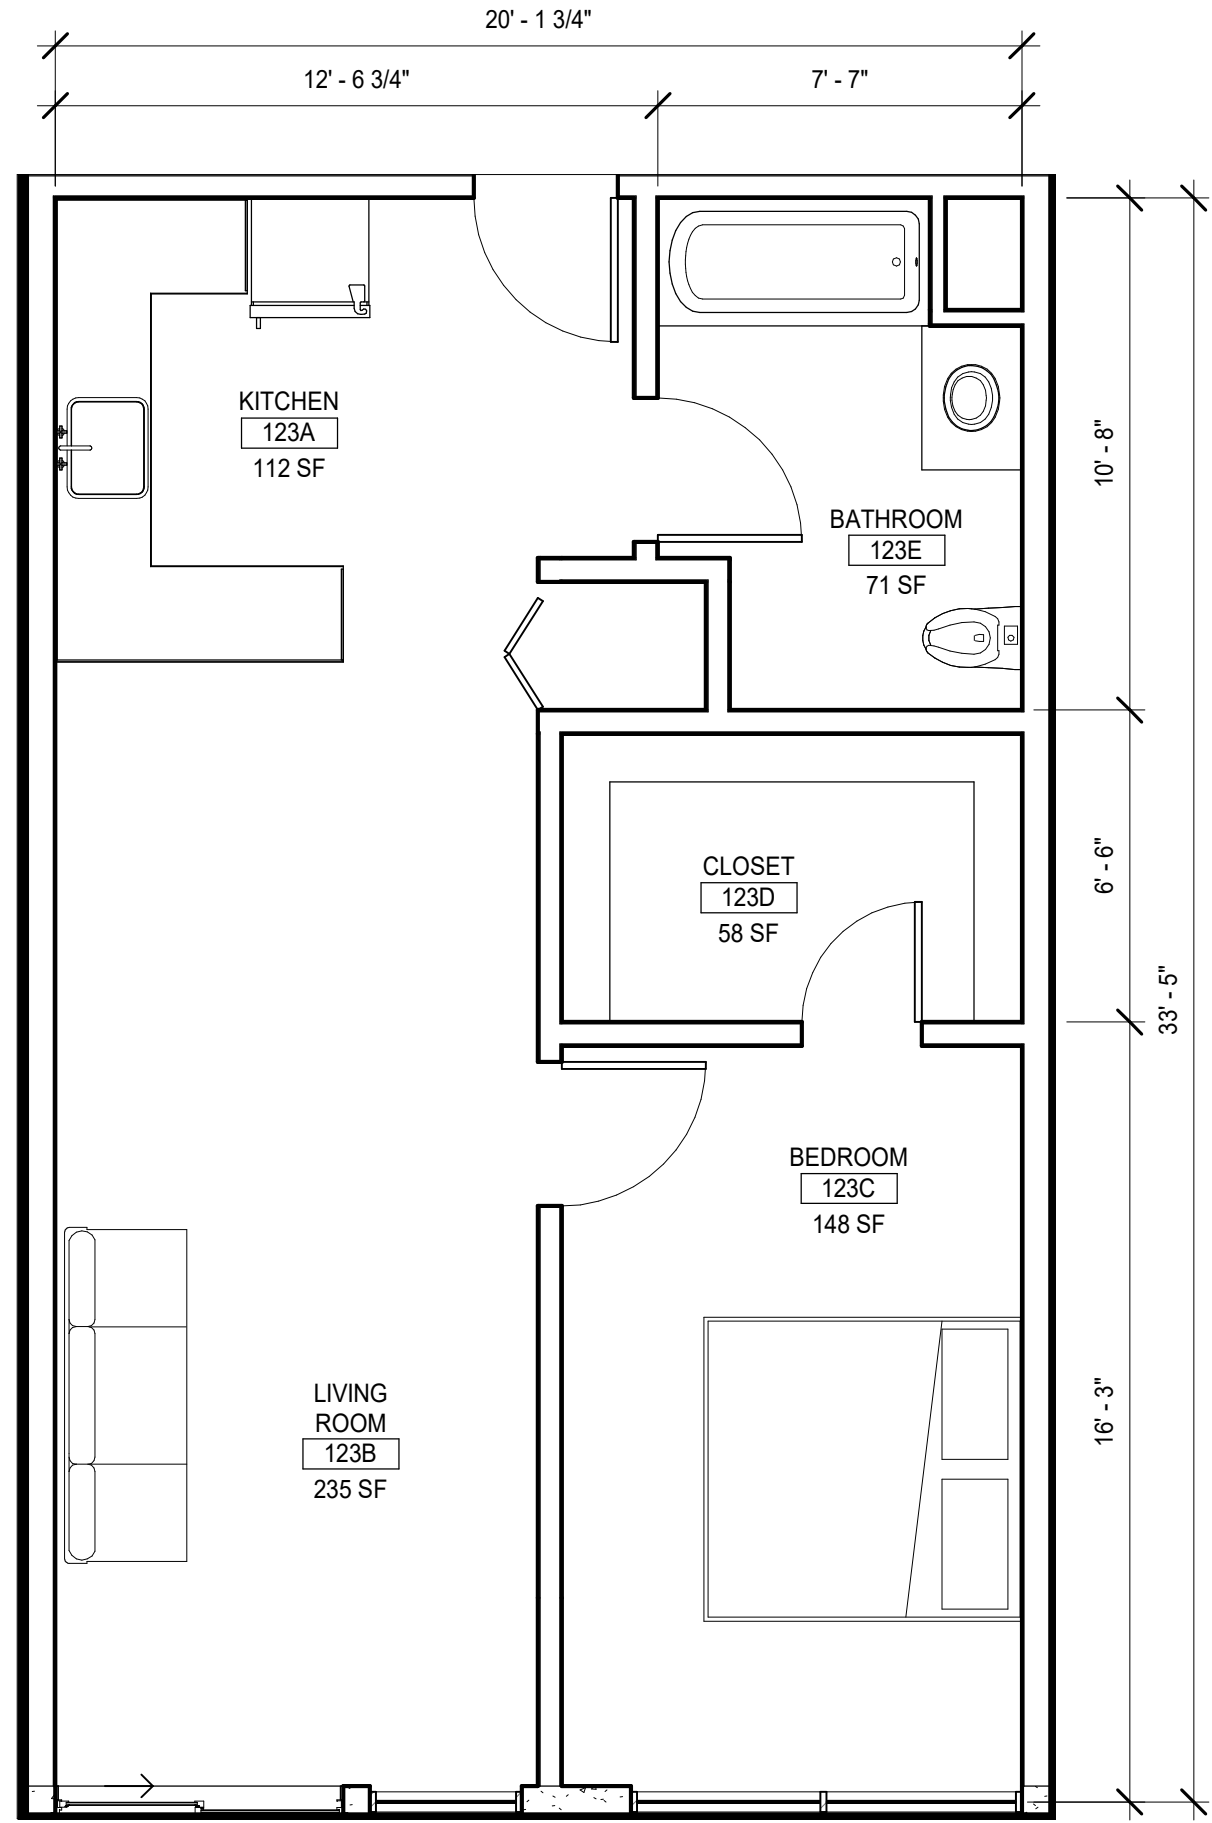
ENLARGED SECTIONS

SHEET NO:


A410




2 ENLARGED PLAN - TYP. 2-BED CORNER UNIT SCALE 1/4" = 1'-0" 7



3 ENLARGED PLAN - TYP. 1-BED FLOOR PLAN SCALE 1/4" = 1'-0" 3

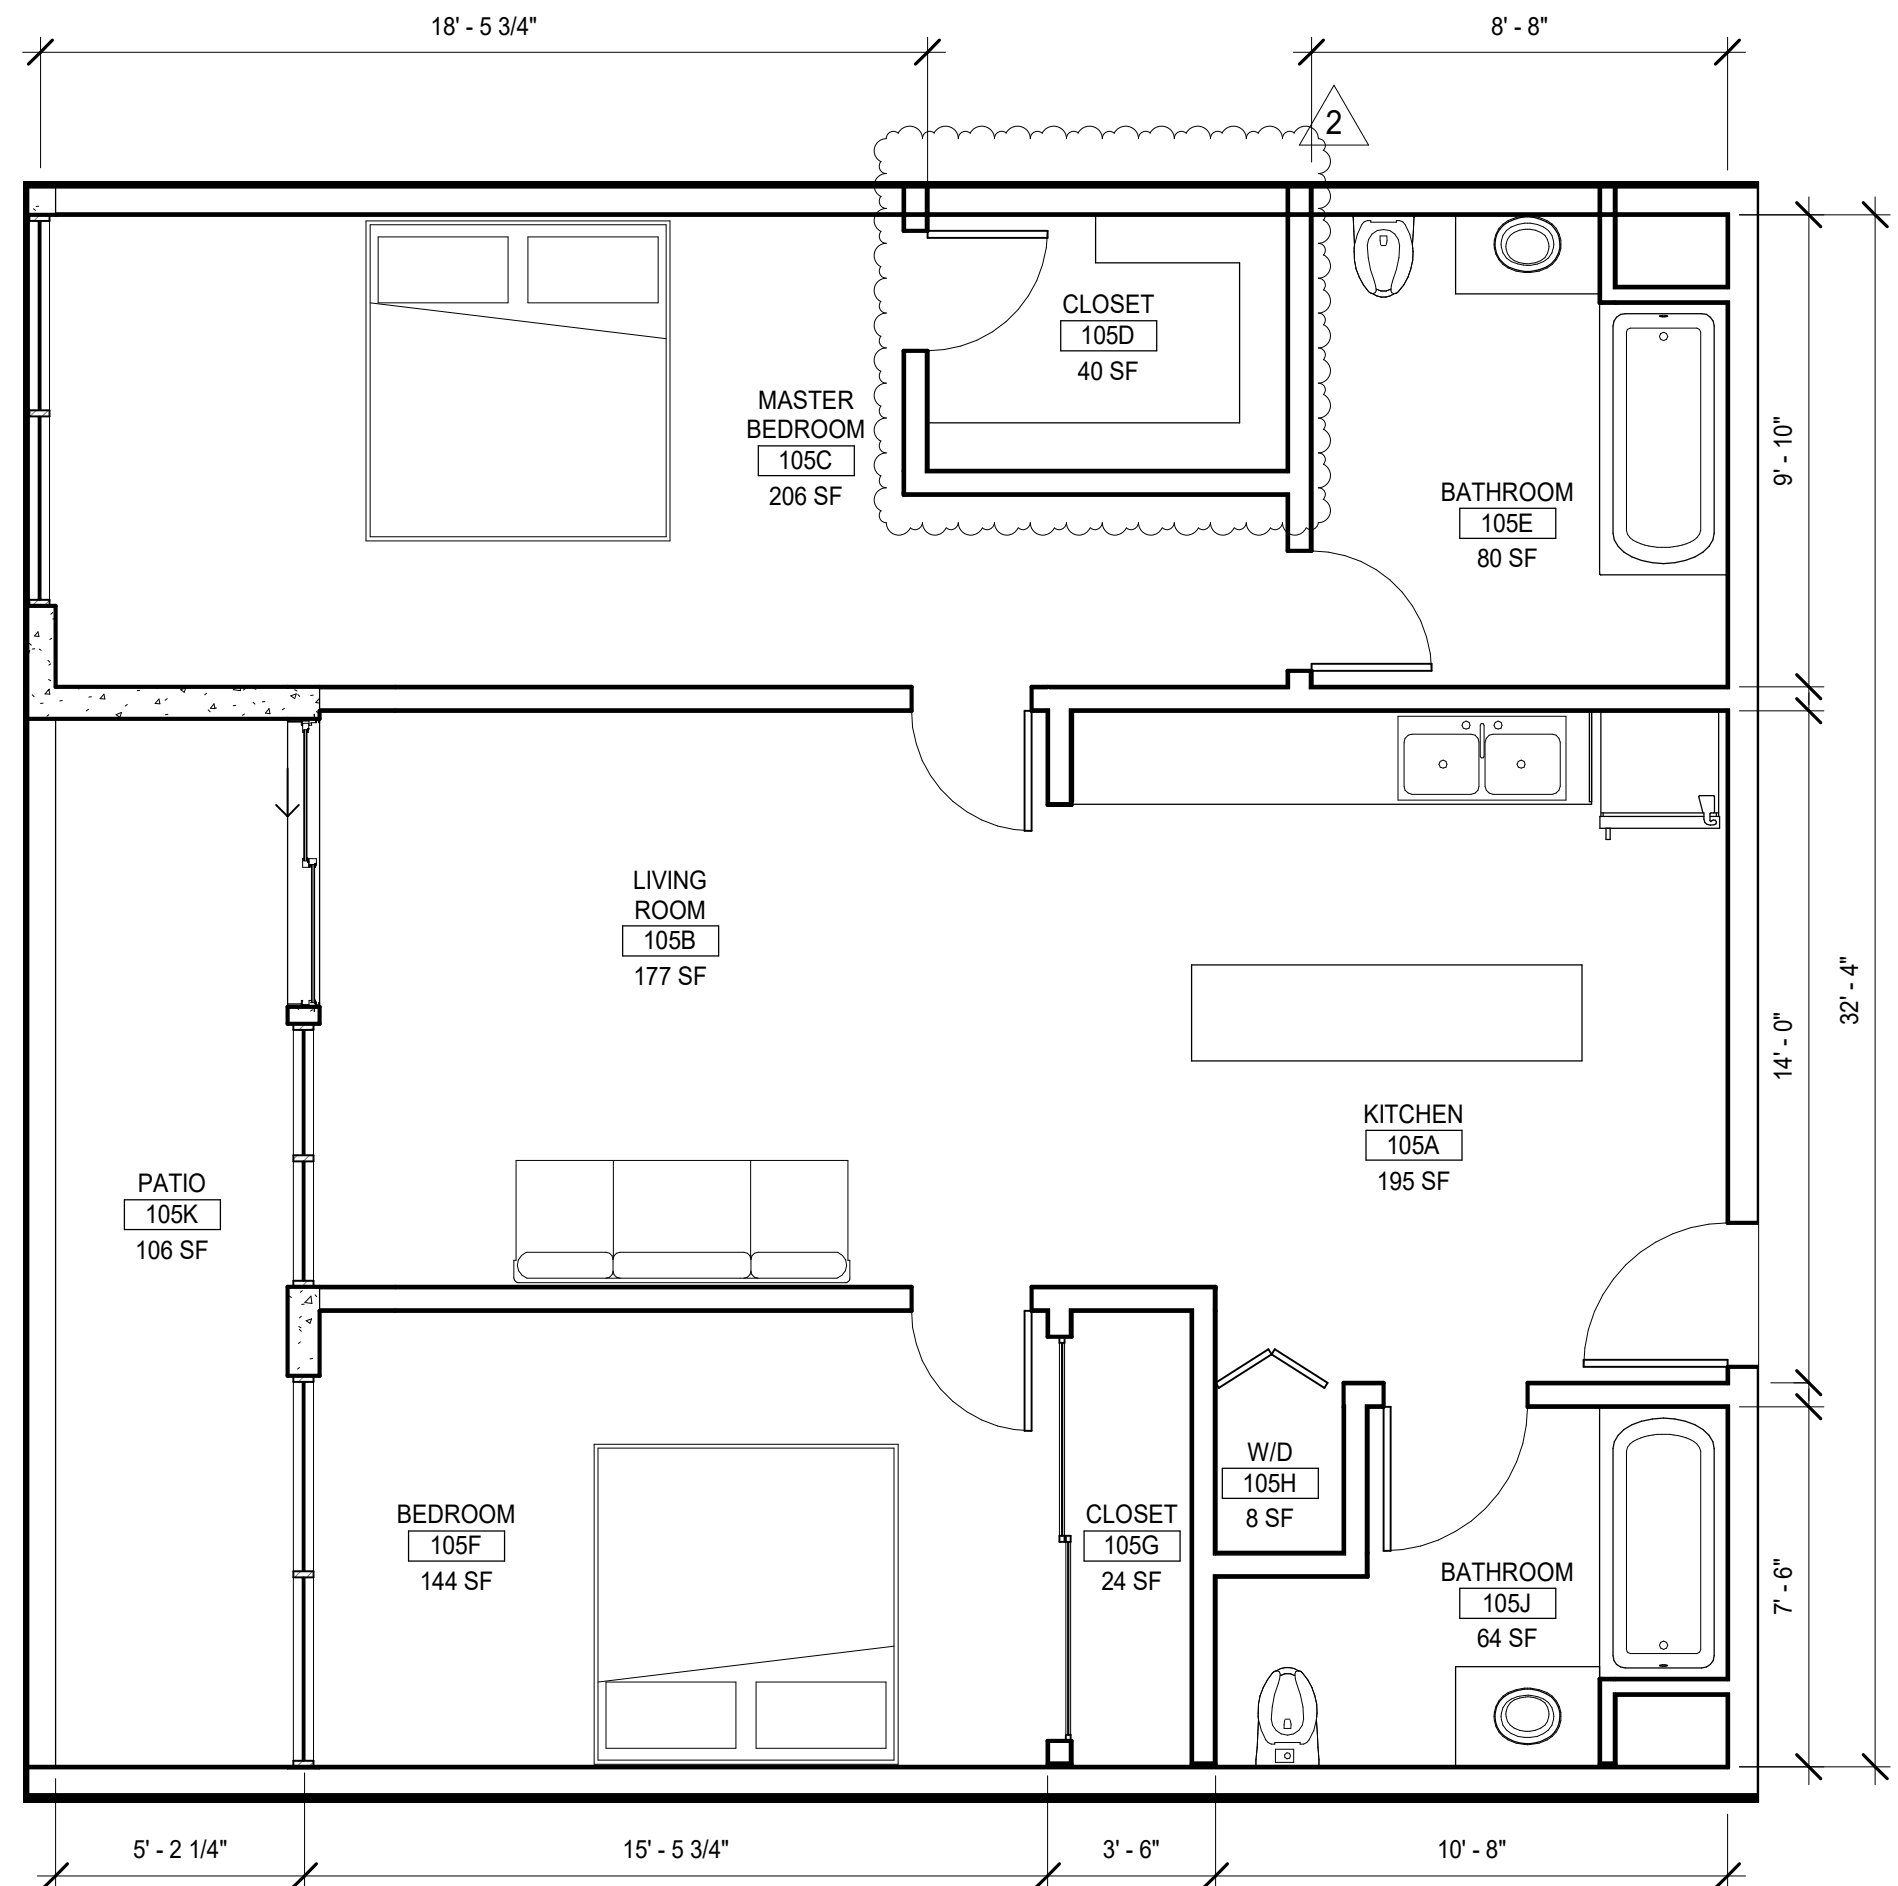

5 ENLARGED PLAN - TYP. 2-BED FLOOR PLAN SCALE 1/4" = 1'-0" 5

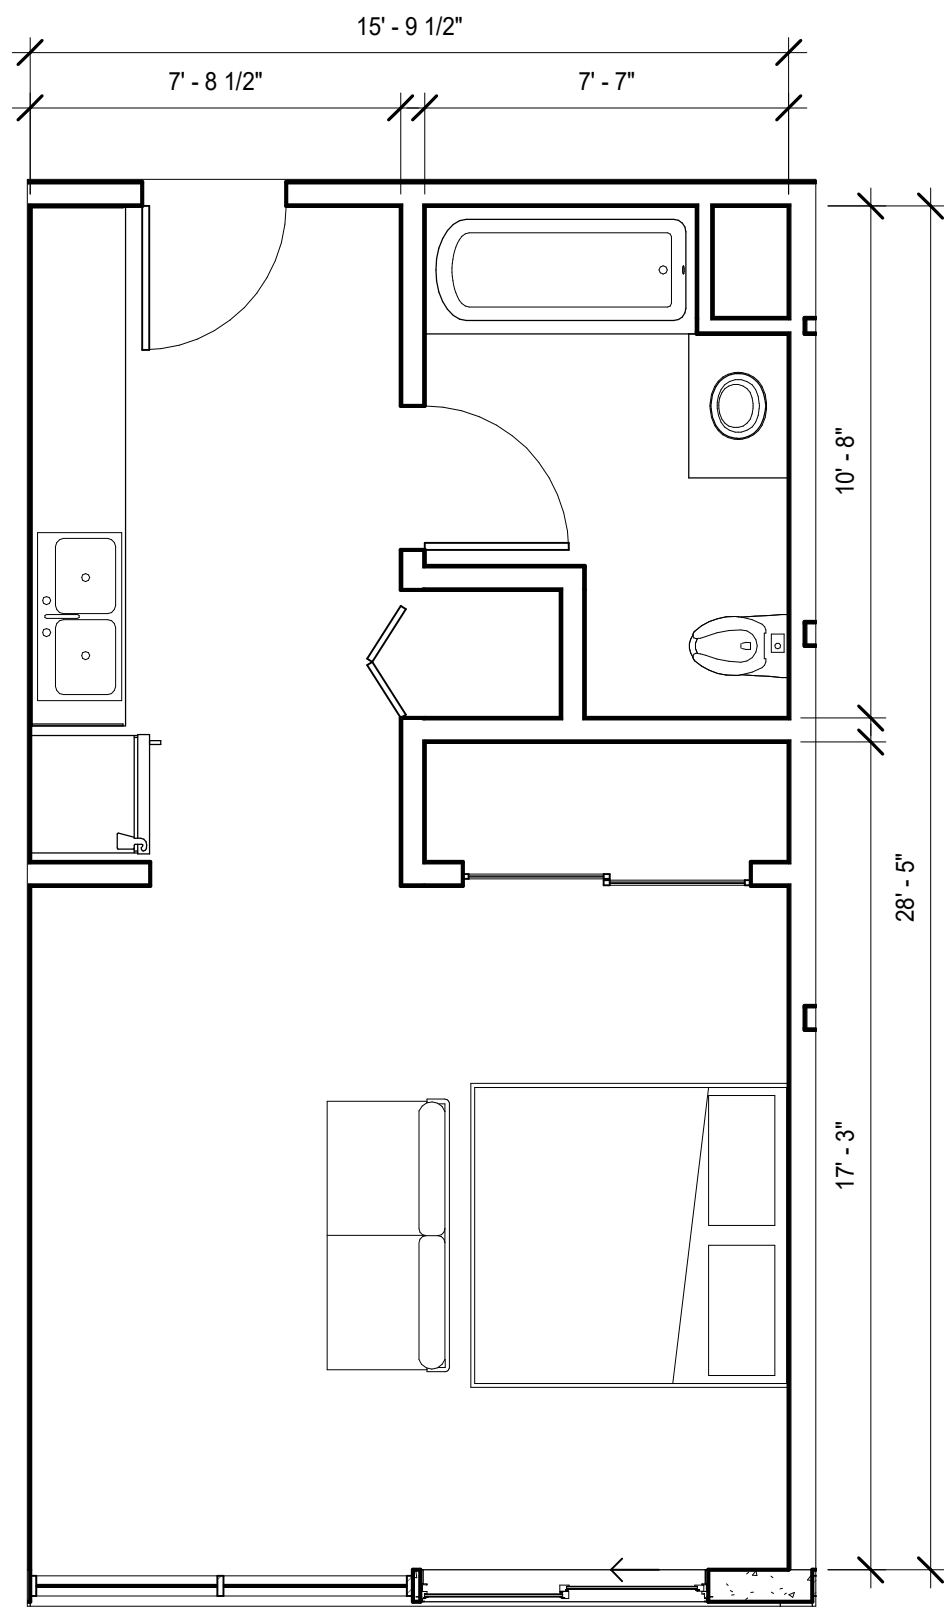

1 ENLARGED PLAN - TYP. STUDIO FLOOR PLAN SCALE 1/4" = 1'-0" 1


KEYNOTES

GENERAL NOTES

1. SEE SHEETS A003 AND A004 FOR GENERAL NOTES.

LEGEND

	NOT IN CONTRACT		ALIGN ELEMENTS
	EXISTING MILLWORK		ROOM NAME AND NUMBER
	NEW MILLWORK		FIRE EXTINGUISHER CABINET
	EXISTING PARTITION		NEW PLUMBING FIXTURES
	EXISTING DOOR		NEW PLUMBING FIXTURE, APPLIANCE, OR EQUIPMENT. REFER TO A720
	NEW PARTITION PER PLAN		FINISH SYMBOL
	WALL TAG. REFER TO A700		
	NEW DOOR		
	DOOR NUMBER. REFER TO A710		
	NEW GLAZING OR STOREFRONT SYSTEM PER SCHEDULE.		
	WINDOW TAG. REFER TO A710		

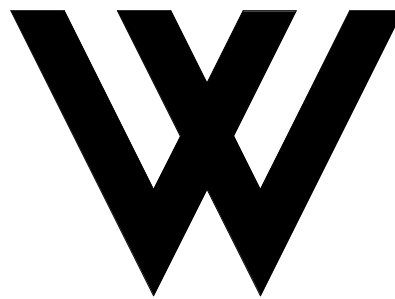

WOLCOTT
ARCHITECTURE
527 W. 11TH ST., STE. 130A, LOS ANGELES, CA 90014
310.204.2290 | WWW.WOLCOTTAI.COM

CONSULTANT:

CERTIFICATION:

NOT FOR CONSTRUCTION.
DRAWINGS ARE FOR
CONCEPTUAL DESIGN ONLY
AND ARE SUBJECT TO
REVIEW AND APPROVAL
FROM LOCAL JURISDICTION.

PROJECT:

BOB HOPE CENTRAL -
RESIDENTIAL
3201 W OLIVE AVE.
BURBANK, CA 91505

FLOOR/LEVEL:

ISSUE OR REVISION NOTES:

NO.	DATE	DESCRIPTION
	06.22.22	PLANNING DEVELOPMENT STANDARDS SUBMITTAL
1	10.01.22	BURBANK PLANNING COMMENTS
2	06.22.2023	PLANNING DEVELOPMENT STANDARDS RESUBMITTAL

CLIENT SIGNATURE:

SIGNATURE: DATE: -

The above drawings, specifications, details, designs and arrangements represent the property of the designer and shall remain the property of the designer and no part thereof shall be copied, reproduced, or used in connection with any work or project other than the stated project for which they have been prepared and developed without the written consent of the designer. Visual contact with these items or constitute conclusive evidence of acceptance of these restrictions. Written dimensions on these drawings shall have precedence over stated dimensions. Dimensions shall only be used in the event of any variations from the dimensions and conditions shown by these drawings. Shop details must be submitted to this office for approval before proceeding with fabrication.

PROJECT NO: 21-2779-1

DRAWN BY: RM, CS, GD CHECKED BY: SL

PROJECT MANAGER: CC

DRAWING SCALE: As indicated


SHEET SIZE: 30x42

DRAWING TITLE:

ENLARGED PLANS -
TYP. UNITS

SHEET NO:

A600

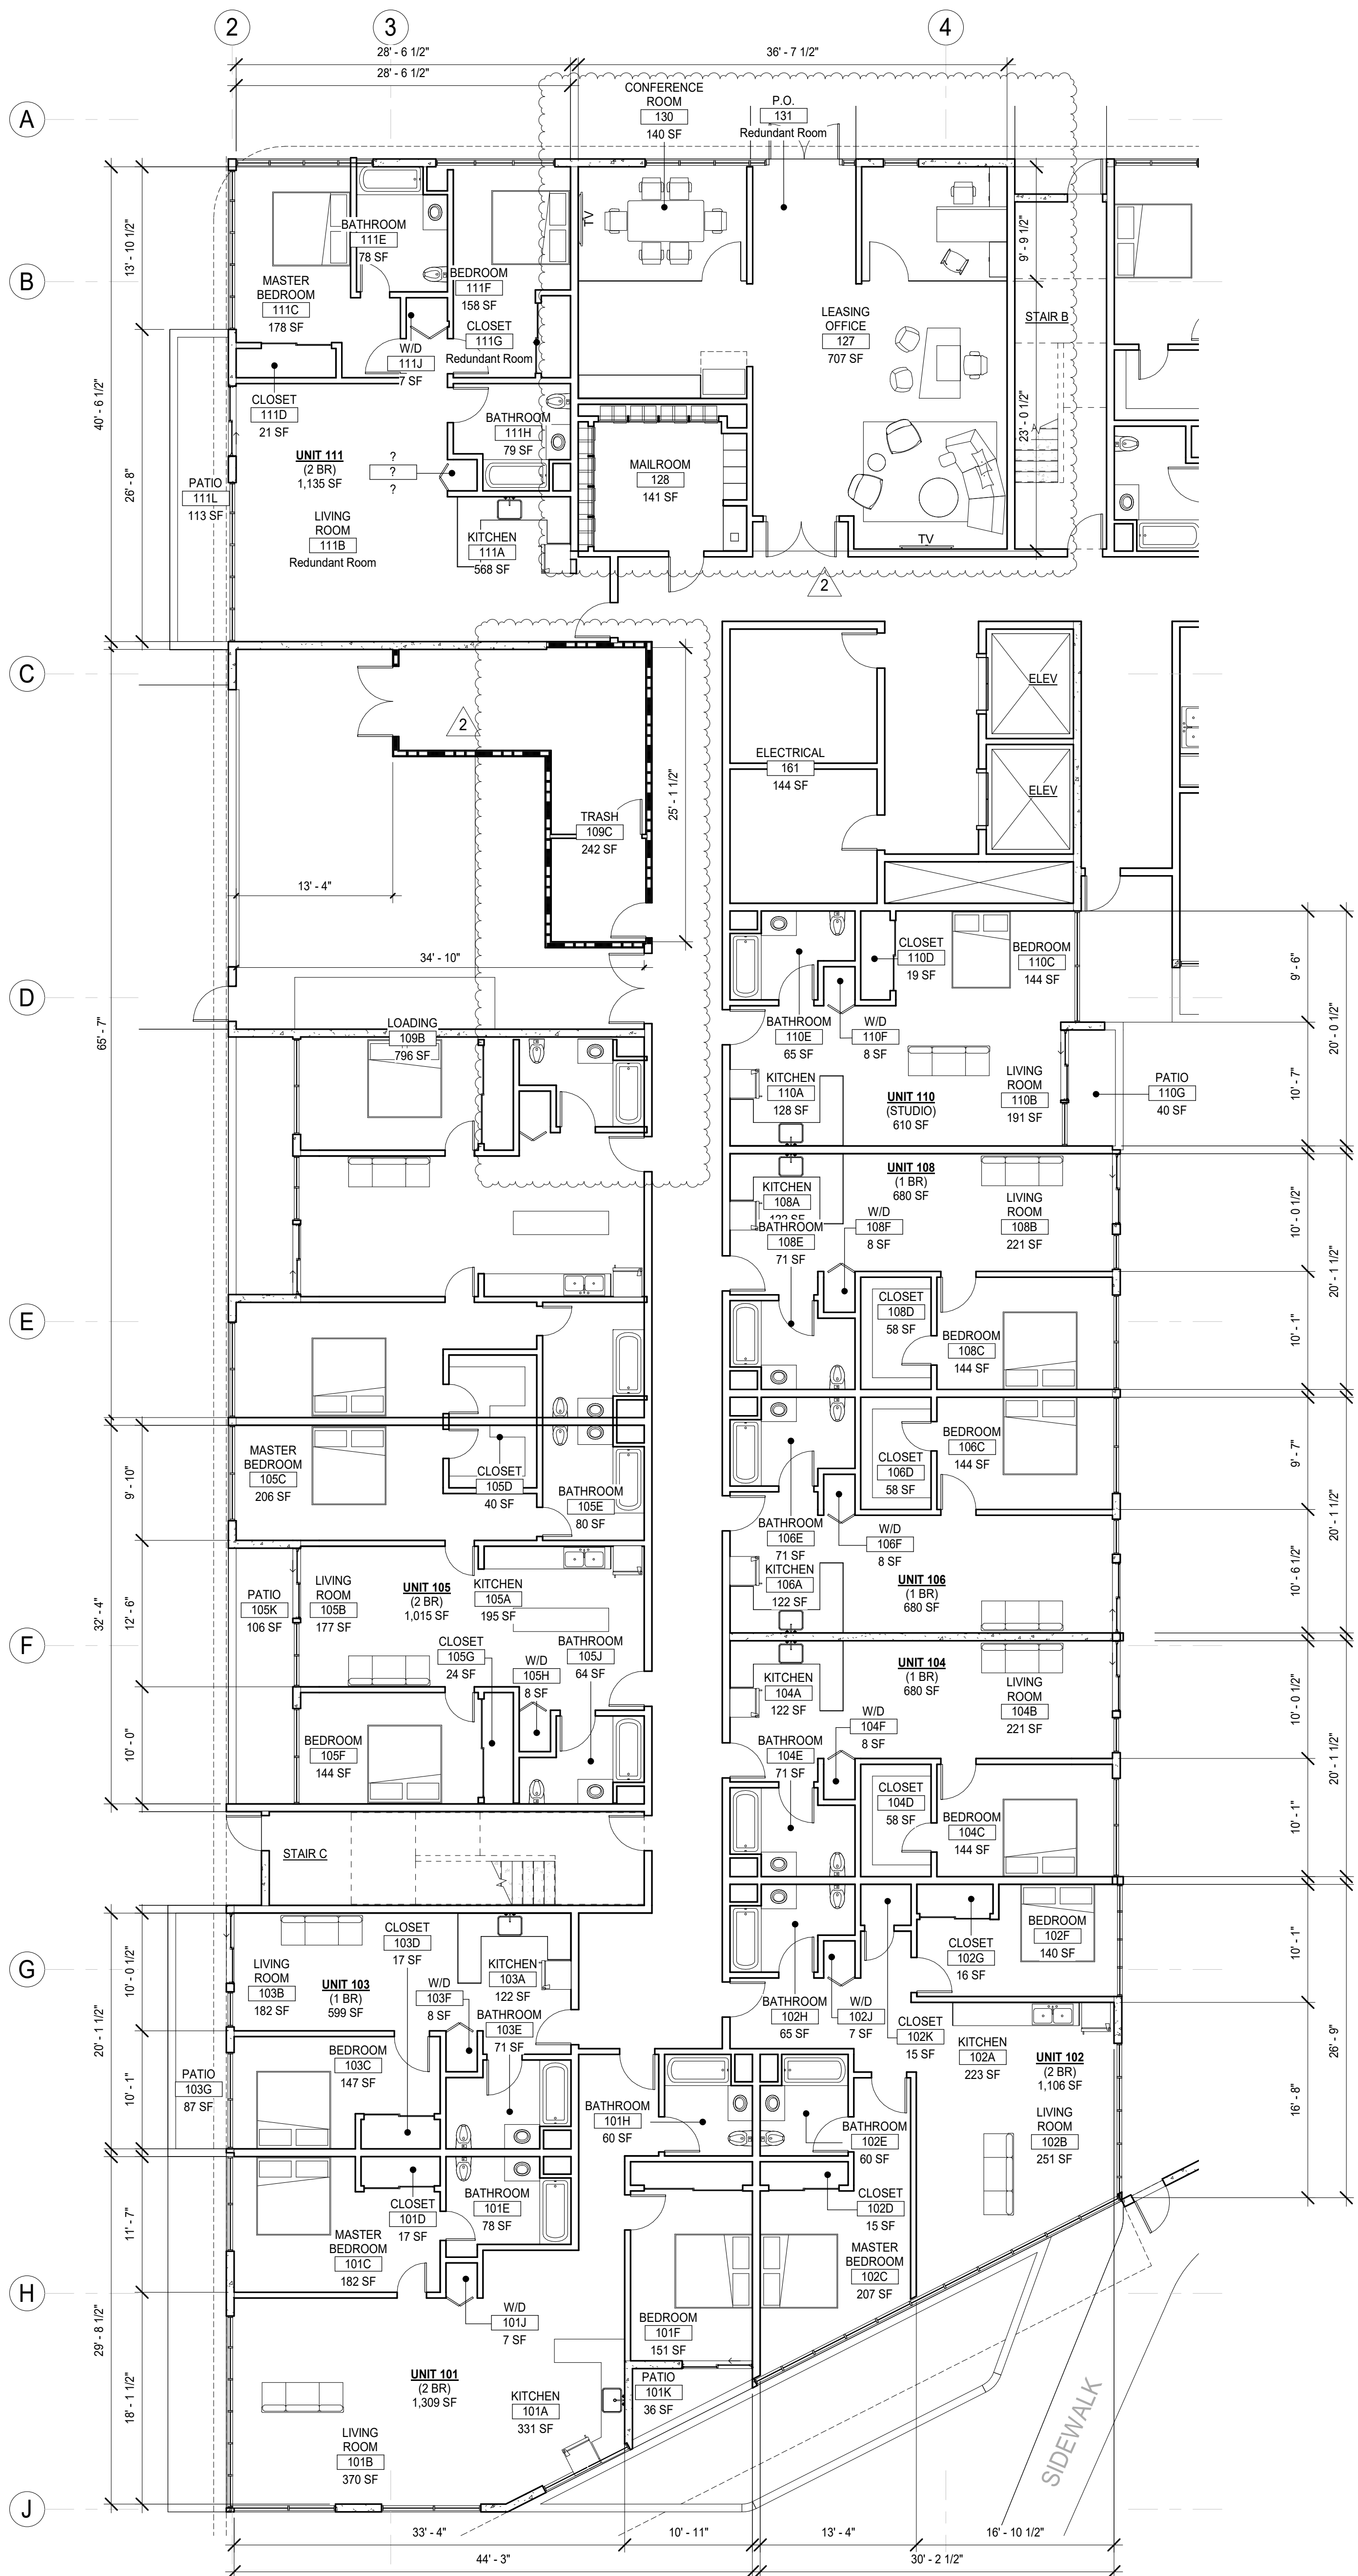

ENLARGED FLOOR PLAN 1ST FLOOR - AREA A

1/8" = 1'-0"

1

KEYNOTES

KEYPLAN AREA A

GENERAL NOTES

- SEE SHEETS A003 AND A004 FOR GENERAL NOTES.
- REFER TO SHEET A001 FOR SYMBOLS AND ABBREVIATIONS LEGEND.
- ALL WORK SHALL COMPLY WITH CURRENTLY ADOPTED ICC, NFPA, IAPMO, ASME BY JURISDICTION HAVING AUTHORITY.
- IN NO CASE SHALL DIMENSIONS OR OBJECTS OF ANY KIND BE SCALED FROM ANY DRAWINGS. THE CONTRACTOR SHALL VERIFY ALL CONDITIONS AND DIMENSIONS IN THE FIELD BEFORE PROCEEDING WITH SUBSEQUENT WORK. CONTRACTOR SHALL BRING ANY DISCREPANCIES OR CLARIFICATIONS TO THE ARCHITECT'S ATTENTION PRIOR TO PROCEEDING WITH ANY RELATED WORK.
- ALL DIMENSIONS ARE TO FACE STUD U.O.N. FINISH FLOOR ELEVATIONS ARE TO TOP OF CONCRETE SLAB AND/OR TOP OF CONCRETE UNDERLAYMENT U.O.N. CEILING HEIGHT DIMENSIONS ARE TO BE TO FINISHED SURFACES U.O.N.
- DIMENSIONS MARKED "MIN" INDICATE A MINIMUM CLEARANCE THAT MUST BE MAINTAINED WHEN FINISH MATERIALS ARE INSTALLED.
- ALL FRAMING MEMBERS SHALL BE SO ARRANGED AND SPACED AS TO PERMIT INSTALLATION OF PIPE CONDUITS AND DUCTWORK WITH A MINIMUM OF CUTTING. CONTRACTOR SHALL PROVIDE AND INSTALL ALL STIFFENERS, BRACES, BACK-UP PLATES AND SUPPORTING BRACKETS AS REQUIRED FOR THE INSTALLATION OF ALL WALL, MOUNTED OR SUSPENDED MECHANICAL AND ELECTRICAL EQUIPMENT, FIXTURES, BATHROOM ACCESSORIES, GRAB BARS, MILLWORK.
- ALL WOOD FRAMING IN EXTERIOR WALLS TO BE FIRE-RETARDANT TREATED WOOD COMPLYING WITH CBC SECTION 2303.2 WOOD FRAMING TO INCLUDE, BUT NOT LIMITED TO: STUDS, BLOCKING, EXTERIOR PLYWOOD SHEATHING, SILL PLATES, TOP PLATES, ETC.
- ADJUST FRAMING CONFIGURATION AT ALL FAN COIL UNITS WITHIN FLOOR/CEILING ASSEMBLY AS REQUIRED TO MAINTAIN FIRE-RATED ASSEMBLY. REFER TO MECHANICAL AND STRUCTURAL DRAWINGS FOR ADDITIONAL INFORMATION.
- ALL WOOD FRAMING IN CONTACT WITH CONCRETE IS TO BE PRESSURE TREATED.
- ALL FINISH WALL SURFACES TO BE FLUSH U.O.N. PROVIDE FURRING AS REQUIRED.
- ALL GYPSUM BOARD WALLS AND CEILINGS TO BE TAPED, SANDED, AND PRIMED TO LEVEL 4 FINISH U.O.N.
- REFER TO SHEET A800 FOR WALL TYPES.
- REFER TO SHEET A700 FOR DOOR SCHEDULE AND DETAILS AND WINDOW SCHEDULE AND DETAILS.
- REFER TO SHEET A710 FOR FINISH, LIGHT FIXTURE, APPLIANCE, EQUIPMENT, AND PLUMBING FIXTURE SCHEDULES.
- ALL LIGHTING TO BE SHIELDED TO ELIMINATE GLARE ONTO ADJACENT PROPERTIES PER BMC 10-1-2017 (H) (1) CARPORTS, GARAGES, PARKING AREAS, AND DRIVEWAYS SHALL CONTAIN SECURITY LIGHTING. PRIMARY PEDESTRIAN SAFETY PER BMC 10-1-2017 (G)(2)
- (NOT USED)
- PER TABLE N-4 OF THE BURBANK 2035 GENERAL PLAN THIS PROJECT WILL BE CONSTRUCTED IN A WAY TO ACHIEVE INTERIOR NOISE LEVELS US 45DBA MAX. PER TABLE N-3 MAXIMUM ALLOWABLE NOISE EXPOSURE - TRANSPORTATION SOURCES OF THE GENERAL PLAN.
- THIS PROJECT WILL BE CONSTRUCTED INCORPORATING BUILDING DESIGN FEATURES THAT MINIMIZE THE CONSUMPTION OF ENERGY, WATER, AND OTHER NATURAL RESOURCES CONSISTENT WITH THE CITY'S BUILDING AND ENERGY CODES.

LEGEND

- | | | | |
|--|--|--|---------------------------|
| | NOT IN CONTRACT | | ALIGN ELEMENTS |
| | EXISTING MILLWORK | | ROOM NAME AND NUMBER |
| | NEW MILLWORK | | FIRE EXTINGUISHER CABINET |
| | EXISTING PARTITION | | NEW PLUMBING FIXTURES |
| | EXISTING DOOR | | |
| | WALL TAG. REFER TO A800 | | |
| | NEW PARTITION PER PLAN | | |
| | NEW DOOR | | |
| | DOOR NUMBER. REFER TO A700 | | |
| | WINDOW TAG. REFER TO A700 | | |
| | NEW PLUMBING FIXTURE, APPLIANCE, OR EQUIPMENT. REFER TO A710 | | |



CONSULTANT:

CERTIFICATION:

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PROJECT:

BOB HOPE CENTER -
RESIDENTIAL
3201 W OLIVE AVE.
BURBANK, CA 91505

FLOOR/LEVEL:

ISSUE OR REVISION NOTES:

NO.	DATE	DESCRIPTION
06.22.22	06.22.22	PLANNING DEVELOPMENT STANDARDS SUBMITTAL
1	10.01.22	BURBANK PLANNING COMMENTS
2	06.22.2023	PLANNING DEVELOPMENT STANDARDS RESUBMITTAL

CLIENT SIGNATURE:

SIGNATURE: DATE: -

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PROJECT NO: 21-2779-1

DRAWN BY: RM, CS, GD CHECKED BY: SL

PROJECT MANAGER: CC

DRAWING SCALE: As indicated


SHEET SIZE: 30x42

DRAWING TITLE:

ENLARGED PLAN 1ST
FLOOR - AREA A

SHEET NO:

A601

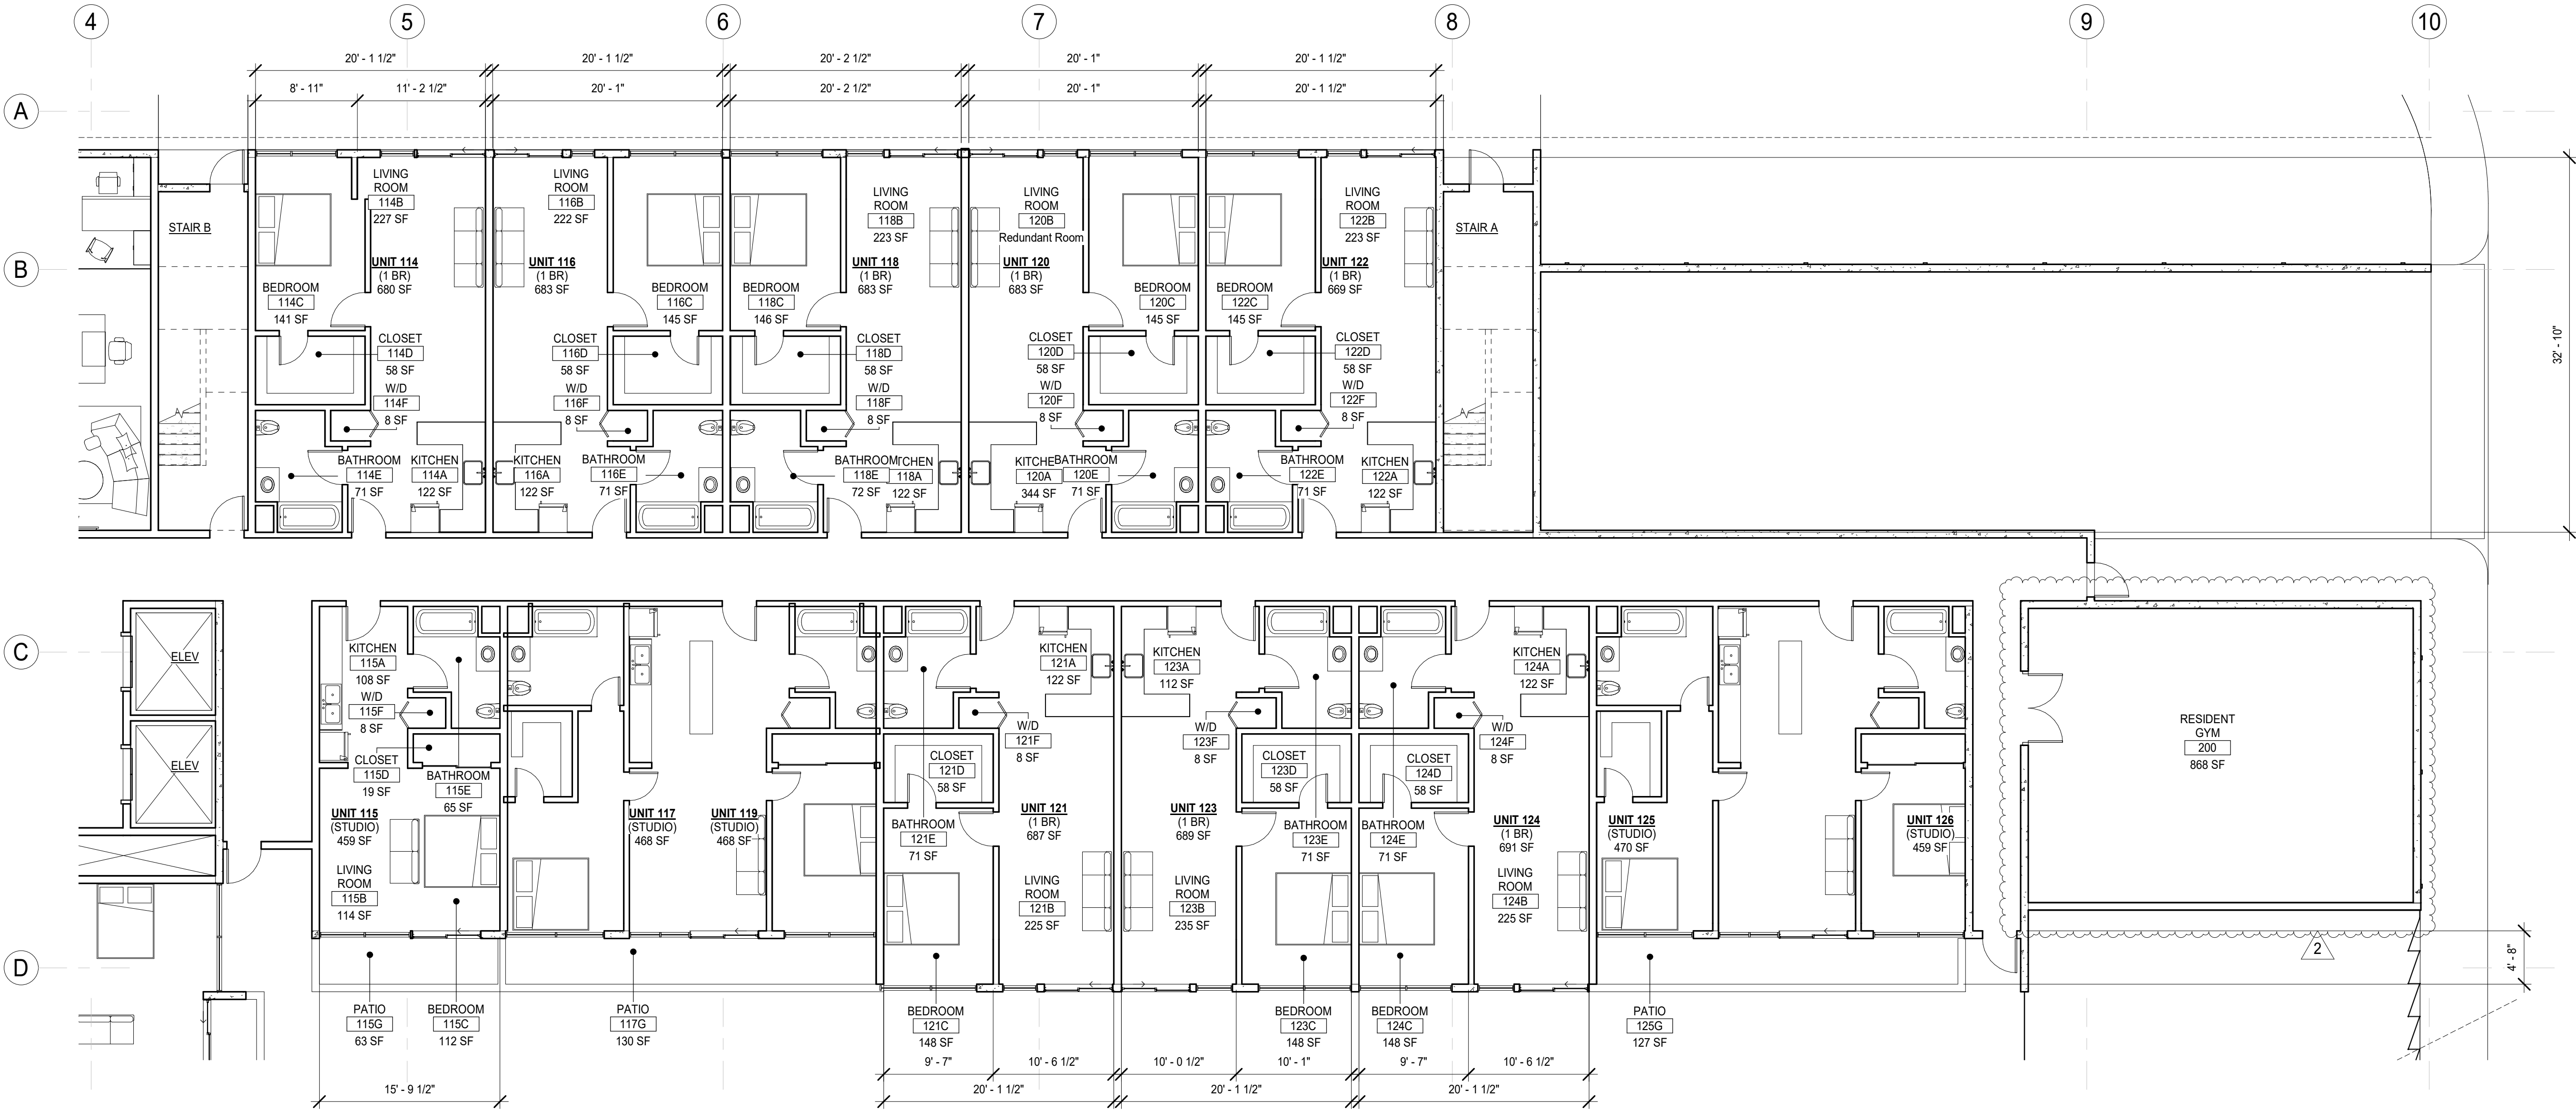

KEYNOTES



CONSULTANT:

CERTIFICATION:

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AND ARE SUBJECT TO
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FROM LOCAL JURISDICTION.

PROJECT:

KEYPLAN AREA B



GENERAL NOTES

- SEE SHEETS A003 AND A004 FOR GENERAL NOTES.
- REFER TO SHEET A001 FOR SYMBOLS AND ABBREVIATIONS LEGEND.
- ALL WORK SHALL COMPLY WITH CURRENTLY ADOPTED ICC, NFPA, IAPMO, ASME BY JURISDICTION HAVING AUTHORITY.
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- ALL WOOD FRAMING IN EXTERIOR WALLS TO BE FIRE-RETARDANT TREATED WOOD COMPLYING WITH CBC SECTION 2003.2. WOOD FRAMING TO INCLUDE, BUT NOT LIMITED TO: STUDS, BLOCKING, EXTERIOR PLYWOOD SHEATHING, SILL PLATES, TOP PLATES, ETC.
- ADJUST FRAMING CONFIGURATION AT ALL FAN COIL UNITS WITHIN FLOOR/CEILING ASSEMBLY AS REQUIRED TO MAINTAIN FIRE-RATED ASSEMBLY. REFER TO MECHANICAL AND STRUCTURAL DRAWINGS FOR ADDITIONAL INFORMATION.
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- REFER TO SHEET A800 FOR WALL TYPES.
- REFER TO SHEET A700 FOR DOOR SCHEDULE AND DETAILS AND WINDOW SCHEDULE AND DETAILS.
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- (NOT USED)
- LIGHTS CONFORMING TO STANDARDS PRESCRIBED BY THE PUBLIC WORKS DIRECTOR SHALL BE INSTALLED IN ALL NIGHTTIME PARKING LOTS USED FOR PUBLIC PARKING OR FOR COMMERCIAL PURPOSES. PER BMC 10-1-1420.
- PER TABLE N-4 OF THE BURBANK 2035 GENERAL PLAN THIS PROJECT WILL BE CONSTRUCTED IN A WAY TO ACHIEVE INTERIOR NOISE LEVELS US 45DBA MAX. PER TABLE N-3 MAXIMUM ALLOWABLE NOISE EXPOSURE - TRANSPORTATION SOURCES OF THE GENERAL PLAN.
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LEGEND

	NOT IN CONTRACT		ALIGN ELEMENTS
	EXISTING MILLWORK		ROOM NAME AND NUMBER
	NEW MILLWORK		FIRE EXTINGUISHER CABINET
	EXISTING PARTITION		NEW PLUMBING FIXTURES
	EXISTING DOOR		
	WALL TAG. REFER TO A800		
	NEW PARTITION PER PLAN		
	NEW DOOR		
	DOOR NUMBER. REFER TO A700		
	WINDOW TAG. REFER TO A700 NEW GLAZING OR STOREFRONT SYSTEM PER SCHEDULE.		
	NEW PLUMBING FIXTURE, APPLIANCE, OR EQUIPMENT. REFER TO A710		

ENLARGED FLOOR PLAN 1ST FLOOR - AREA B

1/8" = 1'-0"

1

BOB HOPE CENTER - RESIDENTIAL

3201 W OLIVE AVE.
BURBANK, CA 91505

FLOOR/LEVEL:

ISSUE OR REVISION NOTES:

NO.	DATE	DESCRIPTION
	06.22.22	PLANNING DEVELOPMENT STANDARDS SUBMITTAL
1	10.01.22	BURBANK PLANNING COMMENTS
2	06.22.2023	PLANNING DEVELOPMENT STANDARDS RESUBMITTAL

CLIENT SIGNATURE:

SIGNATURE:

DATE: -

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PROJECT NO: 21-2779-1

DRAWN BY: RM, CS, GD CHECKED BY: SL

PROJECT MANAGER: CC

DRAWING SCALE: As indicated


SHEET SIZE: 30x42

DRAWING TITLE:

ENLARGED PLAN 1ST
FLOOR - AREA B

SHEET NO:

A602

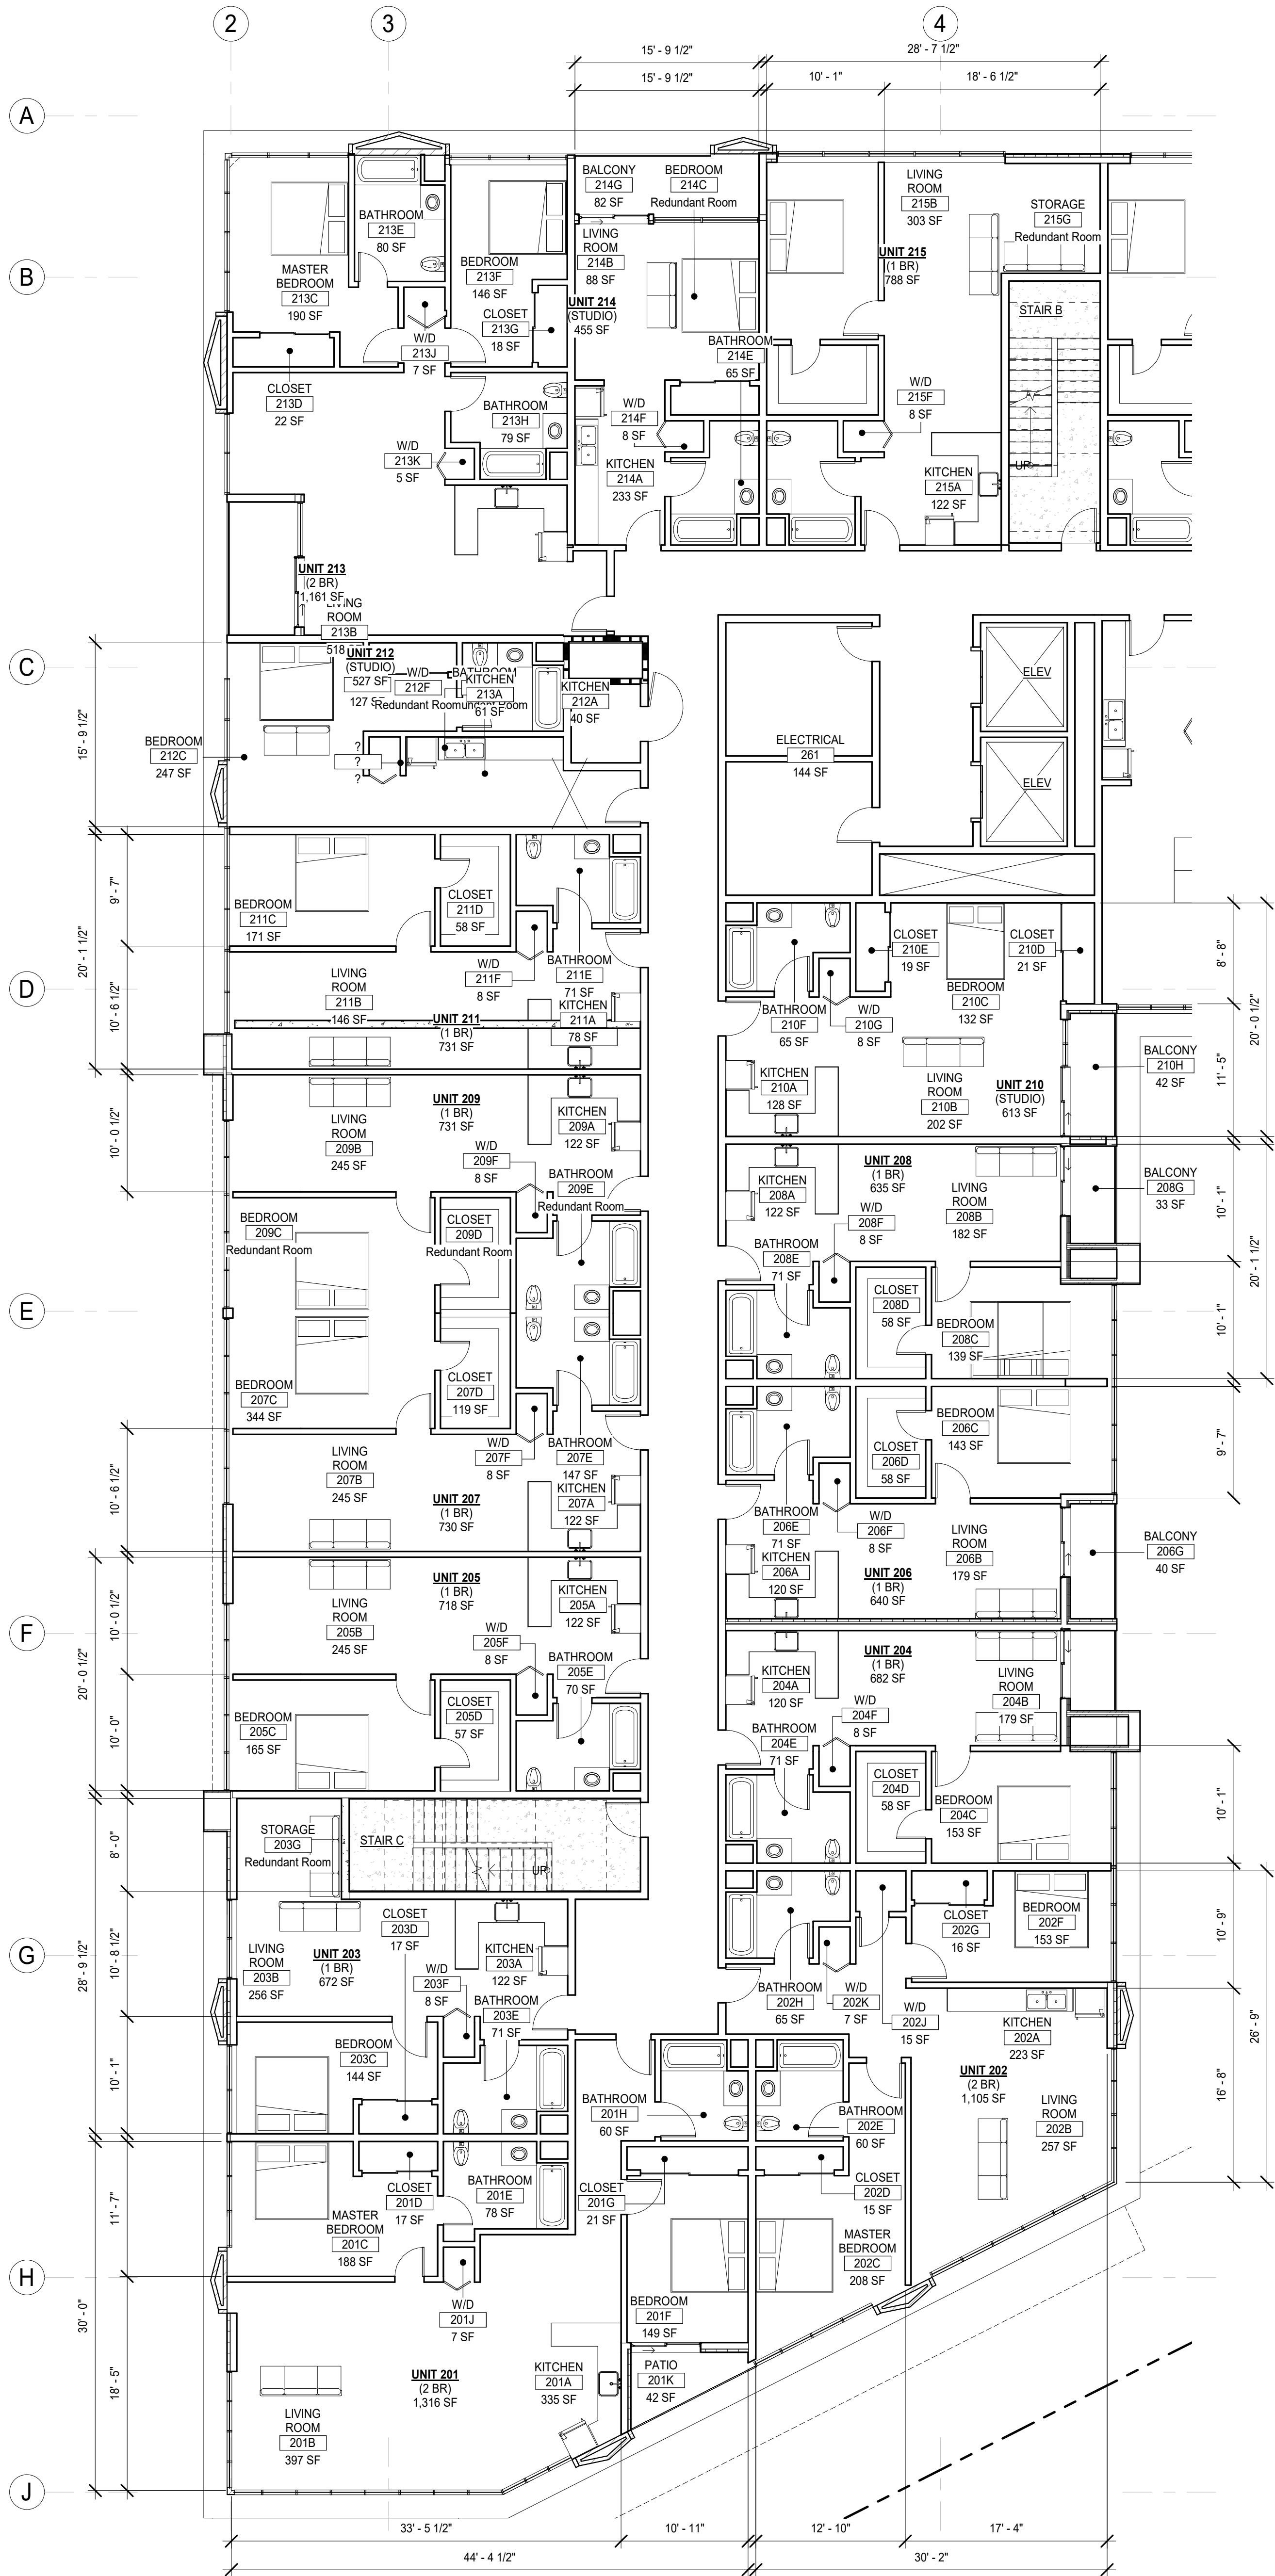

ENLARGED FLOOR PLAN 2ND FLOOR - AREA A

1/8" = 1'-0"

1

KEYNOTES

KEYPLAN AREA A

GENERAL NOTES

- SEE SHEETS A003 AND A004 FOR GENERAL NOTES.
- REFER TO SHEET A001 FOR SYMBOLS AND ABBREVIATIONS LEGEND.
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- REFER TO SHEET A800 FOR WALL TYPES.
- REFER TO SHEET A700 FOR DOOR SCHEDULE AND DETAILS AND WINDOW SCHEDULE AND DETAILS.
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- (NOT USED)
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- PER TABLE N-4 OF THE BURBANK 2035 GENERAL PLAN THIS PROJECT WILL BE CONSTRUCTED IN A WAY TO ACHIEVE INTERIOR NOISE LEVELS US 45DBA MAX. PER TABLE N-3 MAXIMUM ALLOWABLE NOISE EXPOSURE - TRANSPORTATION SOURCES OF THE GENERAL PLAN.
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LEGEND

- | | | | |
|--|---|--|---------------------------|
| | NOT IN CONTRACT | | ALIGN ELEMENTS |
| | EXISTING MILLWORK | | ROOM NAME AND NUMBER |
| | NEW MILLWORK | | FIRE EXTINGUISHER CABINET |
| | EXISTING PARTITION | | NEW PLUMBING FIXTURES |
| | EXISTING DOOR | | |
| | WALL TAG. REFER TO A800 | | |
| | NEW PARTITION PER PLAN | | |
| | NEW DOOR | | |
| | DOOR NUMBER. REFER TO A700 | | |
| | WINDOW TAG. REFER TO A700
NEW GLAZING OR STOREFRONT SYSTEM PER SCHEDULE. | | |
| | NEW PLUMBING FIXTURE, APPLIANCE, OR EQUIPMENT. REFER TO A710 | | |

CONSULTANT:

CERTIFICATION:

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PROJECT:

**BOB HOPE CENTER -
RESIDENTIAL**
3201 W OLIVE AVE.
BURBANK, CA 91505

FLOOR/LEVEL:

ISSUE OR REVISION NOTES:

NO.	DATE	DESCRIPTION
1	06.22.22	PLANNING DEVELOPMENT STANDARDS SUBMITTAL
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2	06.22.2023	PLANNING DEVELOPMENT STANDARDS RESUBMITTAL

CLIENT SIGNATURE:

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PROJECT NO: 21-2779-1

DRAWN BY: RM, CS, GD CHECKED BY: SL

PROJECT MANAGER: CC

DRAWING SCALE: As indicated


SHEET SIZE: 30x42

DRAWING TITLE:

ENLARGED PLAN 2ND
FLOOR - AREA A

SHEET NO:

A603

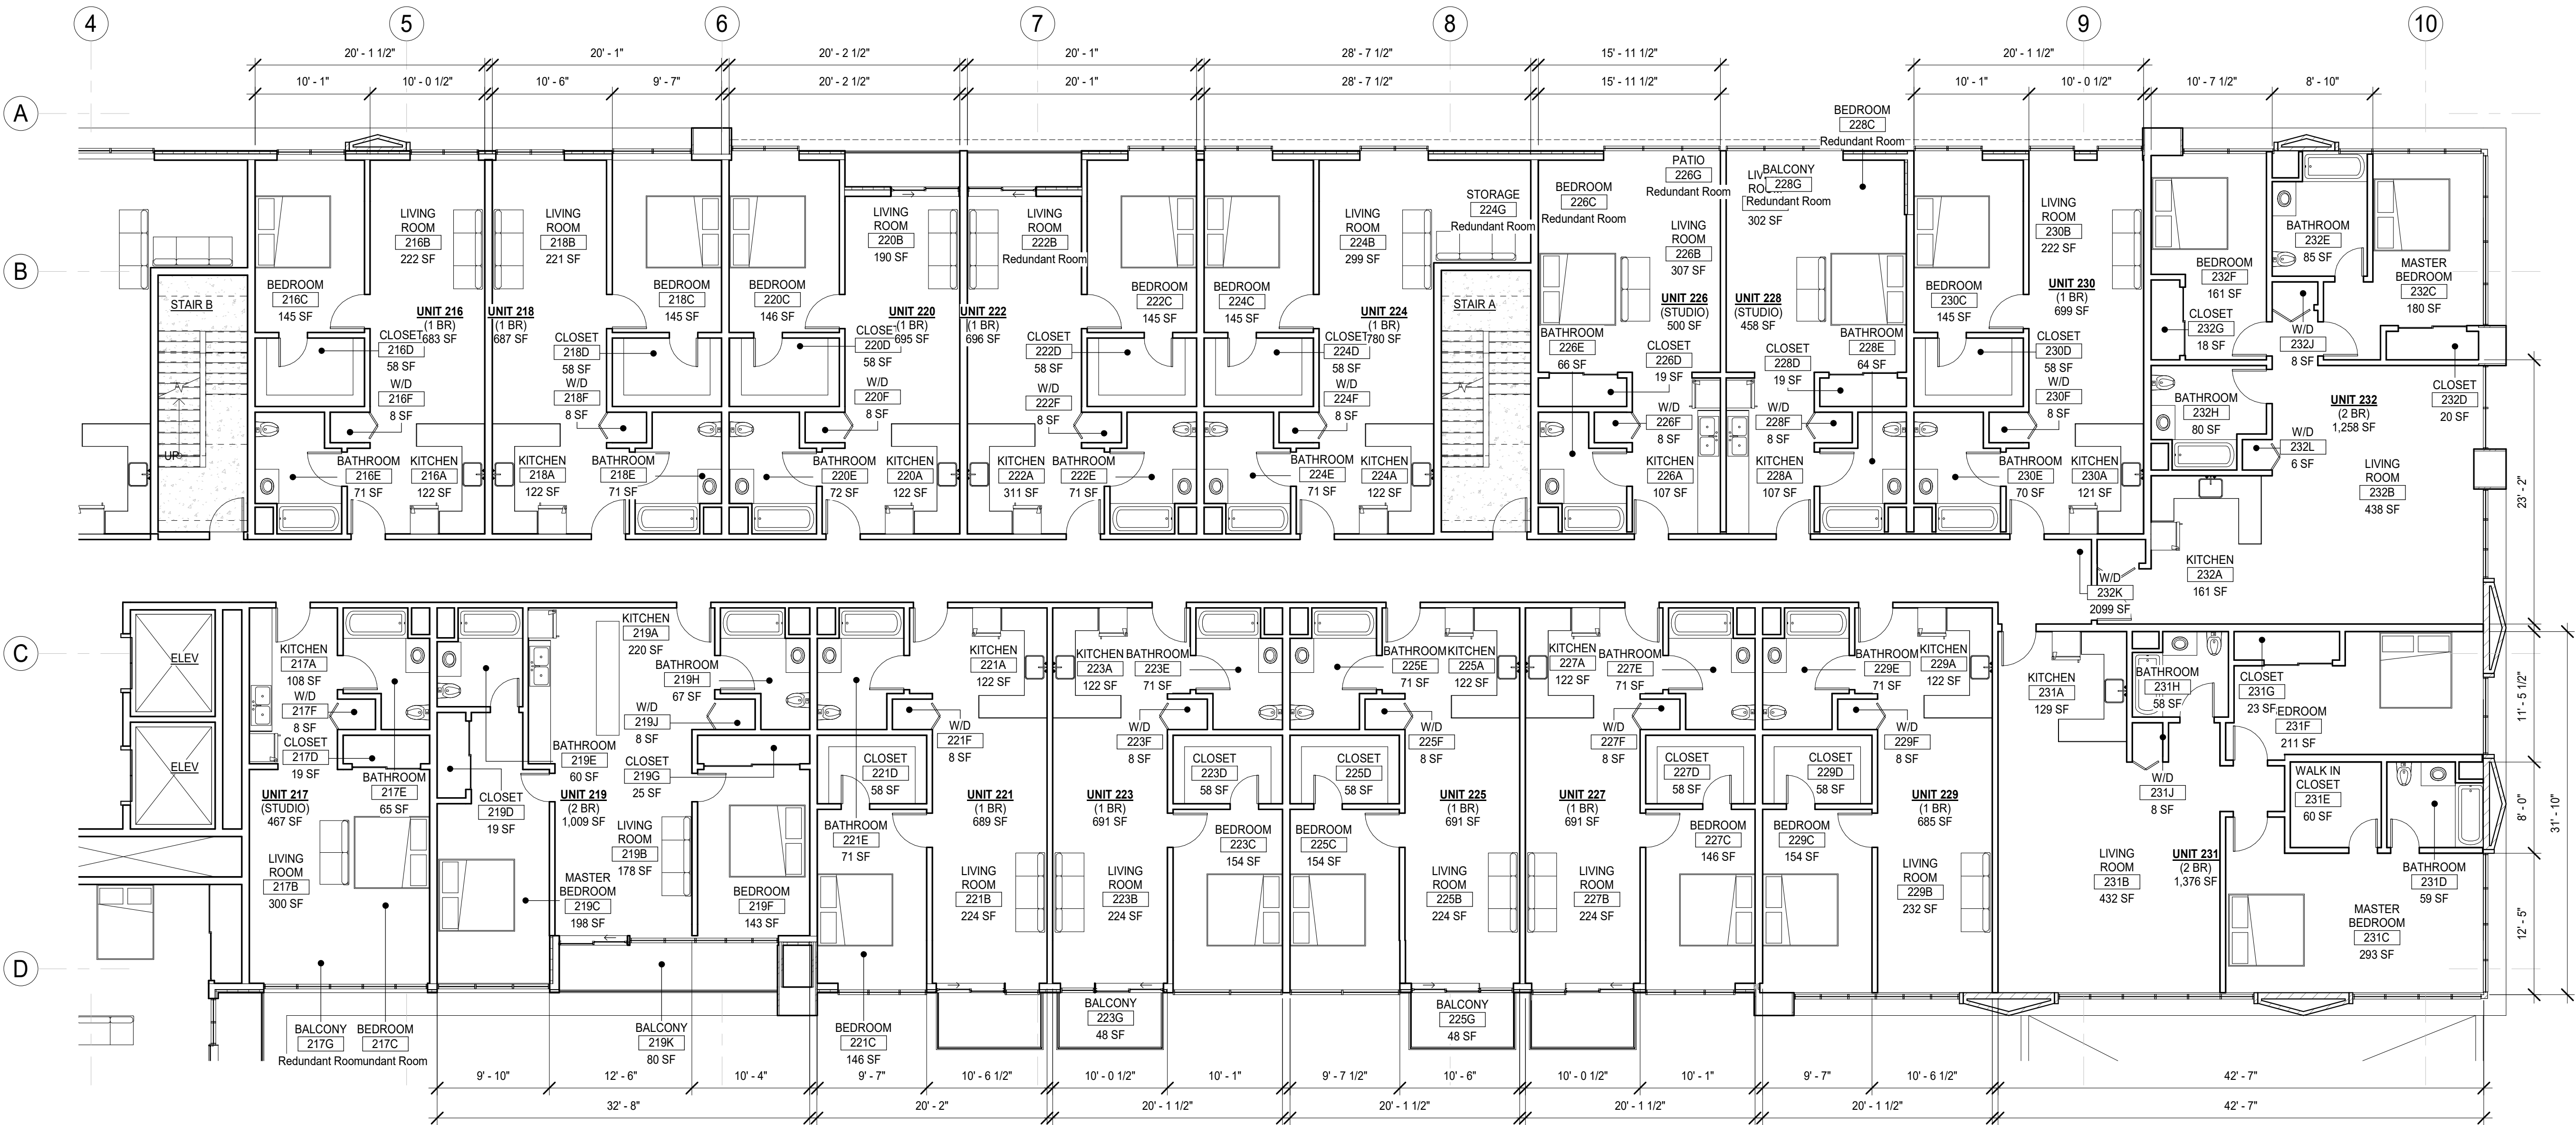

KEYNOTES

KEYPLAN AREA B

GENERAL NOTES

- SEE SHEETS A003 AND A004 FOR GENERAL NOTES.
- REFER TO SHEET A001 FOR SYMBOLS AND ABBREVIATIONS LEGEND.
- ALL WORK SHALL COMPLY WITH CURRENTLY ADOPTED ICC, NFPA, IAPMO, ASME BY JURISDICTION HAVING AUTHORITY.
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- (NOT USED)
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LEGEND

- | | | | |
|--|---|--|---------------------------|
| | NOT IN CONTRACT | | ALIGN ELEMENTS |
| | EXISTING MILLWORK | | ROOM NAME AND NUMBER |
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| | EXISTING DOOR | | |
| | WALL TAG. REFER TO A800 | | |
| | NEW PARTITION PER PLAN | | |
| | NEW DOOR | | |
| | DOOR NUMBER. REFER TO A700 | | |
| | WINDOW TAG. REFER TO A700
NEW GLAZING OR STOREFRONT SYSTEM PER SCHEDULE. | | |
| | NEW PLUMBING FIXTURE, APPLIANCE, OR EQUIPMENT. REFER TO A710 | | |

ENLARGED FLOOR PLAN 2ND FLOOR - AREA B

1/8" = 1'-0"

1

CONSULTANT:

CERTIFICATION:

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3201 W OLIVE AVE.
BURBANK, CA 91505

FLOOR/LEVEL:

ISSUE OR REVISION NOTES:

NO.	DATE	DESCRIPTION
06.22.22	06.22.22	PLANNING DEVELOPMENT STANDARDS SUBMITTAL
1	10.01.22	BURBANK PLANNING COMMENTS
2	06.22.2023	PLANNING DEVELOPMENT STANDARDS RESUBMITTAL

CLIENT SIGNATURE:

SIGNATURE:

DATE: -

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PROJECT NO: 21-2779-1

DRAWN BY: RM, CS, GD CHECKED BY: SL

PROJECT MANAGER: CC

DRAWING SCALE: As indicated

SHEET SIZE: 30x42

DRAWING TITLE:

ENLARGED PLAN 2ND
FLOOR- AREA B

SHEET NO:

A604



CERTIFICATION

NOT FOR CONSTRUCTION.
DRAWINGS ARE FOR
CONCEPTUAL DESIGN ONLY
AND ARE SUBJECT TO
REVIEW AND APPROVAL
FROM LOCAL JURISDICTION

BOB HOPE CENTER - RESIDENTIAL

3201 W OLIVE AVE.
BURBANK, CA 91505

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PROJECT NO: 21-2779-1

DRAWN BY: RM, CS, GD CHECKED BY: SL

PROJECT MANAGER: CC

DRAWING SCALE: 1 1/2" = 1'-0"

SHEET SIZE: 30X42

DRAWING TITLE

SCHEDULE - FINISH AND FIXTURE

SHEET NO.

FINISH SCHEDULE					
FINISH NO.	DESCRIPTION	MANUFACTURER	SPECIFICATION	LOCATION	NOTES
CN-1	CONCRETE	-	BOARD-FORMED CONCRETE	SEE FINISH ELEVATION	DAVIS COLORS, DARK GREY (CARBON) 8084
MP-1	METAL PANEL	LUMBOARD	ALUMINUM F40-10 CHARCOAL	SEE FINISH ELEVATION	-
MP-2	METAL PANEL	METAL SALES	TLC-1, 22 GA FLAT SEAM METAL PANEL	SEE FINISH ELEVATION	COLOR TO MATCH PT-1
ST-1	STEEL	-	STEEL BARSTOCK HANDRAIL	SEE FINISH ELEVATION	COLOR TO MATCH PT-2
WD-1	WOOD COMPOSITE PANEL	TRESPA	METEON-LOFT BROWN	SEE FINISH ELEVATION	-
WF-1	WALL FINISH	EIFS	EIFS, PAINTED	SEE FINISH ELEVATION	PAINTED PT-1

PT-1 (PAINT, EIFS)

SCALE
N.T.S.

4

MP-2 (FLAT-SEAM METAL PANEL TLC-1)

SCALE
N.T.S.

3

WD-1 (WOOD PANEL-TRESPA)

SCALE
N.T.S.

6

MP-1 (METAL PANEL)

SCALE
N.T.S.

2

PT-2 (PAINT, STEEL)

SCALE
N.T.S.


5

CN-1 (BOARD-FORMED CONCRETE)

SCALE
N.T.S.

1

FILE NAME: Autodesk Docs\RP22_BHC-Residential\21-2779-1 Bob Hope Center-Resi.rvt
DATE STAMP: 6/22/2023 2:35:03 PM

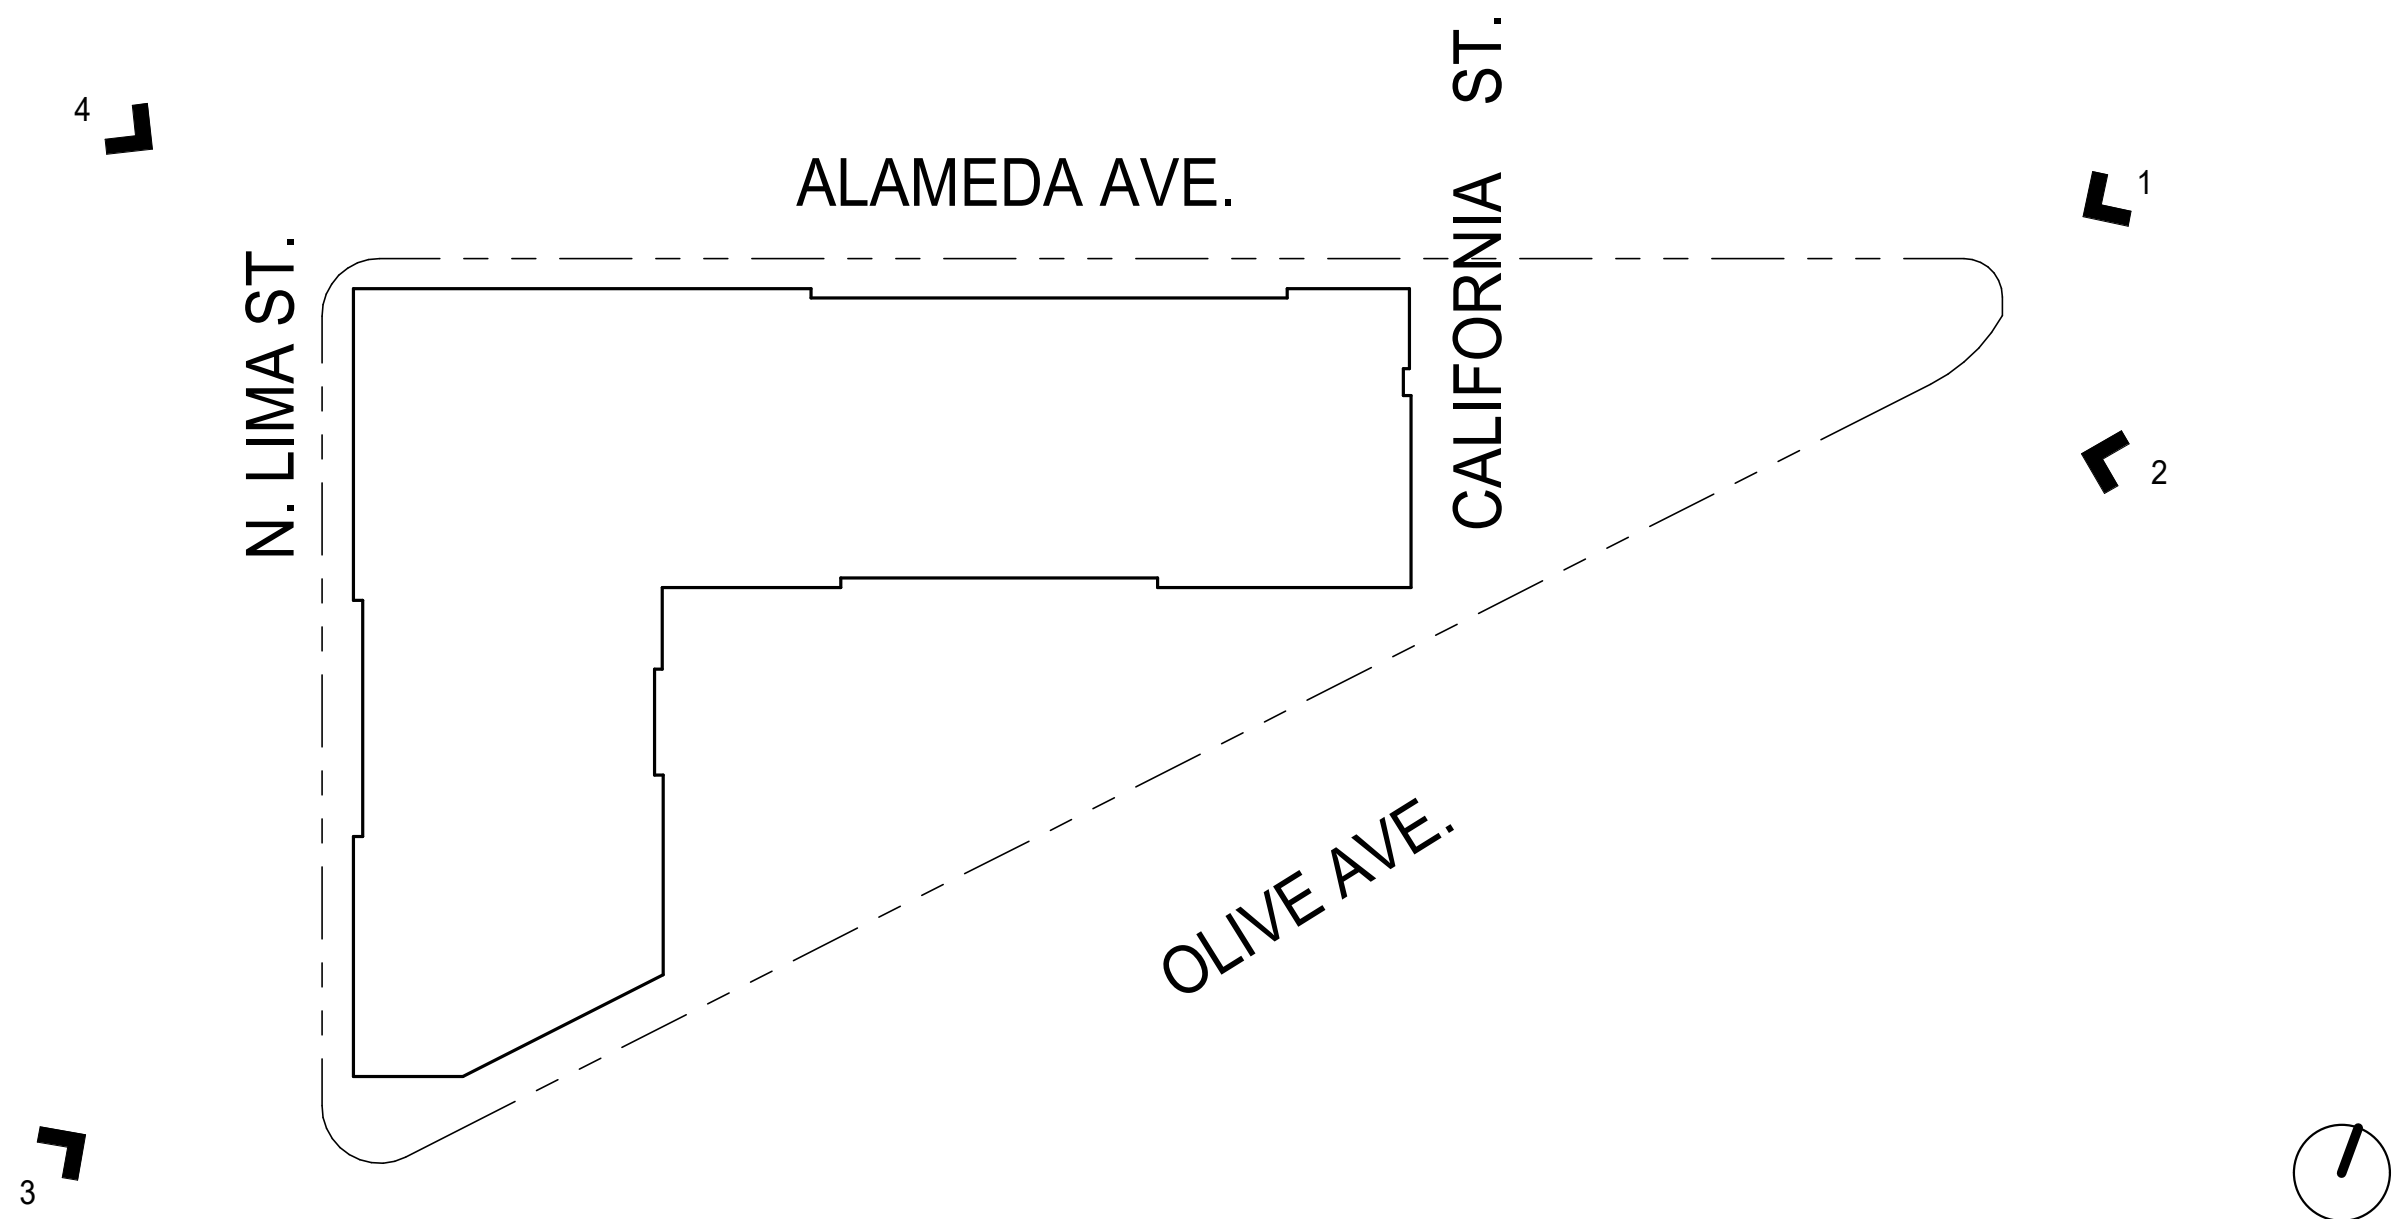

KEYPLAN - VIEWS - PHOTOS

SCALE
1" = 50'-0"

9



ALAMEDA & LIMA

SCALE
12" = 1'-0"


4



OLIVE AND LIMA

SCALE
12" = 1'-0"

3

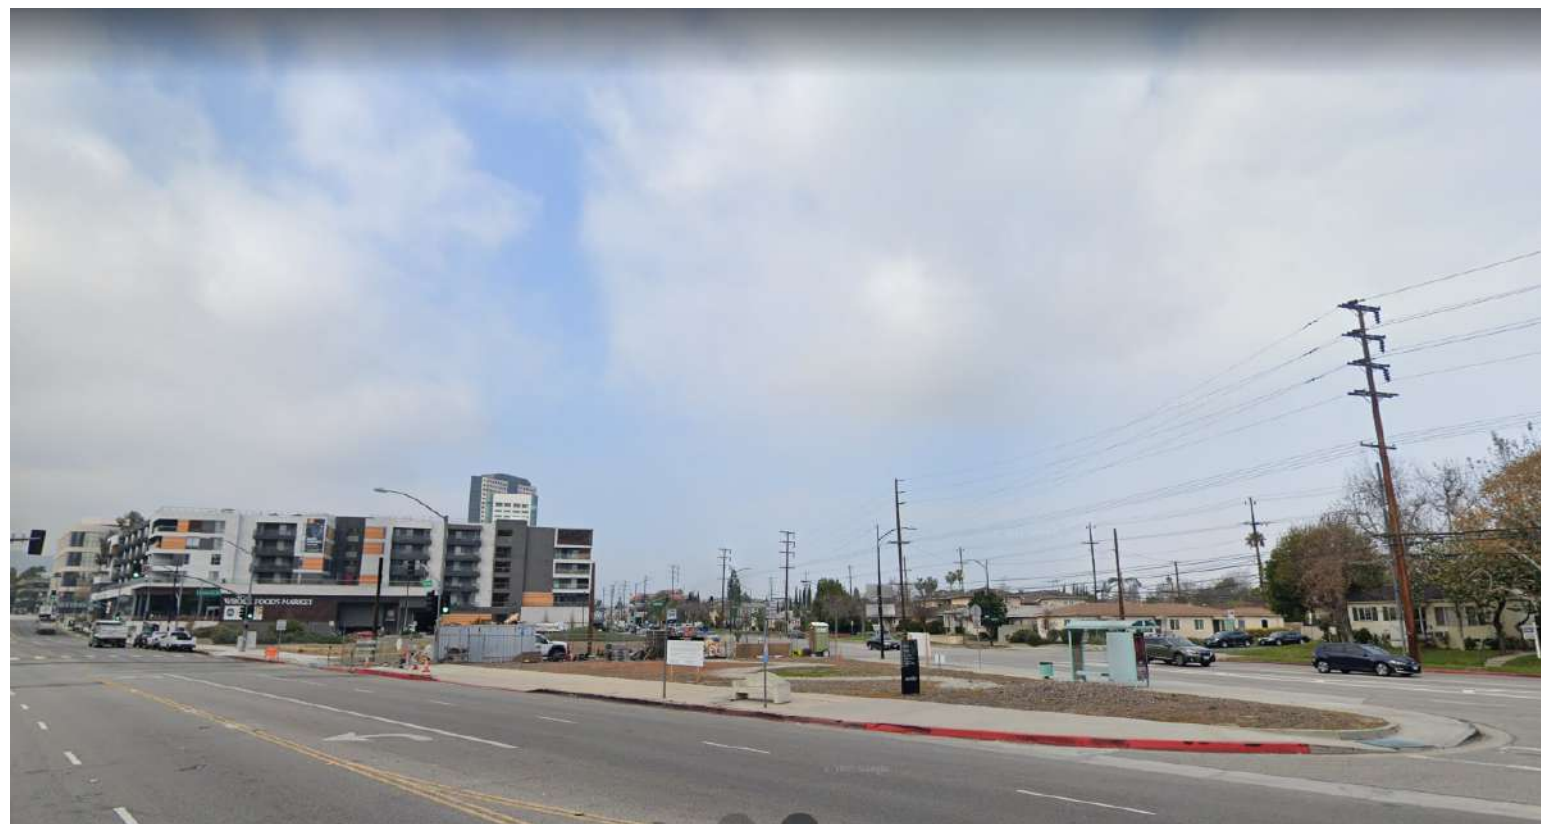

OLIVE & ALAMEDA

SCALE
12" = 1'-0"

2



ALAMEDA & OLIVE

SCALE
12" = 1'-0"

1



CONSULTANT:

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PROJECT:

BOB HOPE CENTRAL -
RESIDENTIAL
3201 W OLIVE AVE.
BURBANK, CA 91505

FLOOR/LEVEL:

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2

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PROJECT NO: 21-2779-1

DRAWN BY: RM, CS, GD CHECKED BY: SL

PROJECT MANAGER: CC

DRAWING SCALE: As indicated

SHEET SIZE: 30x42

DRAWING TITLE:

SITE CONTEXT PHOTOS

SHEET NO:

A900




BOB HOPE STATUE

BOB HOPE PARK SCALE N.T.S. 3



AERIAL RENDER SCALE N.T.S. 1

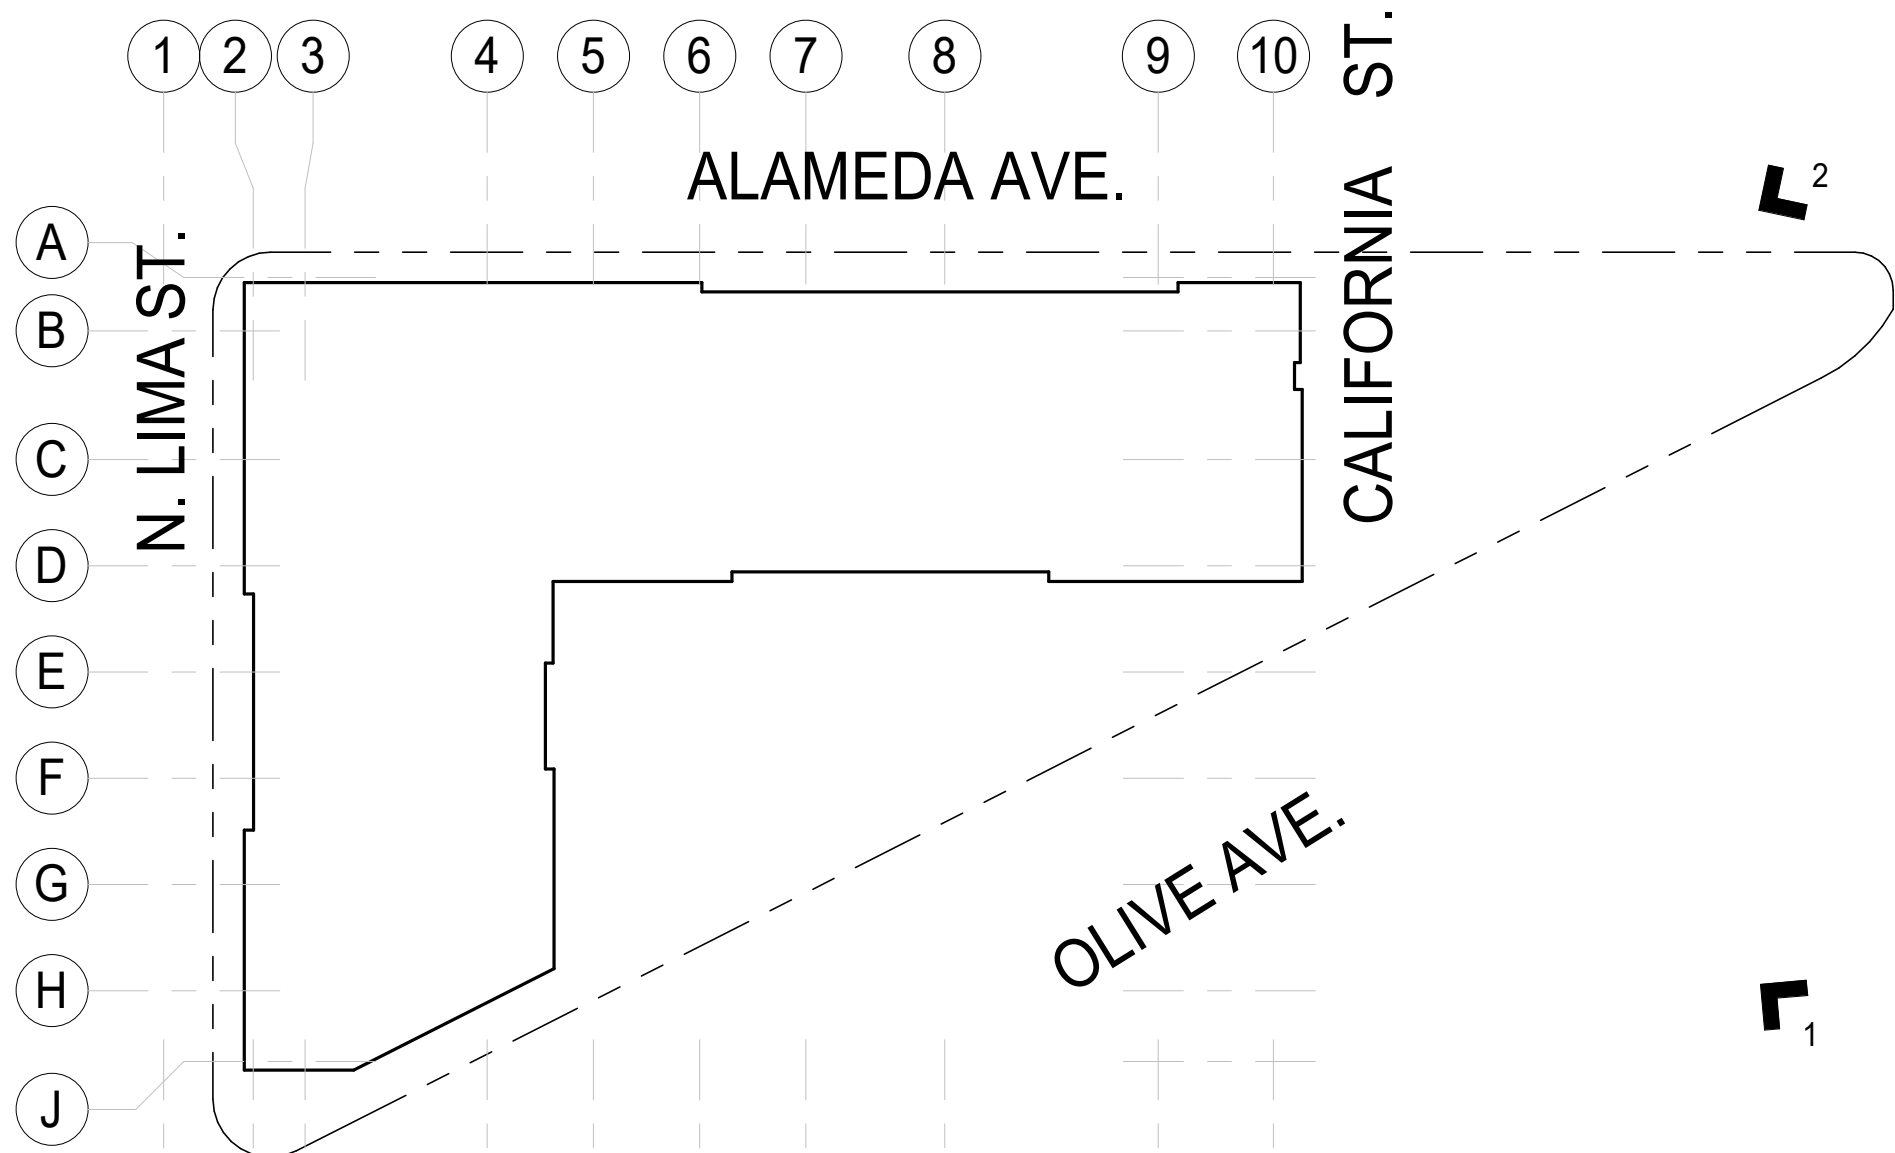

KEYPLAN - VIEWS SCALE N.T.S. 9

CONSULTANT:

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PROJECT MANAGER: CC

DRAWING SCALE: As indicated

SHEET SIZE: 30x42

DRAWING TITLE:

VIEWS AND IMAGES

SHEET NO:

A901



13 NORTHSIDE GARDEN



14 COMMUNAL SEATING AREA



15 CIRCULAR PLAZAS



16 SEATING WITH FLAGSTONE STONE



17 SCULPTURE AREA




18 PARK ENTRY GARDEN




1 RESIDENTIAL ENTRANCE



2 RAISED PLANTING AREA

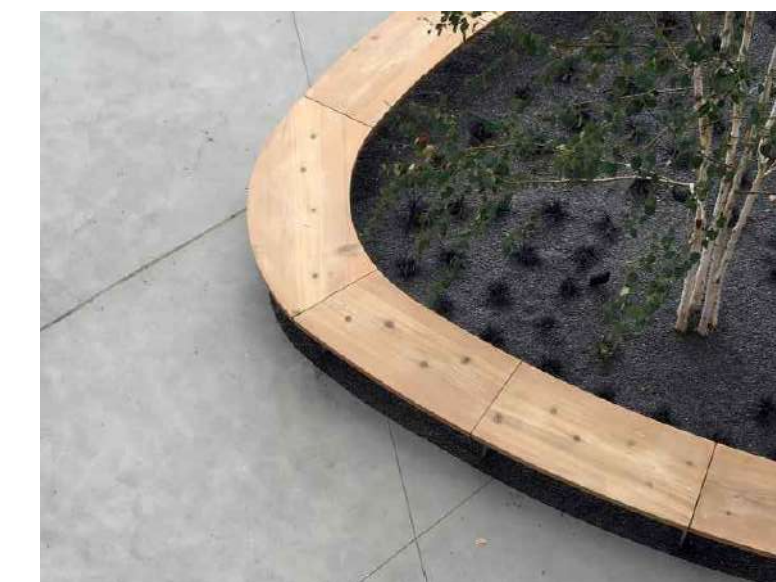

3 BANQUETTE SEATING

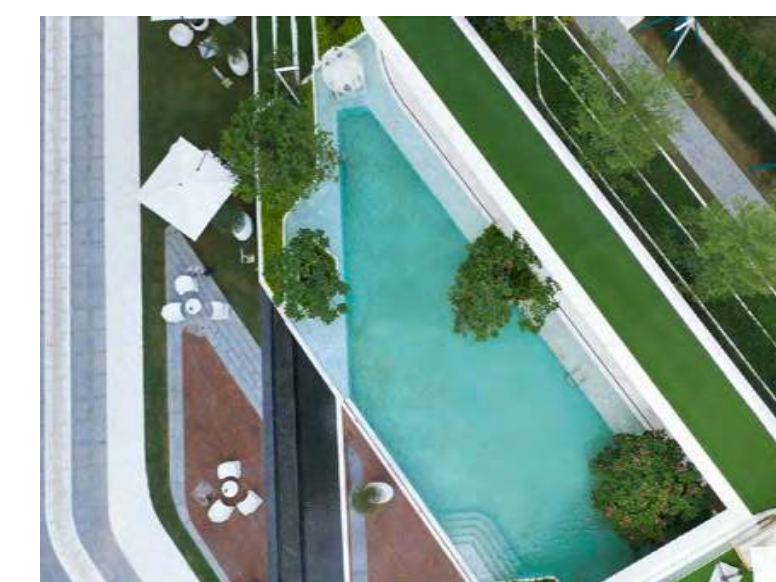

4 POOL



5 POOL WITH BAJA SHELF



12 FIREPLACE WITH SEATING AND DECK AREA



11 BUILT-IN BBQ AREA



10 POOL WOOD DECK WITH LOUNGE SEATING



9 LID PLANTER



8 ENTRY PLANTERS



7 POOL DECK LINEAR PAVERS



6 POOL ACCENT PLANTERS

No.	Description	Date
1	PLANNING DEVELOPMENT STANDARDS SUBMITTAL	06-22-2022

Project Name:

The Bob Hope Center
Residential Project
BURBANK CA

Revisions:

No.	Description	Date
	PLANNING DEVELOPMENT STANDARDS SUBMITTAL	06-22-2022

Sheet Title:

HARDSCAPE CONCEPT
PLAN

Date:

06-22-2022

Scale:

AS NOTED

Sheet Number:


L1.1



1 CAST-IN-PLACE CONCRETE W/ LITHOCRETE FINISH



2 PORCELAIN PAVERS W/ HEX TRAY AND ADJUSTABLE PEDESTAL SYSTEM

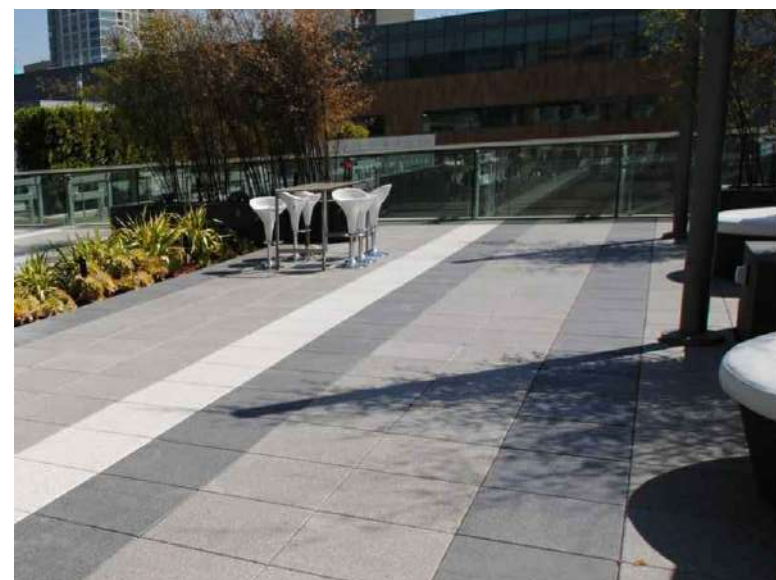


3 COMPOSITE OR HARDWOOD DECKING



4 COMPOSITE OR HARDWOOD DECKING BENCH



5 CAST-IN-PLACE CONCRETE WALLS W/ LITHOCRETE FINISH

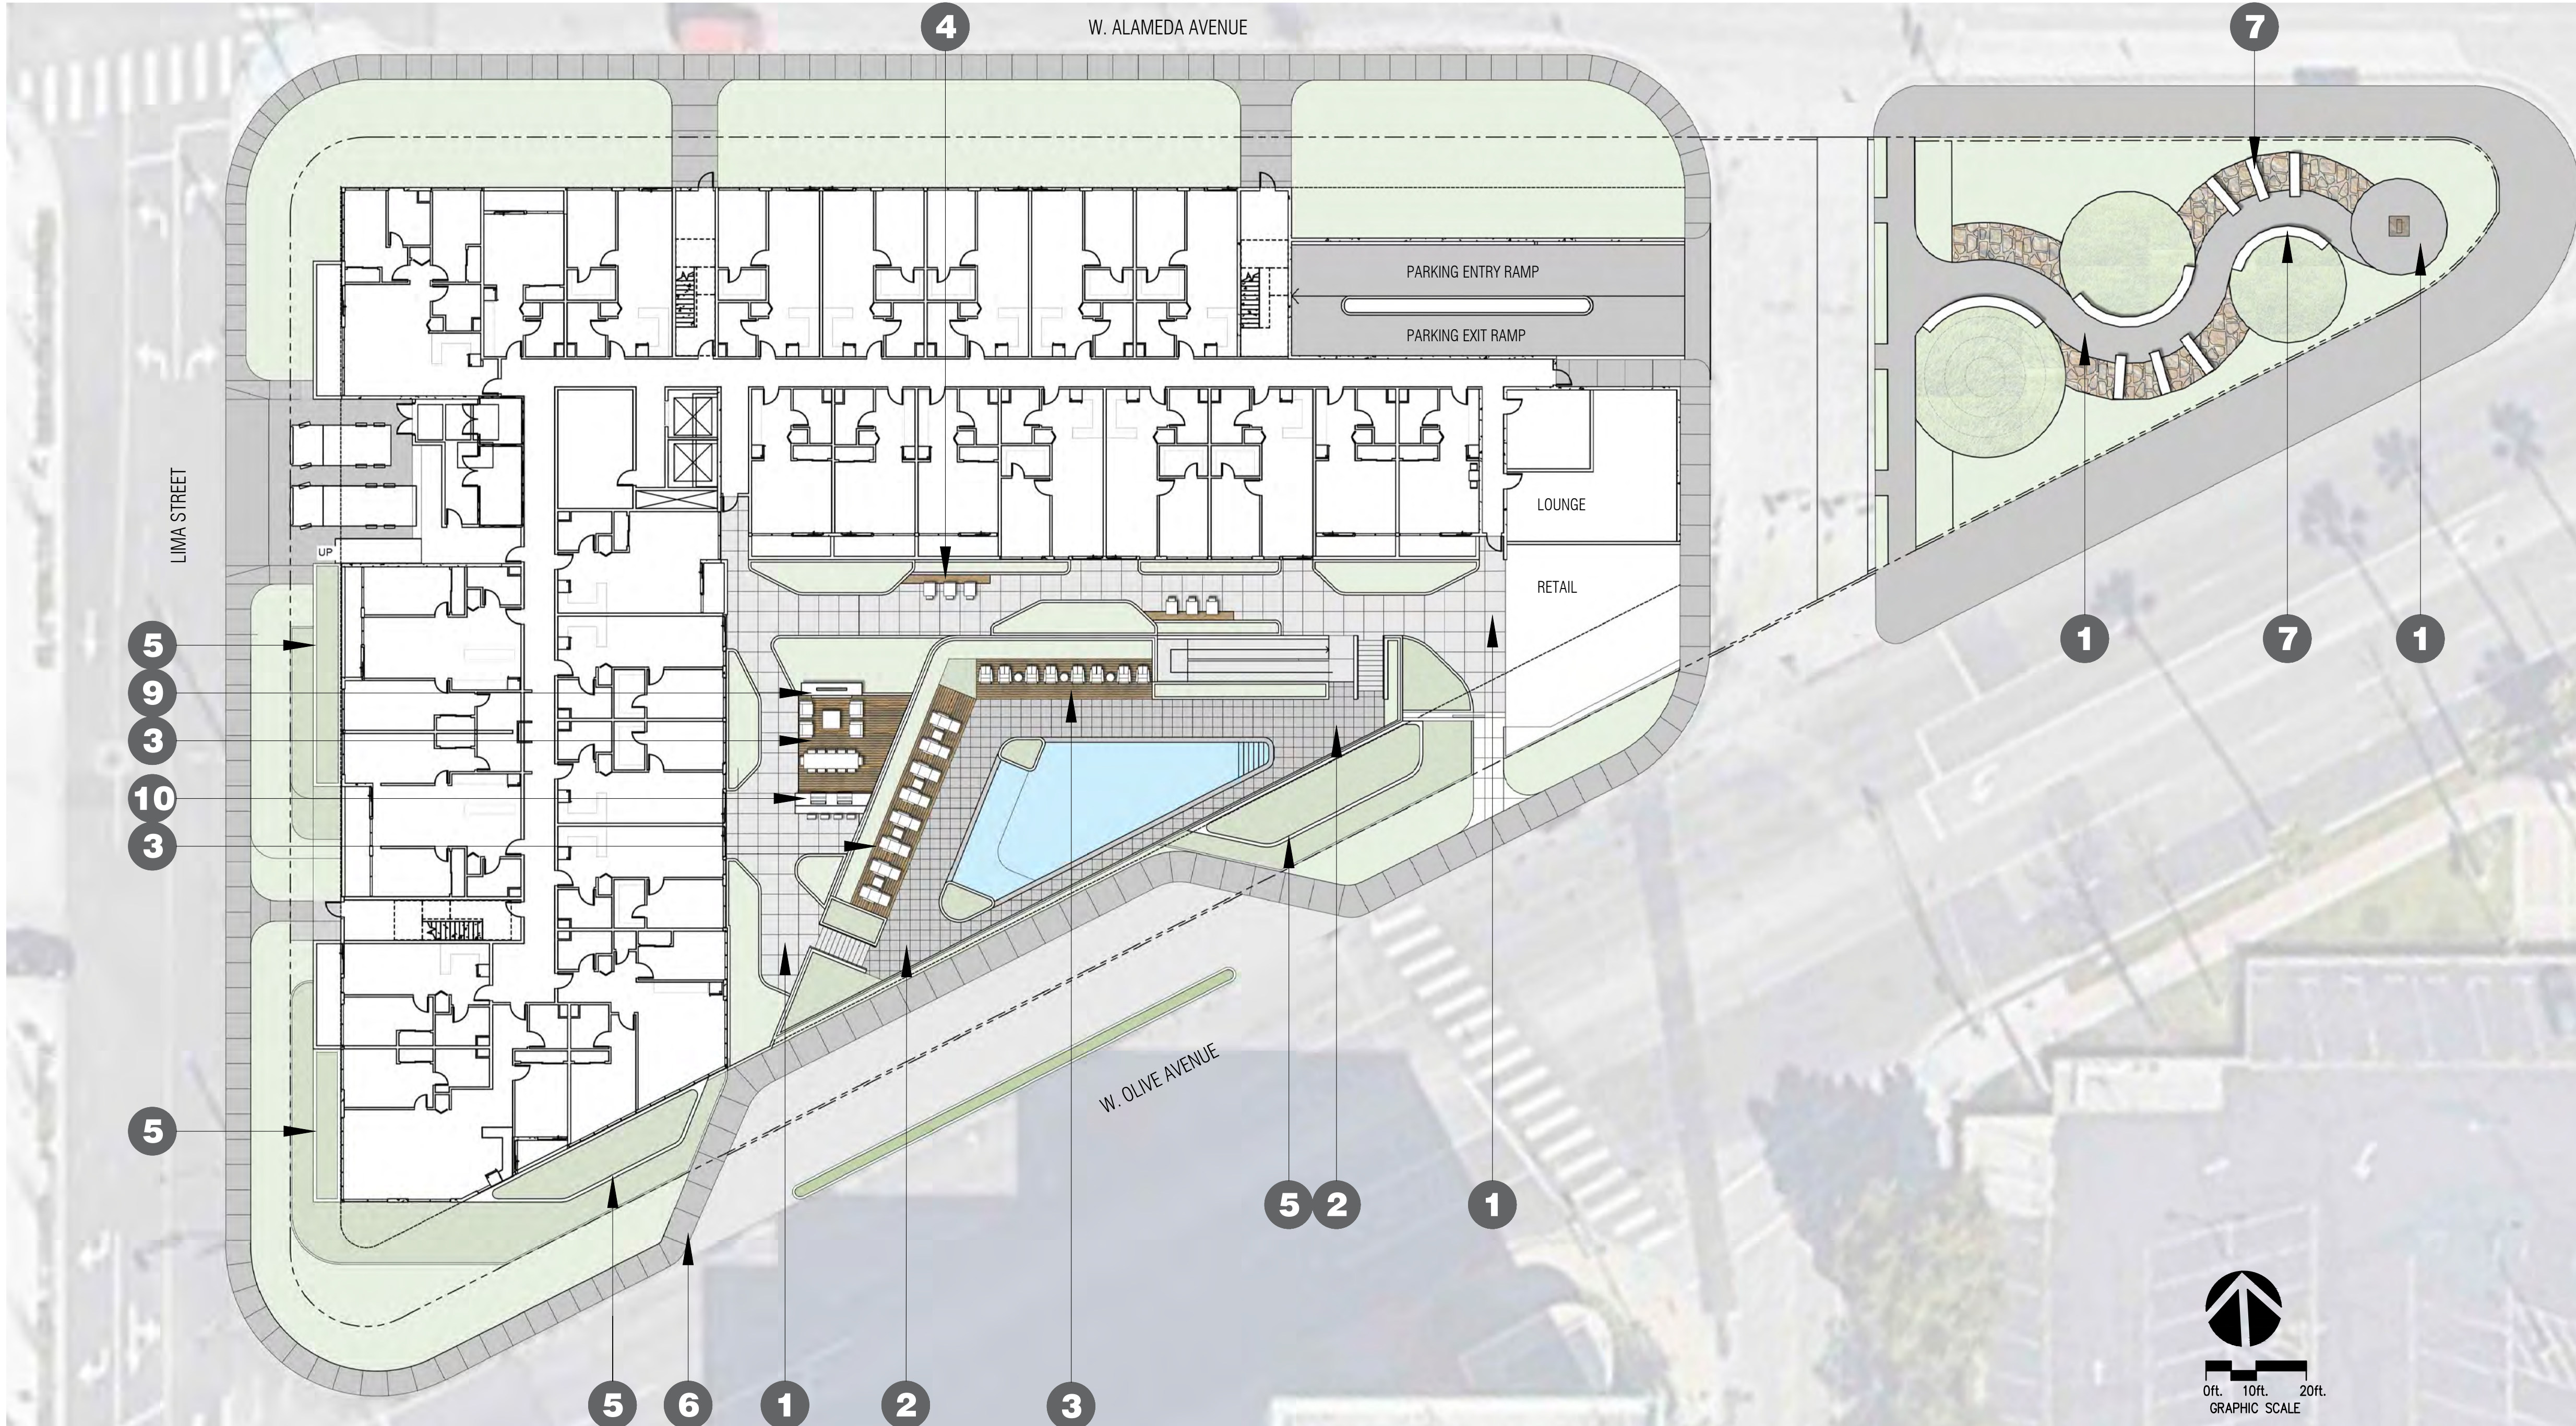

10 BUILT-IN BBQ COUNTER



9 BUILT-IN FIREPLACE



8 FLAGSTONE PAVING



7 CAST-IN-PLACE CONCRETE SEATWALLS W/ LITHOCRETE FINISH



6 CAST-IN-PLACE CONCRETE SIDEWALK W/ TOPCAST FINISH

Project Name:

The Bob Hope Center
Residential Project
BURBANK CA

Revisions:

No.	Description	Date
1	PLANNING DEVELOPMENT STANDARDS SUBMITTAL	06-22-2022

Sheet Title:


LANDSCAPE
ELEVATIONS

Date:
06-22-2022

Scale:
AS NOTED


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L1.2

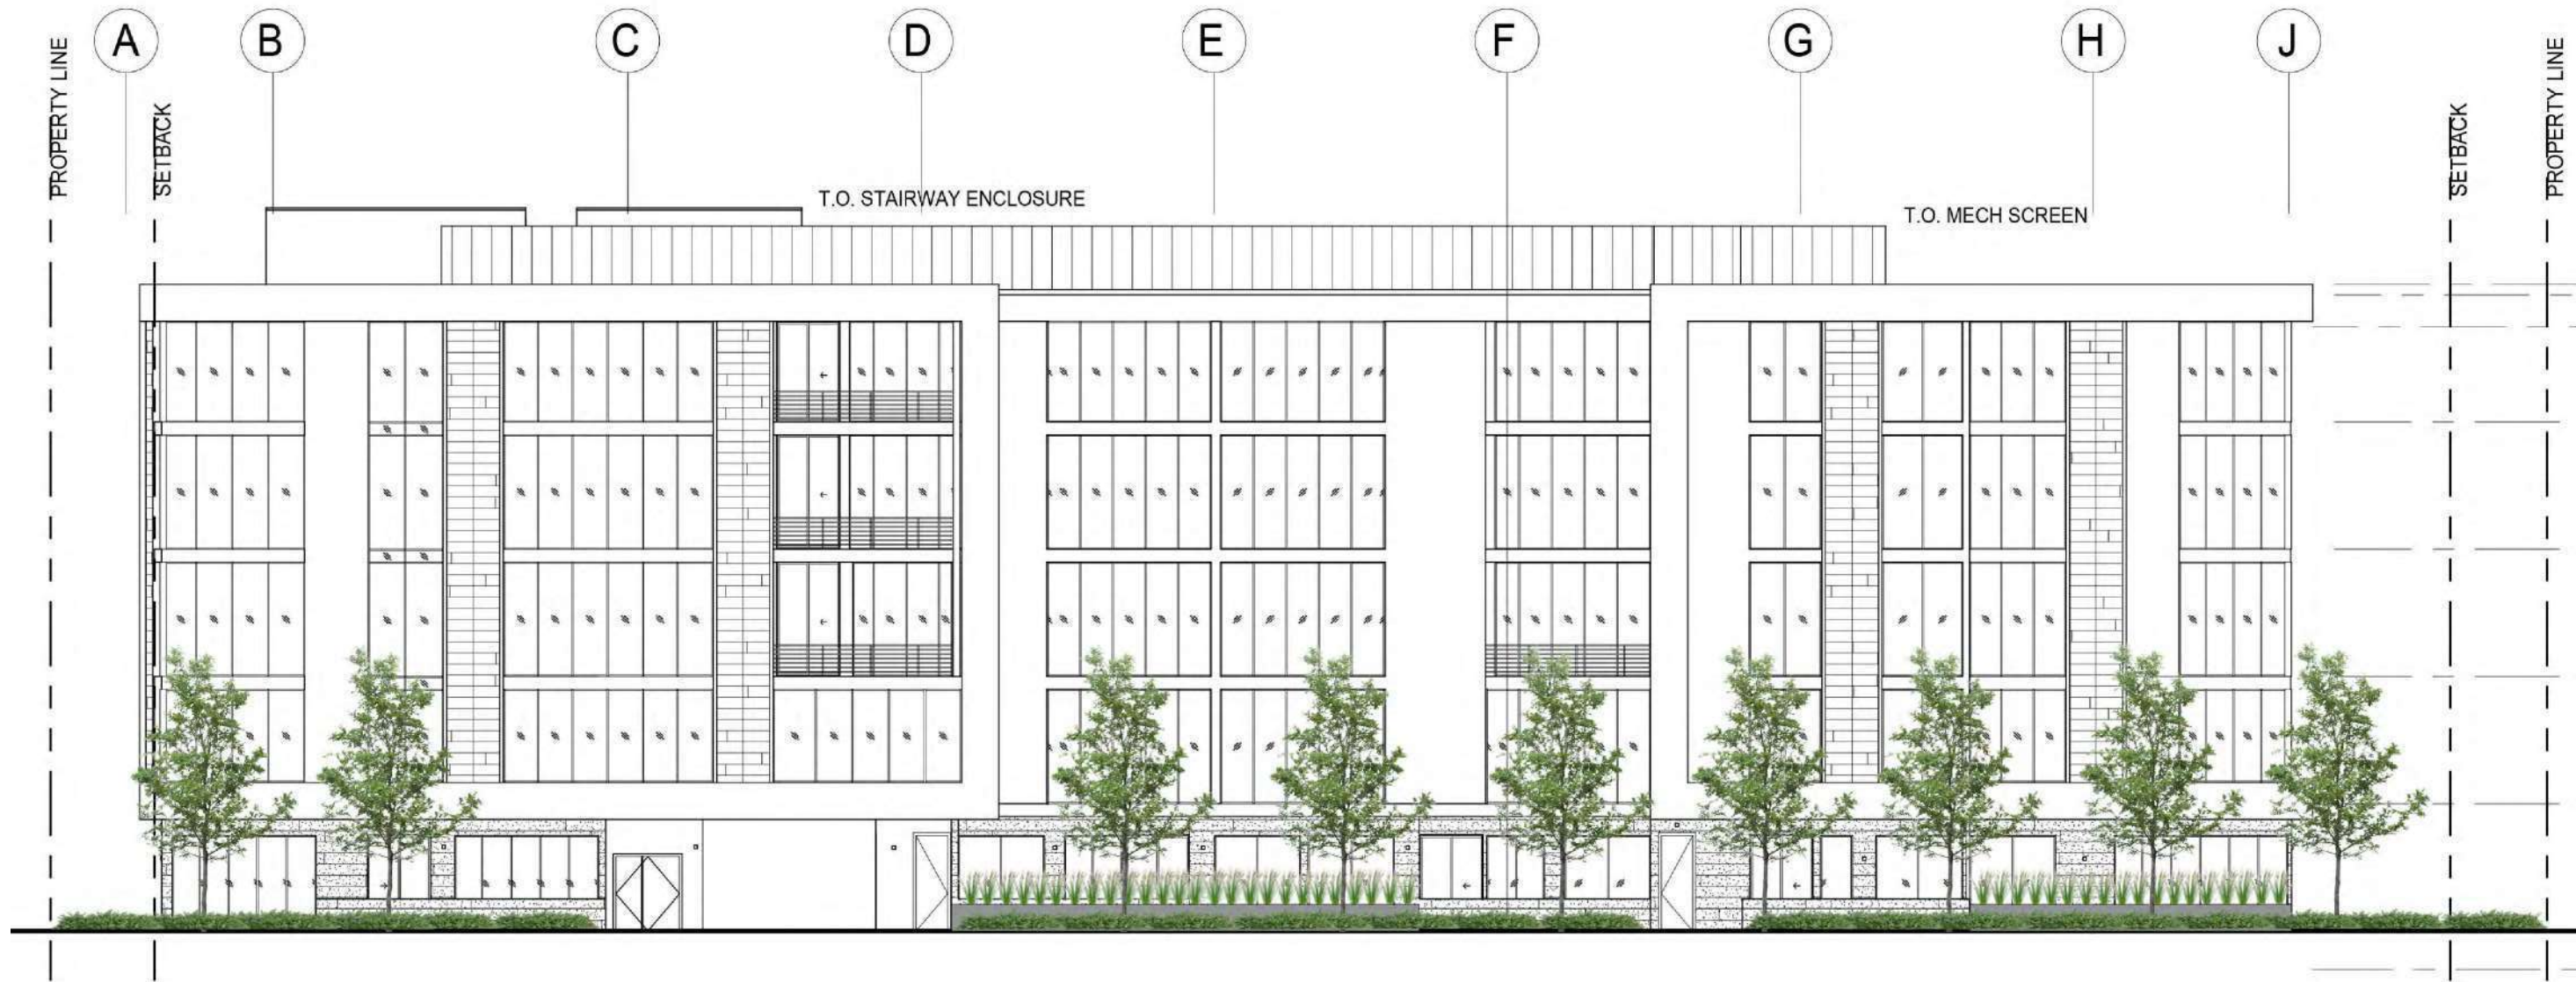


4 WEST ELEVATION - LIMA STREET

SCALE: 1/16" = 1'-0"

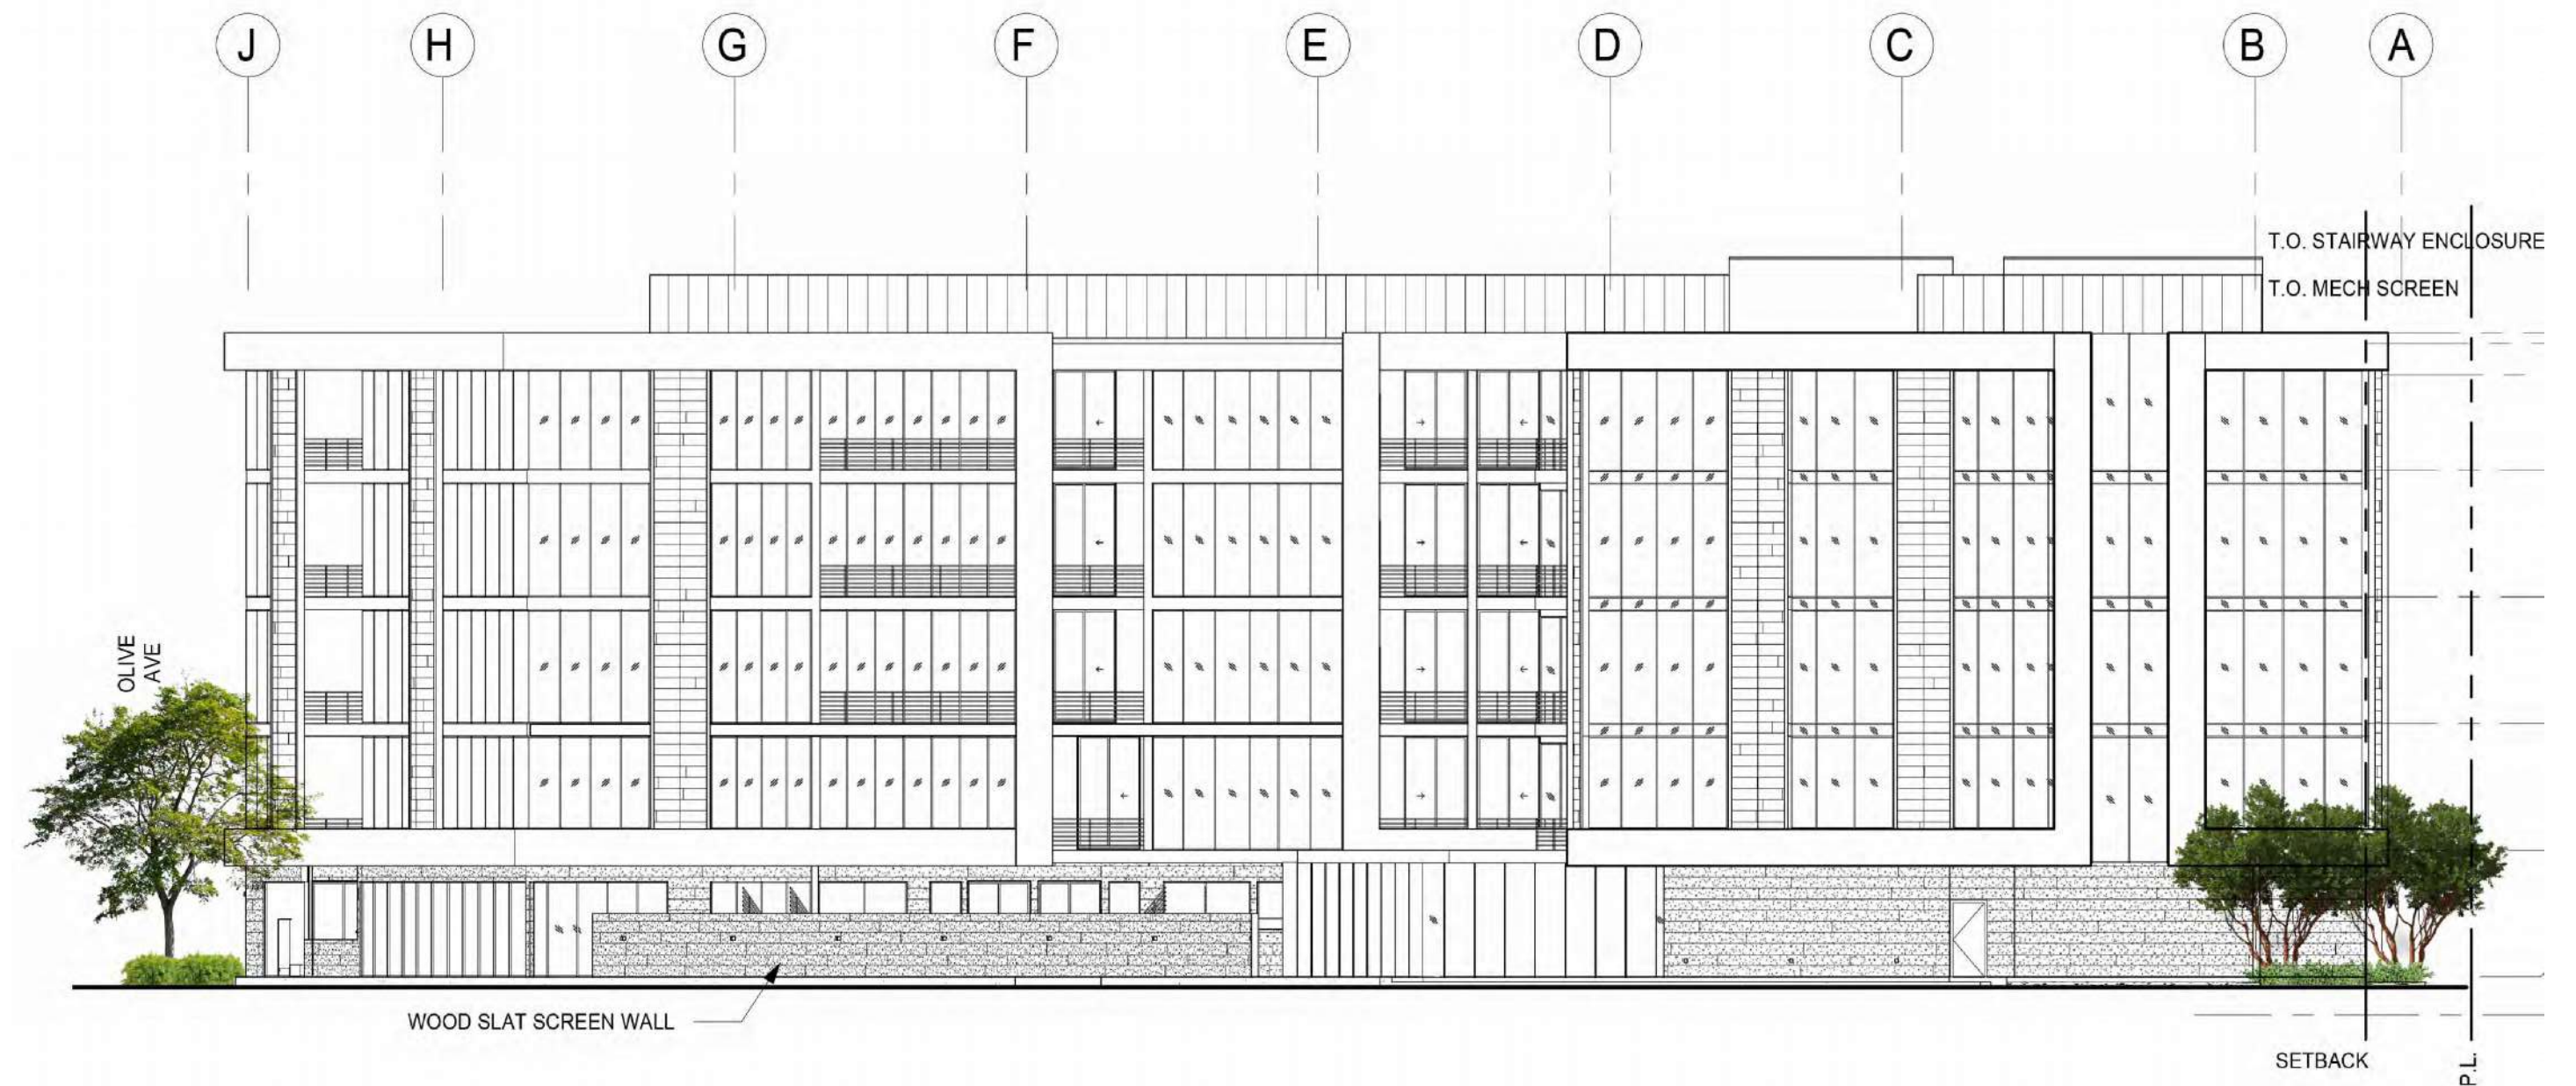


3 EAST ELEVATION - CALIFORNIA STREET

SCALE: 1/16" = 1'-0"

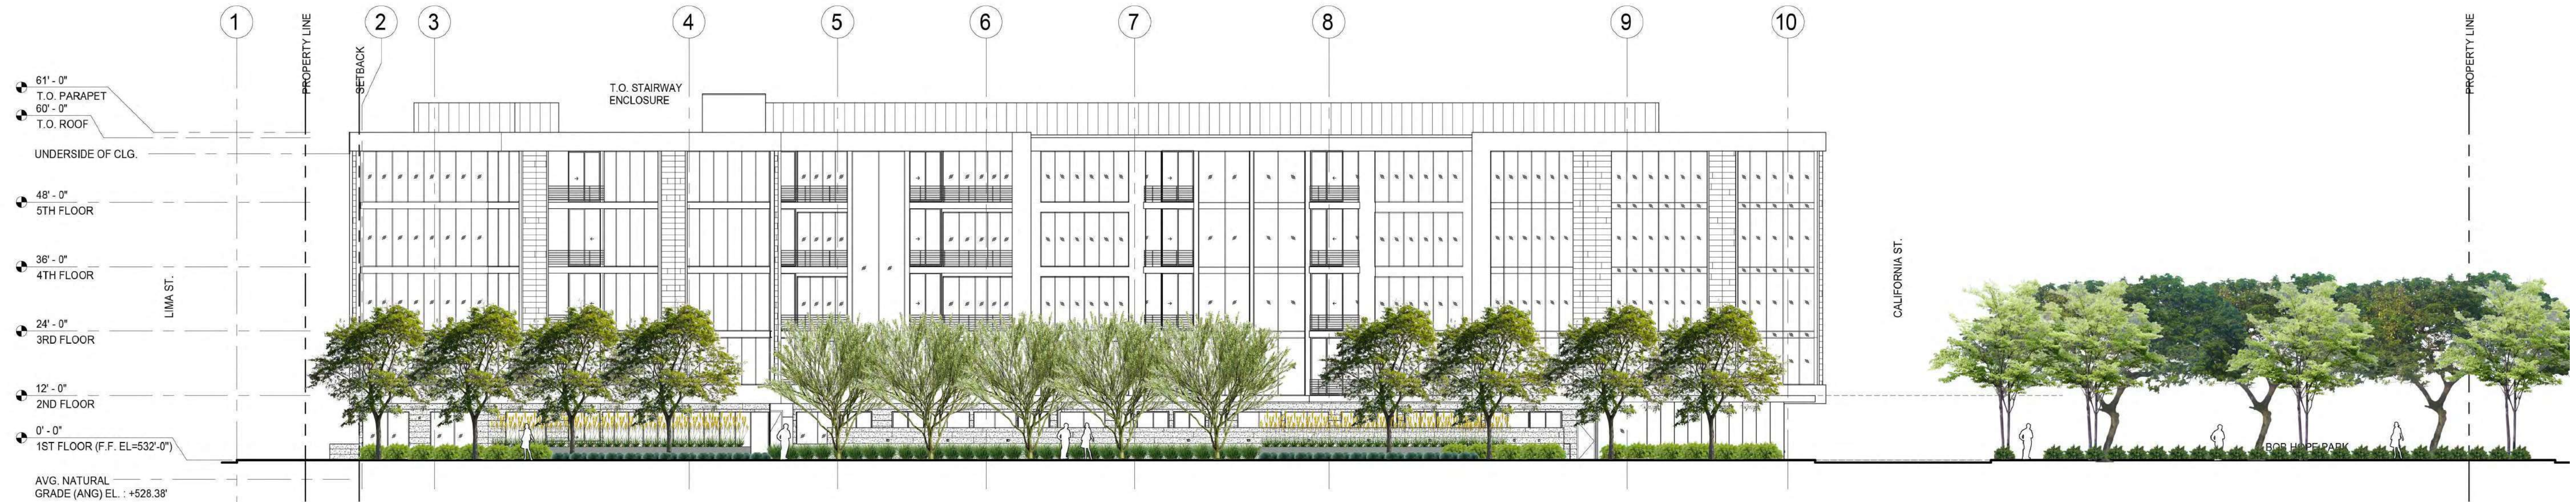

2 SOUTH ELEVATION - W. OLIVE AVENUE

SCALE: 1/16" = 1'-0"

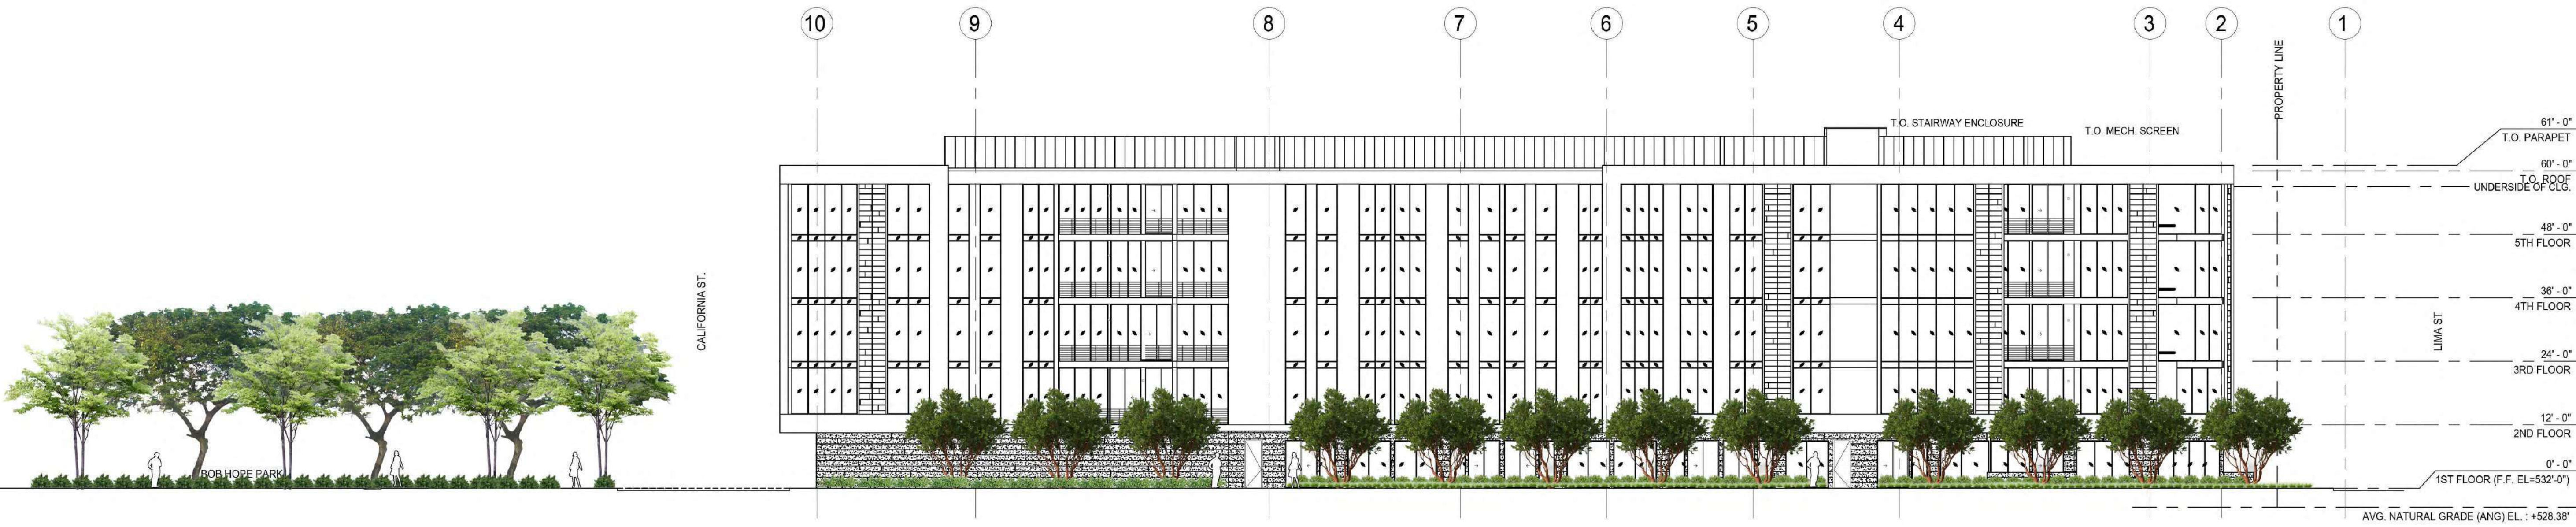

1 NORTH ELEVATION - W. ALAMEDA AVENUE

SCALE: 1/16" = 1'-0"

1 OLIVE AVENUE FRONTAGE



CERCIDIUM 'DESERT MUSEUM'
DESERT MUSEUM PALO VERDE



OLEA EUROPAEA 'WILSONII'
FRUITLESS EUROPEAN OLIVE



PROSOPIS CHILENSIS
THORNLESS CHILEAN MESQUITE



ACACIA COGNATA 'COUSIN ITT'
COUSIN ITT ACACIA



AEONIUM 'SUNBURST'
SUNBURST ADENIUM



ANIGOZANTHOS 'HARMONY'
RED-YELLOW KANGAROO PAW



BULBINE FRUTESCENS
STALKED BULBINE



CALANDRINIA SPECTABILIS
ROCK PURSLANE



COPROSMA KIRKII
KIRK'S COPROSMA



DIANELLA REVOLUTA 'LITTLE REV'
LITTLE REV FLAX LILY



FESTUCA GLAUCA 'ELIAH BLUE'
BLUE FESCUE GRASS

1 OLIVE AVE CONTINUED



FURCRAEA FOETIDA 'MEDIOPICTA'
NCN



HESPERALOE PARVIFLORA 'YELLOW'
YELLOW YUCCA



OLEA EUROPAEA 'MONTRA'
LITTLE OLLIE



PORTULACARIA AFRA 'VARIEGATA'
ELEPHANT BUSH



ROSMARINUS OFFICINALIS 'PROSTRATUS'
CREEPING ROSEMARY



VERBENA LILACINA 'DE LA MINA'
PURPLE CEDROS ISLAND VERBENA



BAUHINIA X BLAKEANA
HONG KONG ORCHID TREE



CASSIA LEPTOPHYLLA
GOLD MEDALLION TREE



ALOE 'HERCULES'
HERCULES ALOE



ALPINIA ZERUMBET 'VARIEGATA'
VARIEGATED SHELL GINGER



ASPARAGUS DENSIFLORUS 'MYERSII'
FOXTAIL FERN



LOMANDRA CONFERTIFOLIA 'SHORTY'
DWARF MAT RUSH



LOTUS BERTHELOTII
PARROT'S BEAK



TRADESCANTIA SPATHACEA
MOSES IN THE CRADLE



ZAMIA FURFURACEA
SAGO CYCAS

3 RESIDENTIAL DECK



KOELREUTERIA BIPINNATA
CHINESE FLAME TREE



ABELIA GRANDIFLORA 'RADIANCE'
RADIANCE ABELIA



BOUGAINVILLEA 'LA JOLLA'
NCN



LANTANA CAMARA 'SPREADING SUNSET'
SPREADING SUNSET LANTANA



LOTUS BERTHELOTII
PARROT'S BEAK



NANDINA DOMESTICA 'LEMON LIME'
HEAVENLY BAMBOO



PITTOSPORUM CRASSIFOLIUM 'NANA'
DWARF KARO




POLYGALA FRUTICOSA 'PETITE BUTTERFLIES'
SWEET PEA SHRUB



RHAMPHILEPIS UMBELLATA 'MINOR'
DWARF YEDDO HAWTHORN

KEY MAP

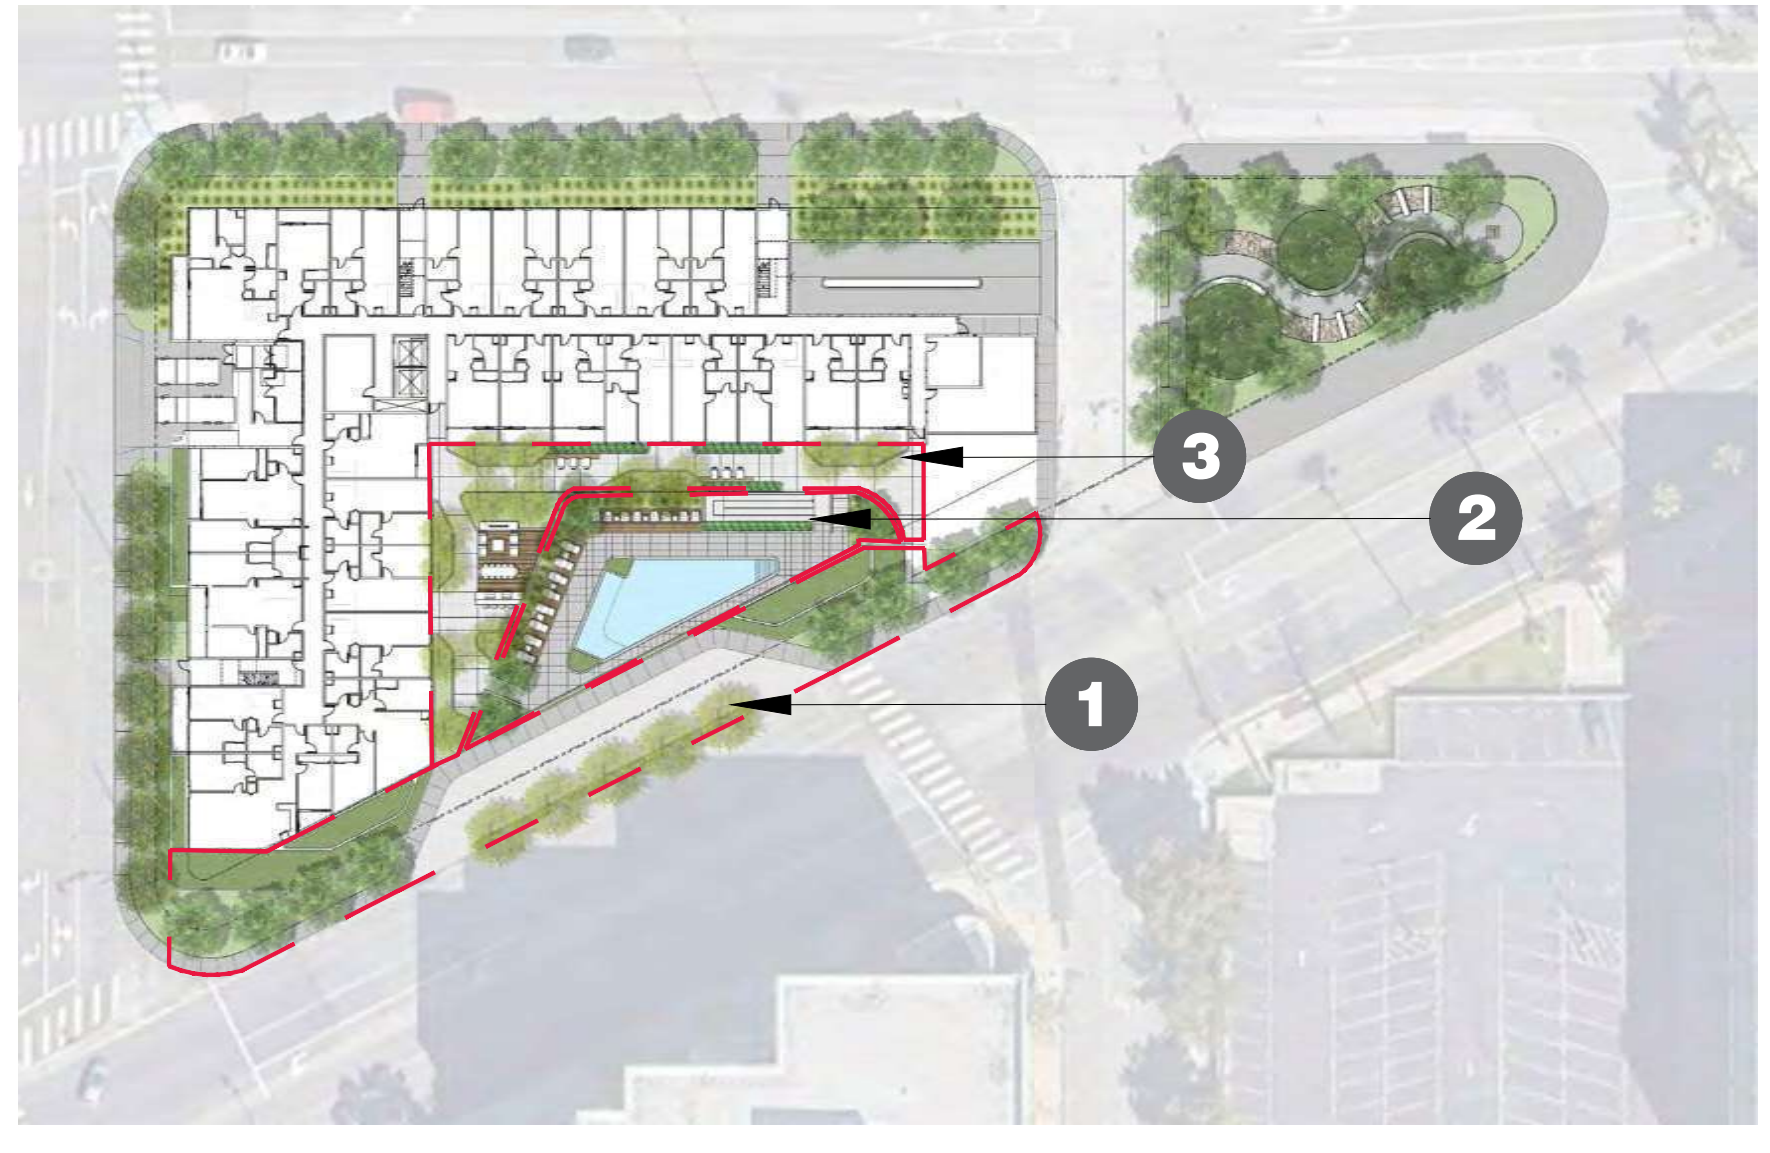

No.	Description	Date
1	PLANNING DEVELOPMENT STANDARDS SUBMITTAL	06-22-2022

4 LIMA STREET FRONTAGE AND LID PLANTERS



MAYTENUS BOARIA
MAYTEN TREE



PYRUS CALLERYANA 'BRADFORD'
BRADFORD PEAR



ACHILLEA 'MOON SHINE'
YARROW



ALOGYNE HUEGLII
BLUE HIBISCUS



BACCHARIS PILULARIS 'PIGEON POINT'
DWARF COYOTE BRUSH



CHONDROPETALUM TECTORUM
SMALL CAPE RUSH



LEYMUS CONDENSATUS 'CANYON PRINCE'
CANYON PRINCE WILD RYE



LOMANDRA HYSTRIX 'TROPIC BELLE'
TROPIC BELLE MAT RUSH



ZEPHRANTHUS CANDIDA
RAIN LILY

5 ALAMEDA AVE NORTH SIDE



ARBUTUS 'MARINA'
STRAWBERRY TREE



RHUS LANCEA
AFRICAN SUMAC

5 ALAMEDA AVENUE CONTINUED



CAREX DIVULSA
EUROPEAN GREY SEDGE



CARISSA MACROCARPA 'GREEN CARPET'
NATAL PLUM



DIETES VEGETA 'VARIEGATA'
VARIEGATED FORTNIGHT LILY



MUHLENBERGIA LINDHEIMERI
LINDHEIMER'S MUHLY



PENNISETUM SPATHIOLATUM
SLENDER VELD T GRASS



WESTRINGIA FRUTICOSA 'MORNING LIGHT'
COAST ROSEMARY

6 BOB HOPE PARK



CINNAMOMUM CAMPHORA
CAMPHOR TREE



SPATHODEA CAMPANULATA
AFRICAN TULIP TREE



TIPUANA TIPU
TIPU TREE

6 BOB HOPE PARK, CONTINUED



COREOPSIS LANCEOLATA 'EARLY SUNRISE'
DOUBLE FLOWERED YELLOW TICKSEED



DIETES BICOLOR
FORTNIGHT LILY



FESTUCA RUBRA 'MOLATE'
CREEPING RED FESCUE GRASS



HEBE 'GIBBY'
GIBBY HEBE




OLEA EUROPAEA 'MONTRA'
LITTLE OLLIE



LOMANDRA 'PLATINUM BEAUTY'
PLATINUM BEAUTY MAT RUSH

KEY MAP

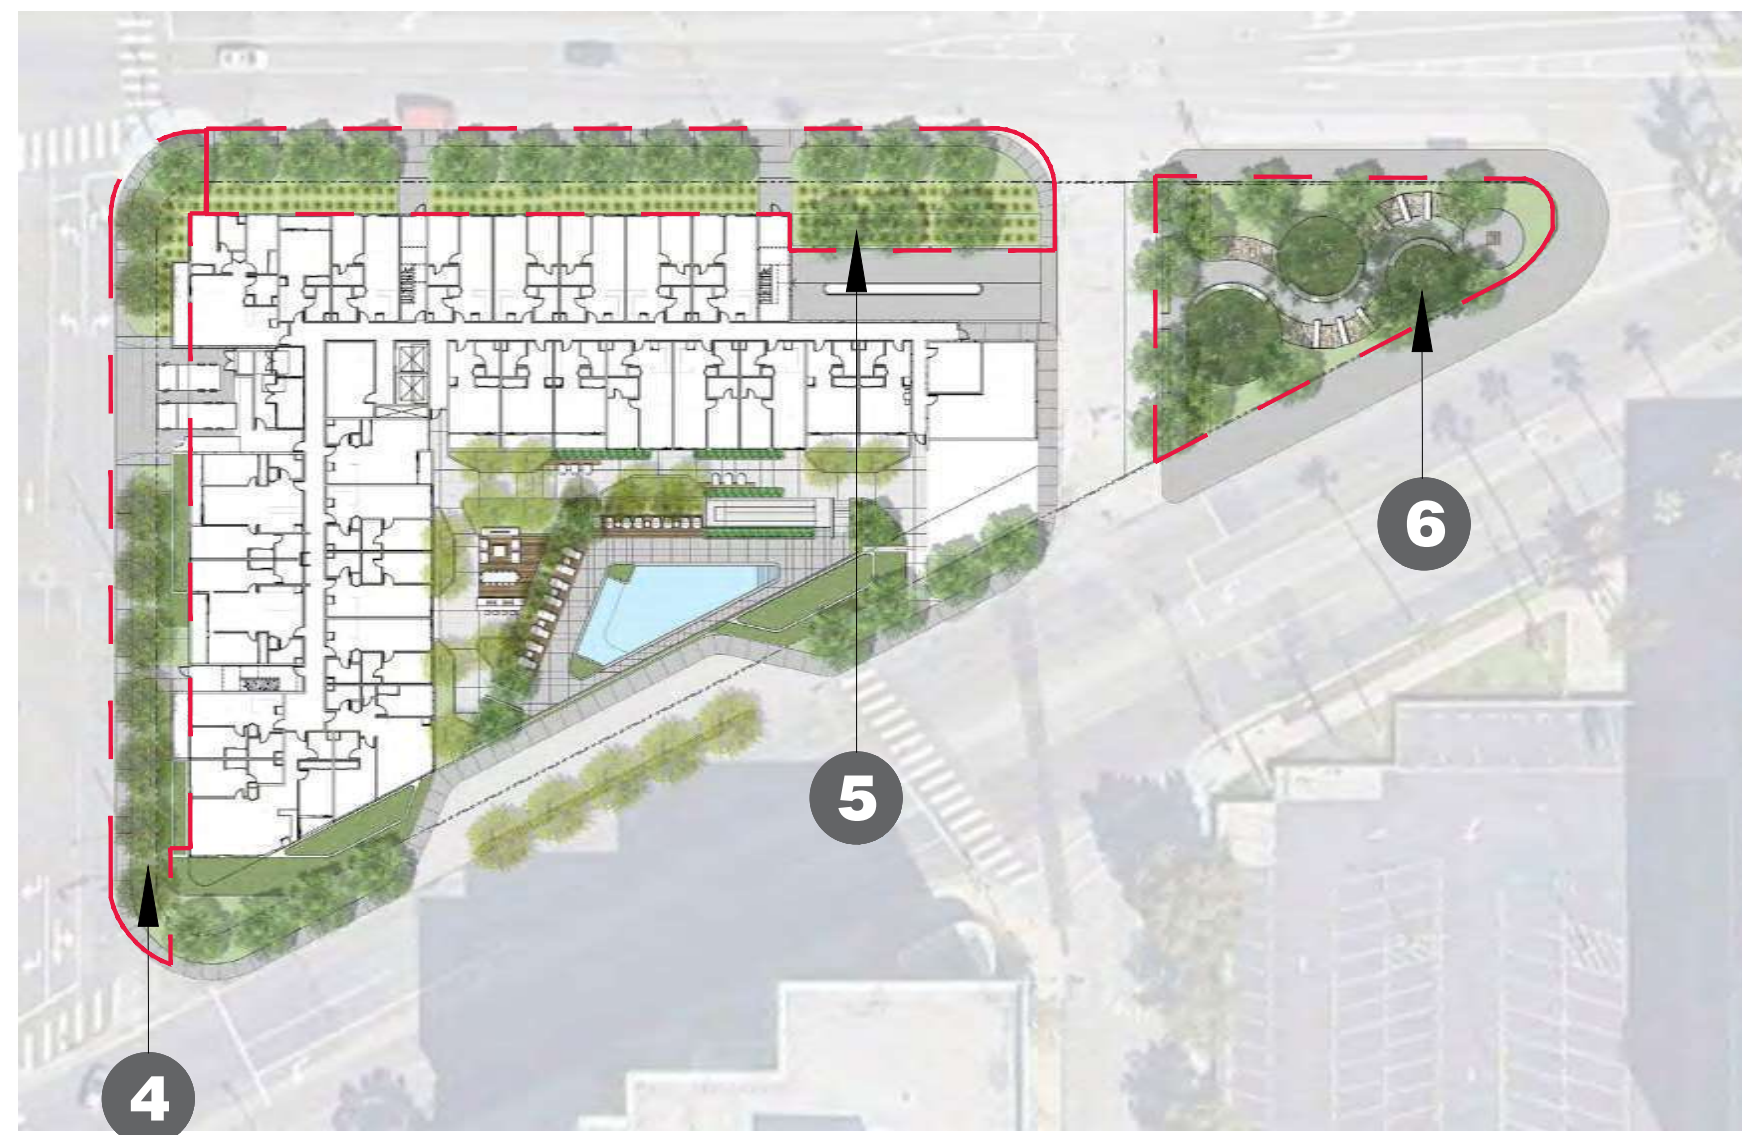

Project Name:

The Bob Hope Center
Residential Project
BURBANK CA

Revisions:

No.	Description	Date
1	PLANNING DEVELOPMENT STANDARDS SUBMITTAL	06-22-2022

Sheet Title:

PLANT IMAGES

Date:
06-22-2022

Scale:
AS NOTED

Sheet Number: