

LINE OF FIRST
LEVEL

PROPERTY LINE 69'

(E)POOL

<u>4:12</u> →

→ DRIVEWAY —

/ | _ (E)DRIVEWAY \(\sigma \)

(E)BLOCK WALLS -

<u>4:12</u>

EXISTING SITE PLAN 1/8" = 1'-0"

─ DRIVEWAY —

 \leftarrow (E)DRIVEWAY $\stackrel{\searrow}{\sim}$

PROPERTY LINE 69'


 \leftarrow (E)SPA $\stackrel{\triangle}{-}$


(E)POOL

(E)BLOCK WALLS —

<4:12

WALLS. REMODEL EXISTING FIRST FLOOR 1373 SQFT 2ND FLOOR ADDITION

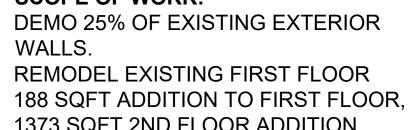

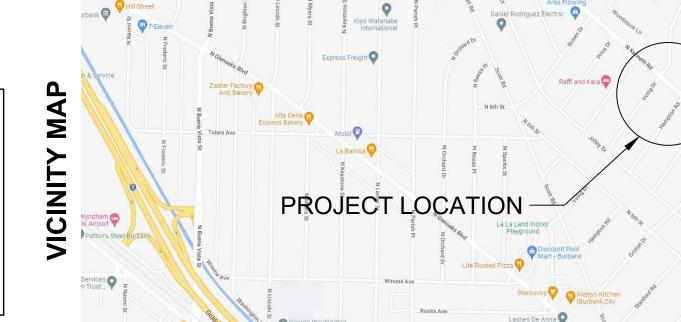

SCOPE OF WORK:

DEMOLITION 52 LINEAR FT

25%

				NOWBER OF STORIES				
TRAC	K		15220	BUILDING HEIGHT	24			
LOT	LOT		4	HIGH FIRE ZONE	ΥE			
APN		2471-013-004		HILLSIDE ZONE	Y			
BLOC	K			SCOPE OF	: WORK			
FA	R CALC	CULAT	TION	EXISTING FIRST FLOO				
	7,500	* 0.4 =	3000	EXISTING 2 CAR GARA				
ALLOWABLE		0.3 =	130.5	EXIOTING 2 OVIIC OVIIC				
TOTAL ALLOWABLE		3131	SQFT	NEW 2 CAR GARAGE ADDITION				
PROVIDED 143+148		487+1373+75 = 3078 SQFT		NEW FIRST FLOOR ADDITION				
PROVIDED		3078 < 3131 = OK		NEW FRONT PORCH ADDITION				
HARDS	CAPE (CALC	JLATION	NEW FIRST FLOOR PA	TIO			
ALLOWABLE		_	FRONT YARD 1,795 SQFT	NEW SECOND FLOOR AD	DITION			
LANDSCAPE 201 + 45 + 750		= 996 SQFT	NEW SECOND FLOOR BAI	CONY				
HARDSCAPE	484 + 2	208 + 107	7 = 799 SQFT					
PROVIDED	799 < 1,795 = OK			TOTAL GARAGE				
DEMOLITION				TOTAL GARAGE W/400 SQF	Γ CREDIT			
	EXTERIO	R WALLS	S	TOTAL FIRST FLOOR	₹			
FXISTING				TOTAL SECOND FLOOR				
RESIDENCE	205 LINI	EAK FI	100%	TOTAL HABITABLE				

SHEET INDEX

A0.2 FAR DIAGRAM + PROJECT INFO

A0.4 SETBACK AND FRONTAGE CALC

A1.1 EXISTING/DEMO FLOOR PLAN

A2.1 NEW 1ST LEVEL FLOOR PLAN

A2.2 NEW 2ND LEVEL FLOOR PLAN

A2.4 DOOR AND WINDOW SCHEDULE

A3.3 MATERIAL PALETTE + RENDER

LEGAL DESCRIPTION

206 N KENNETH RD

A0.3 PHOTO OF PROJECT SITE

A0.5 RADIUS MAILING MAP

A1.2 EXISTING ROOF PLAN

A3.0 EXISTING ELEVATIONS

A2.3 NEW ROOF PLAN

A3.1 NEW ELEVATIONS


A3.2 NEW ELEVATIONS

L1.1 LANDSCAPE PLAN

ADDRESS

A0.1 SITE PLAN + PROJECT INFORMATION

PROJECT DESCRIPTION					
ZONING	R1YY				
OCCUPANCY	R1 / U1				
YEAR BUILT	1953				
CONSTRUCTION TYPE	,	VB			
FIRE SPRINKLERED	1	NO			
LOT SIZE	7,	935			
EXISTING HOUSE SIZE	1:	299			
EXISTING GARAGE SIZE	3	395			
FAR (ALLOWABLE)	40%	= 3,174			
LOT COVERAGE (ALLOWABLE)	50% =	3,967.5			
NUMBER OF STORIES	2				
BUILDING HEIGHT	24'-8"				
HIGH FIRE ZONE	Y	YES			
HILLSIDE ZONE	YES				
SCOPE	OF WORK	(
EXISTING FIRST F	1,299				
EXISTING 2 CAR G	395				
NEW 2 CAR GARAGE	148				
NEW FIRST FLOOR A	188				
NEW FRONT PORCH	170				
NEW FIRST FLOOF	75				

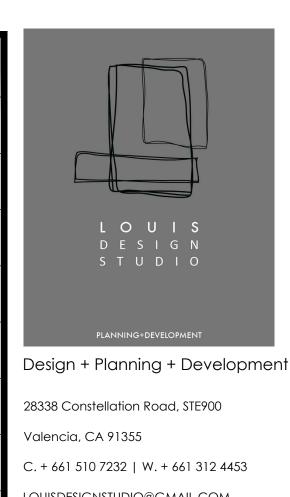

LOUISDESIGNSTUDIO@GMAIL.COM

CONSULTANT'S STAME DESCRIPTION

PROJECT TITLE:

91504

1373

58

543

143

1562

1373

3078

Residential Remodel 2306 N KENNETH RD

BURBANK, DATE: March 2022

L. Romero

DRAWN BY: R. Duben

22-0005876-HDP

DESIGNED BY:


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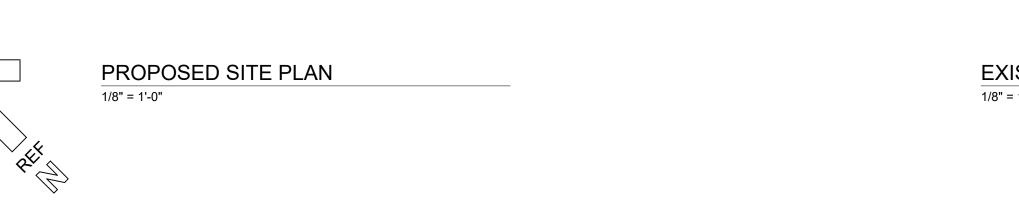
SITE PLAN + **PROJECT**

INFORMATION

SHEET NUMBER:

A0.1



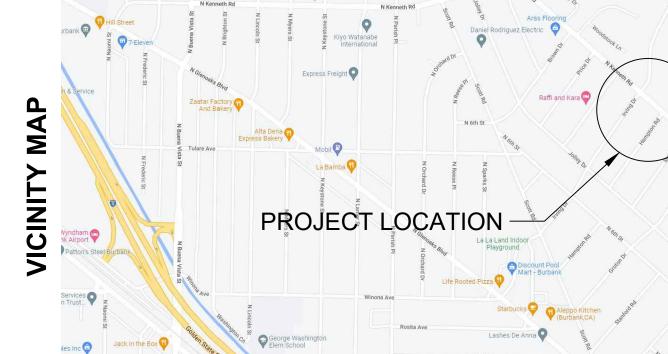


← (E)SIDEWALK >






KENNETH ROAD

4:12→

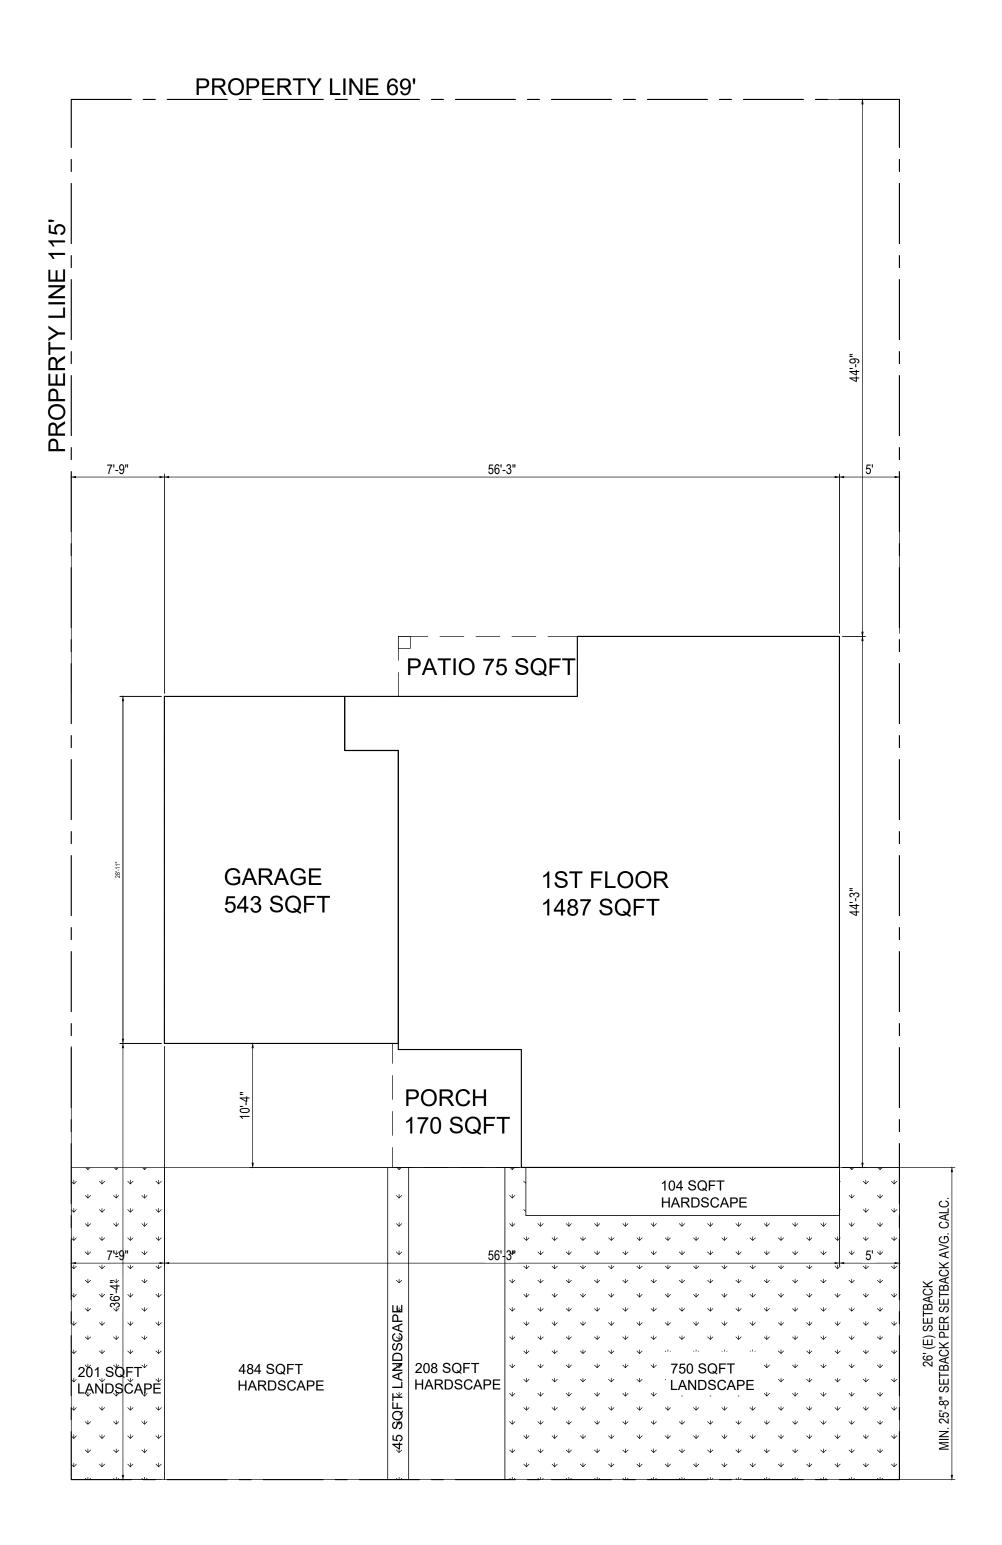


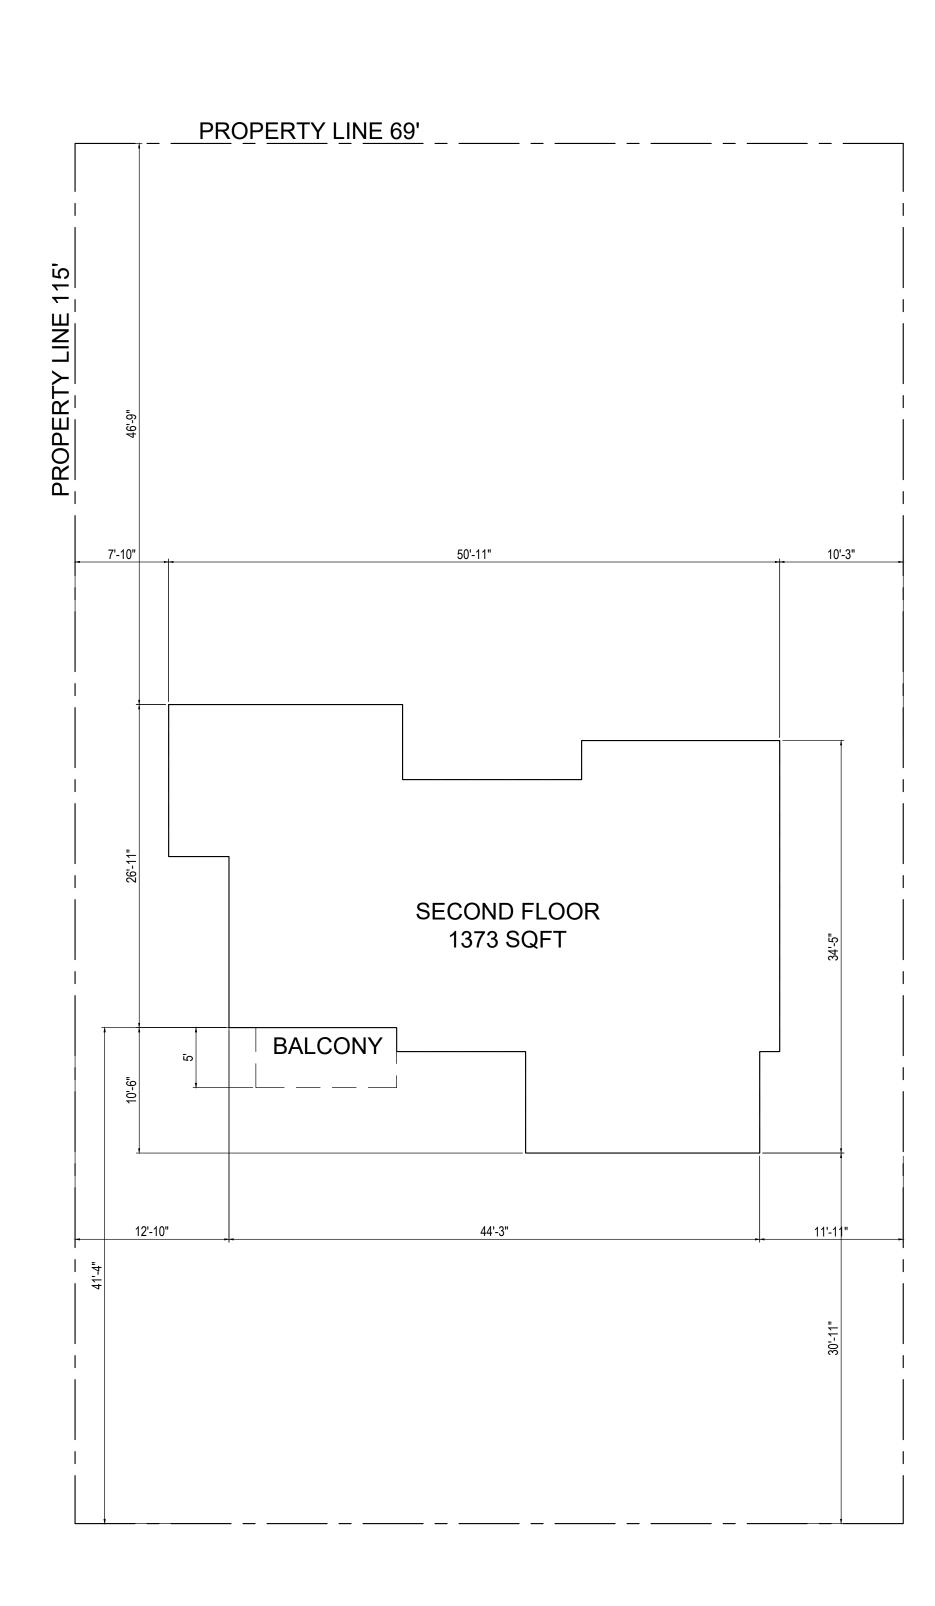

SCOPE OF WORK	(
EXISTING FIRST FLOOR	1,299
EXISTING 2 CAR GARAGE	395
NEW 2 CAR GARAGE ADDITION	148
NEW FIRST FLOOR ADDITION	188
NEW FRONT PORCH ADDITION	170
NEW FIRST FLOOR PATIO	75
NEW SECOND FLOOR ADDITION	1373
NEW SECOND FLOOR BALCONY	58
TOTAL GARAGE	543
TOTAL GARAGE W/400 SQFT CREDIT	143
TOTAL FIRST FLOOR	1562
TOTAL SECOND FLOOR	1373
TOTAL HABITABLE	3078

FAR CALCULATION						
ALLOWABLE	7,500 * 0.4 =	3000				
	435 * 0.3 =	130.5				
TOTAL ALLOWABLE	3131 SQFT					
PROVIDED	143+1487+1373+75 = 3078 SQF					
PROVIDED	3078 < 3131 = OK					

HARDSCAPE CALCULATION						
45% OF TOTAL FRONT YARD SETBACK = 1,795 SQFT						
201 + 45 + 750 = 996 SQFT						
484 + 208 + 107 = 799 SQFT						
799 < 1,795 = OK						

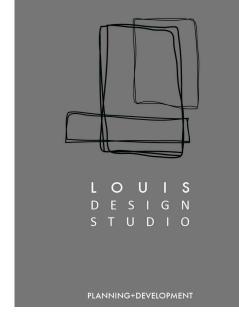

Design + Planning + Development

28338 Constellation Road, STE900 Valencia, CA 91355

C. + 661 510 7232 | W. + 661 312 4453 LOUISDESIGNSTUDIO@GMAIL.COM

PROJECT TITLE:

Residential Remodel 2306 N KENNETH RD BURBANK, CA 91504

DATE: March 2022 DESIGNED BY: L. Romero DRAWN BY: R. Duben

PERMIT NUMBER:


22-0005876-HDP

FAR DIAGRAM + **PROJECT INFORMATION**

SHEET NUMBER:

A0.2



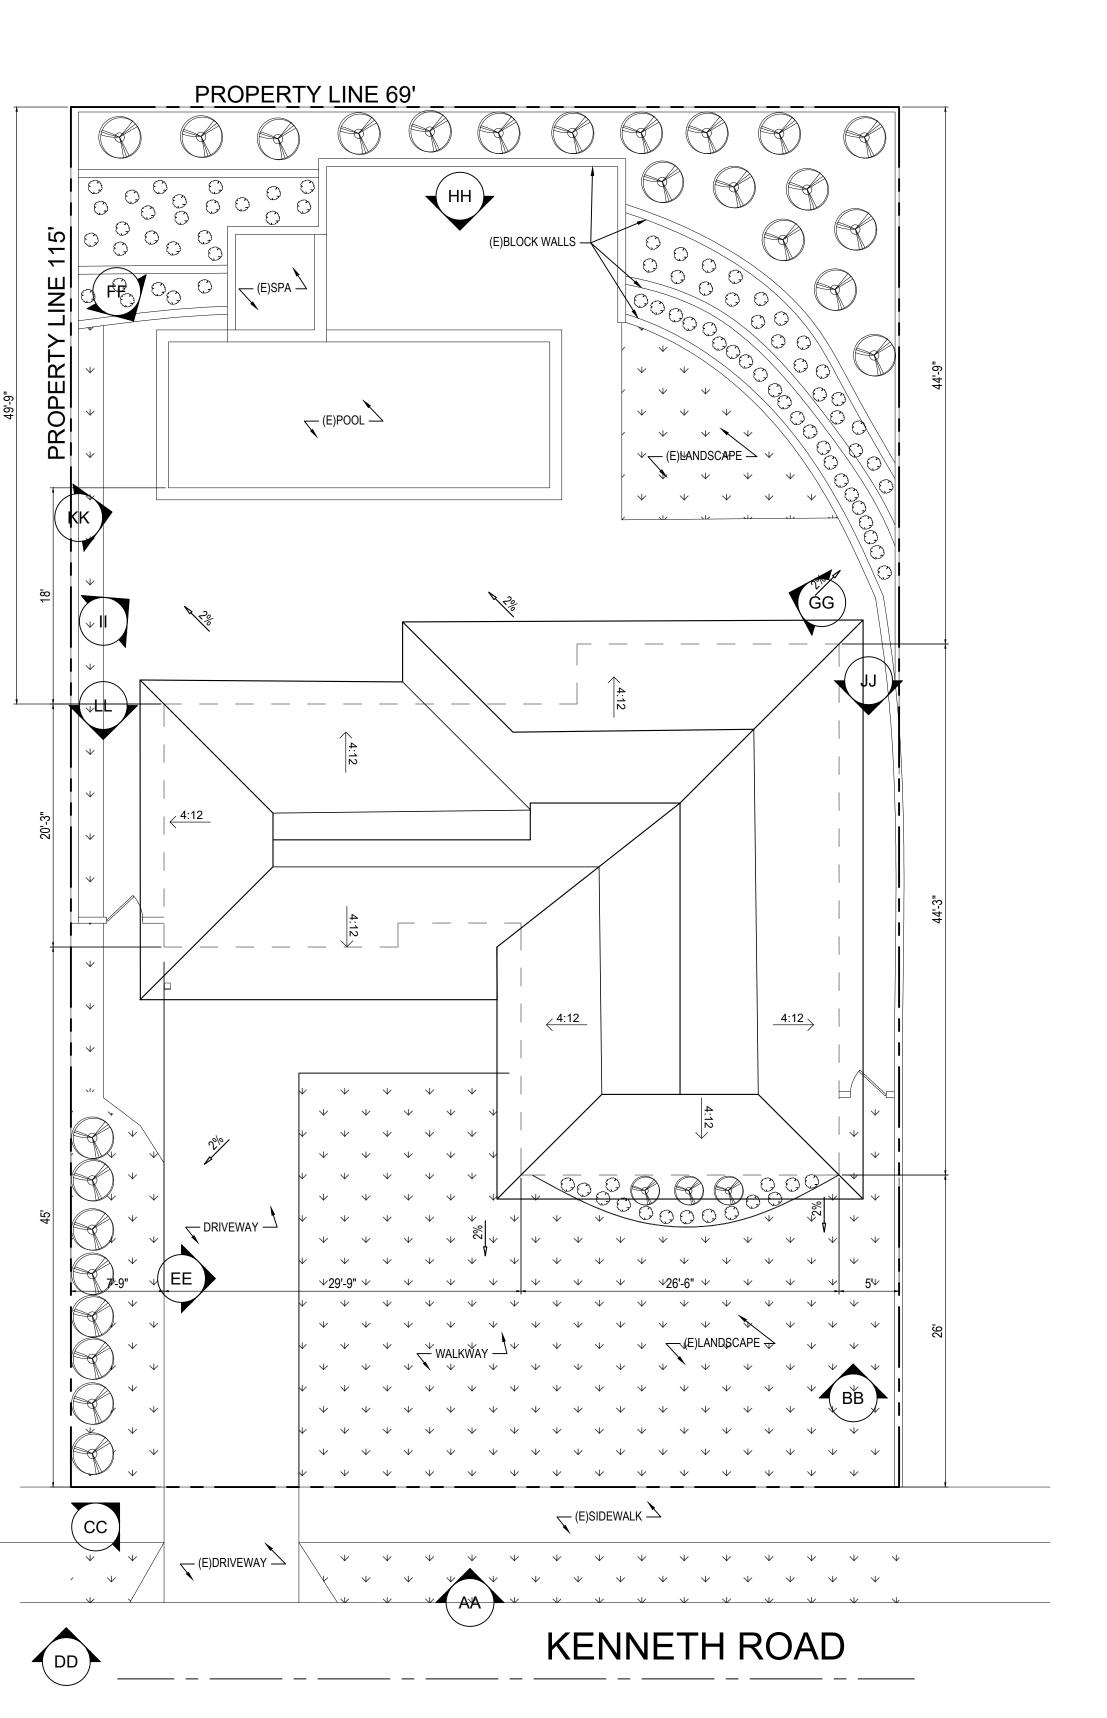


SITE PLAN - KEY





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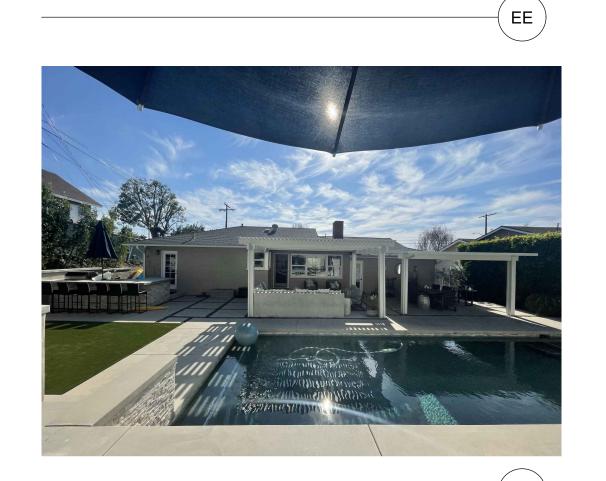







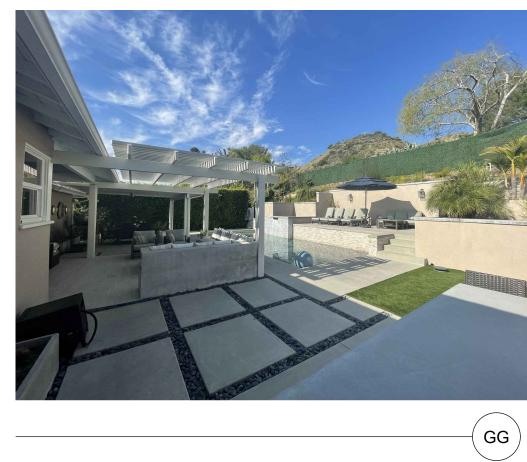


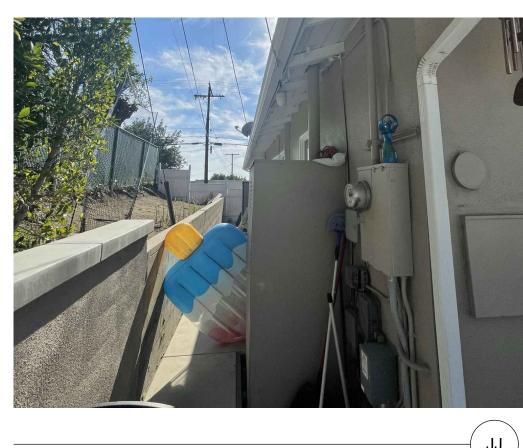


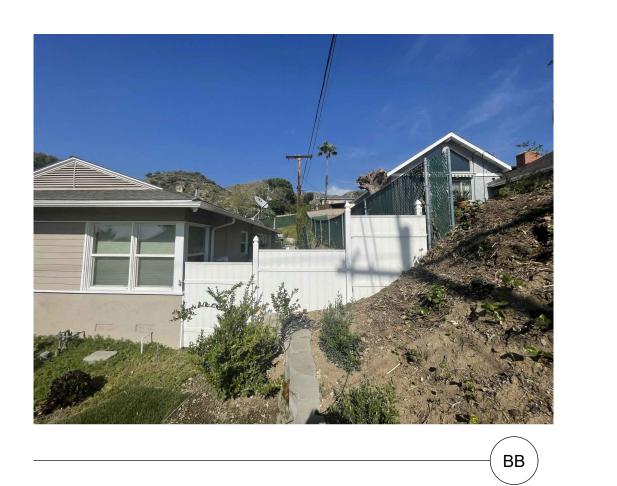


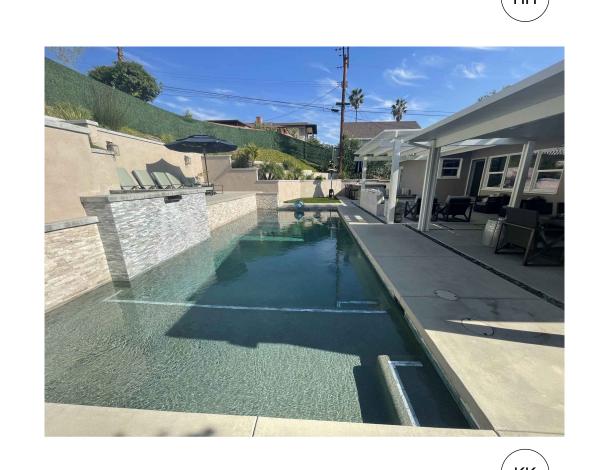




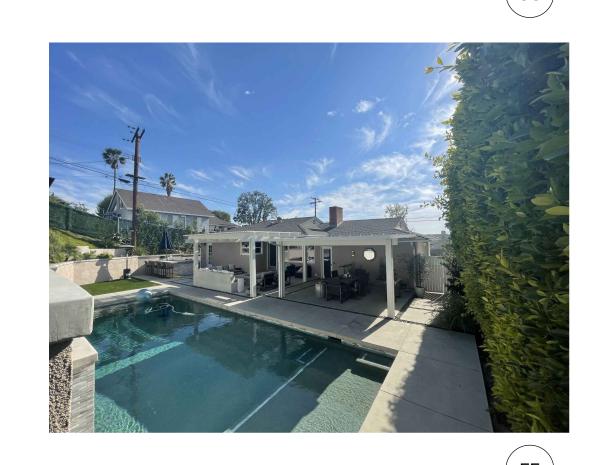

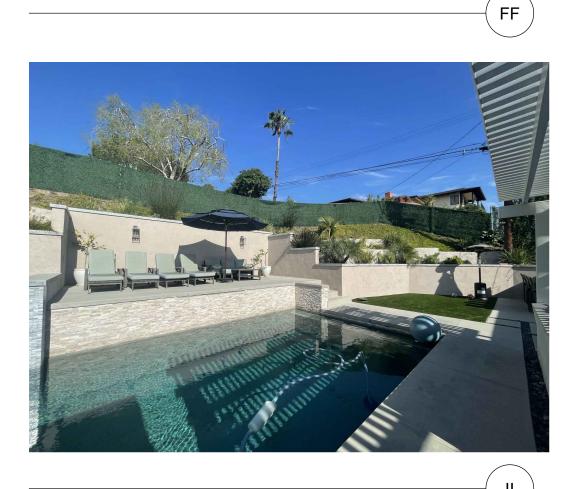

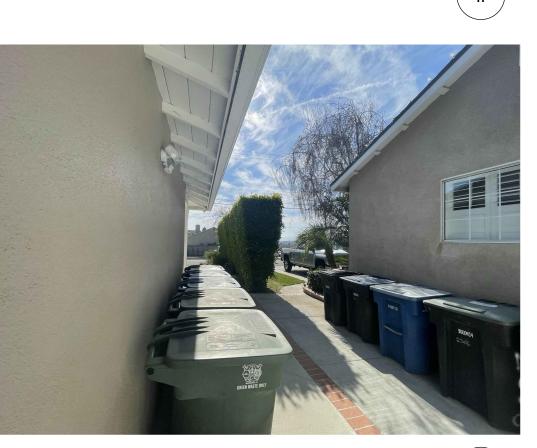

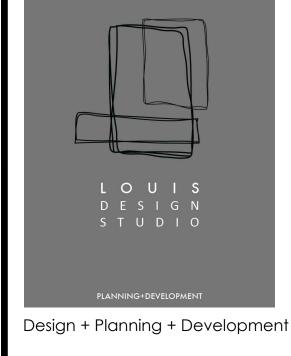

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PROJECT TITLE:

Residential Remodel 2306 N KENNETH RD BURBANK, CA 91504

March 2022 L. Romero

22-0005876-HDP


R. Duben

PHOTOS OF SITE PROJECT

SHEET NUMBER:

A0.3



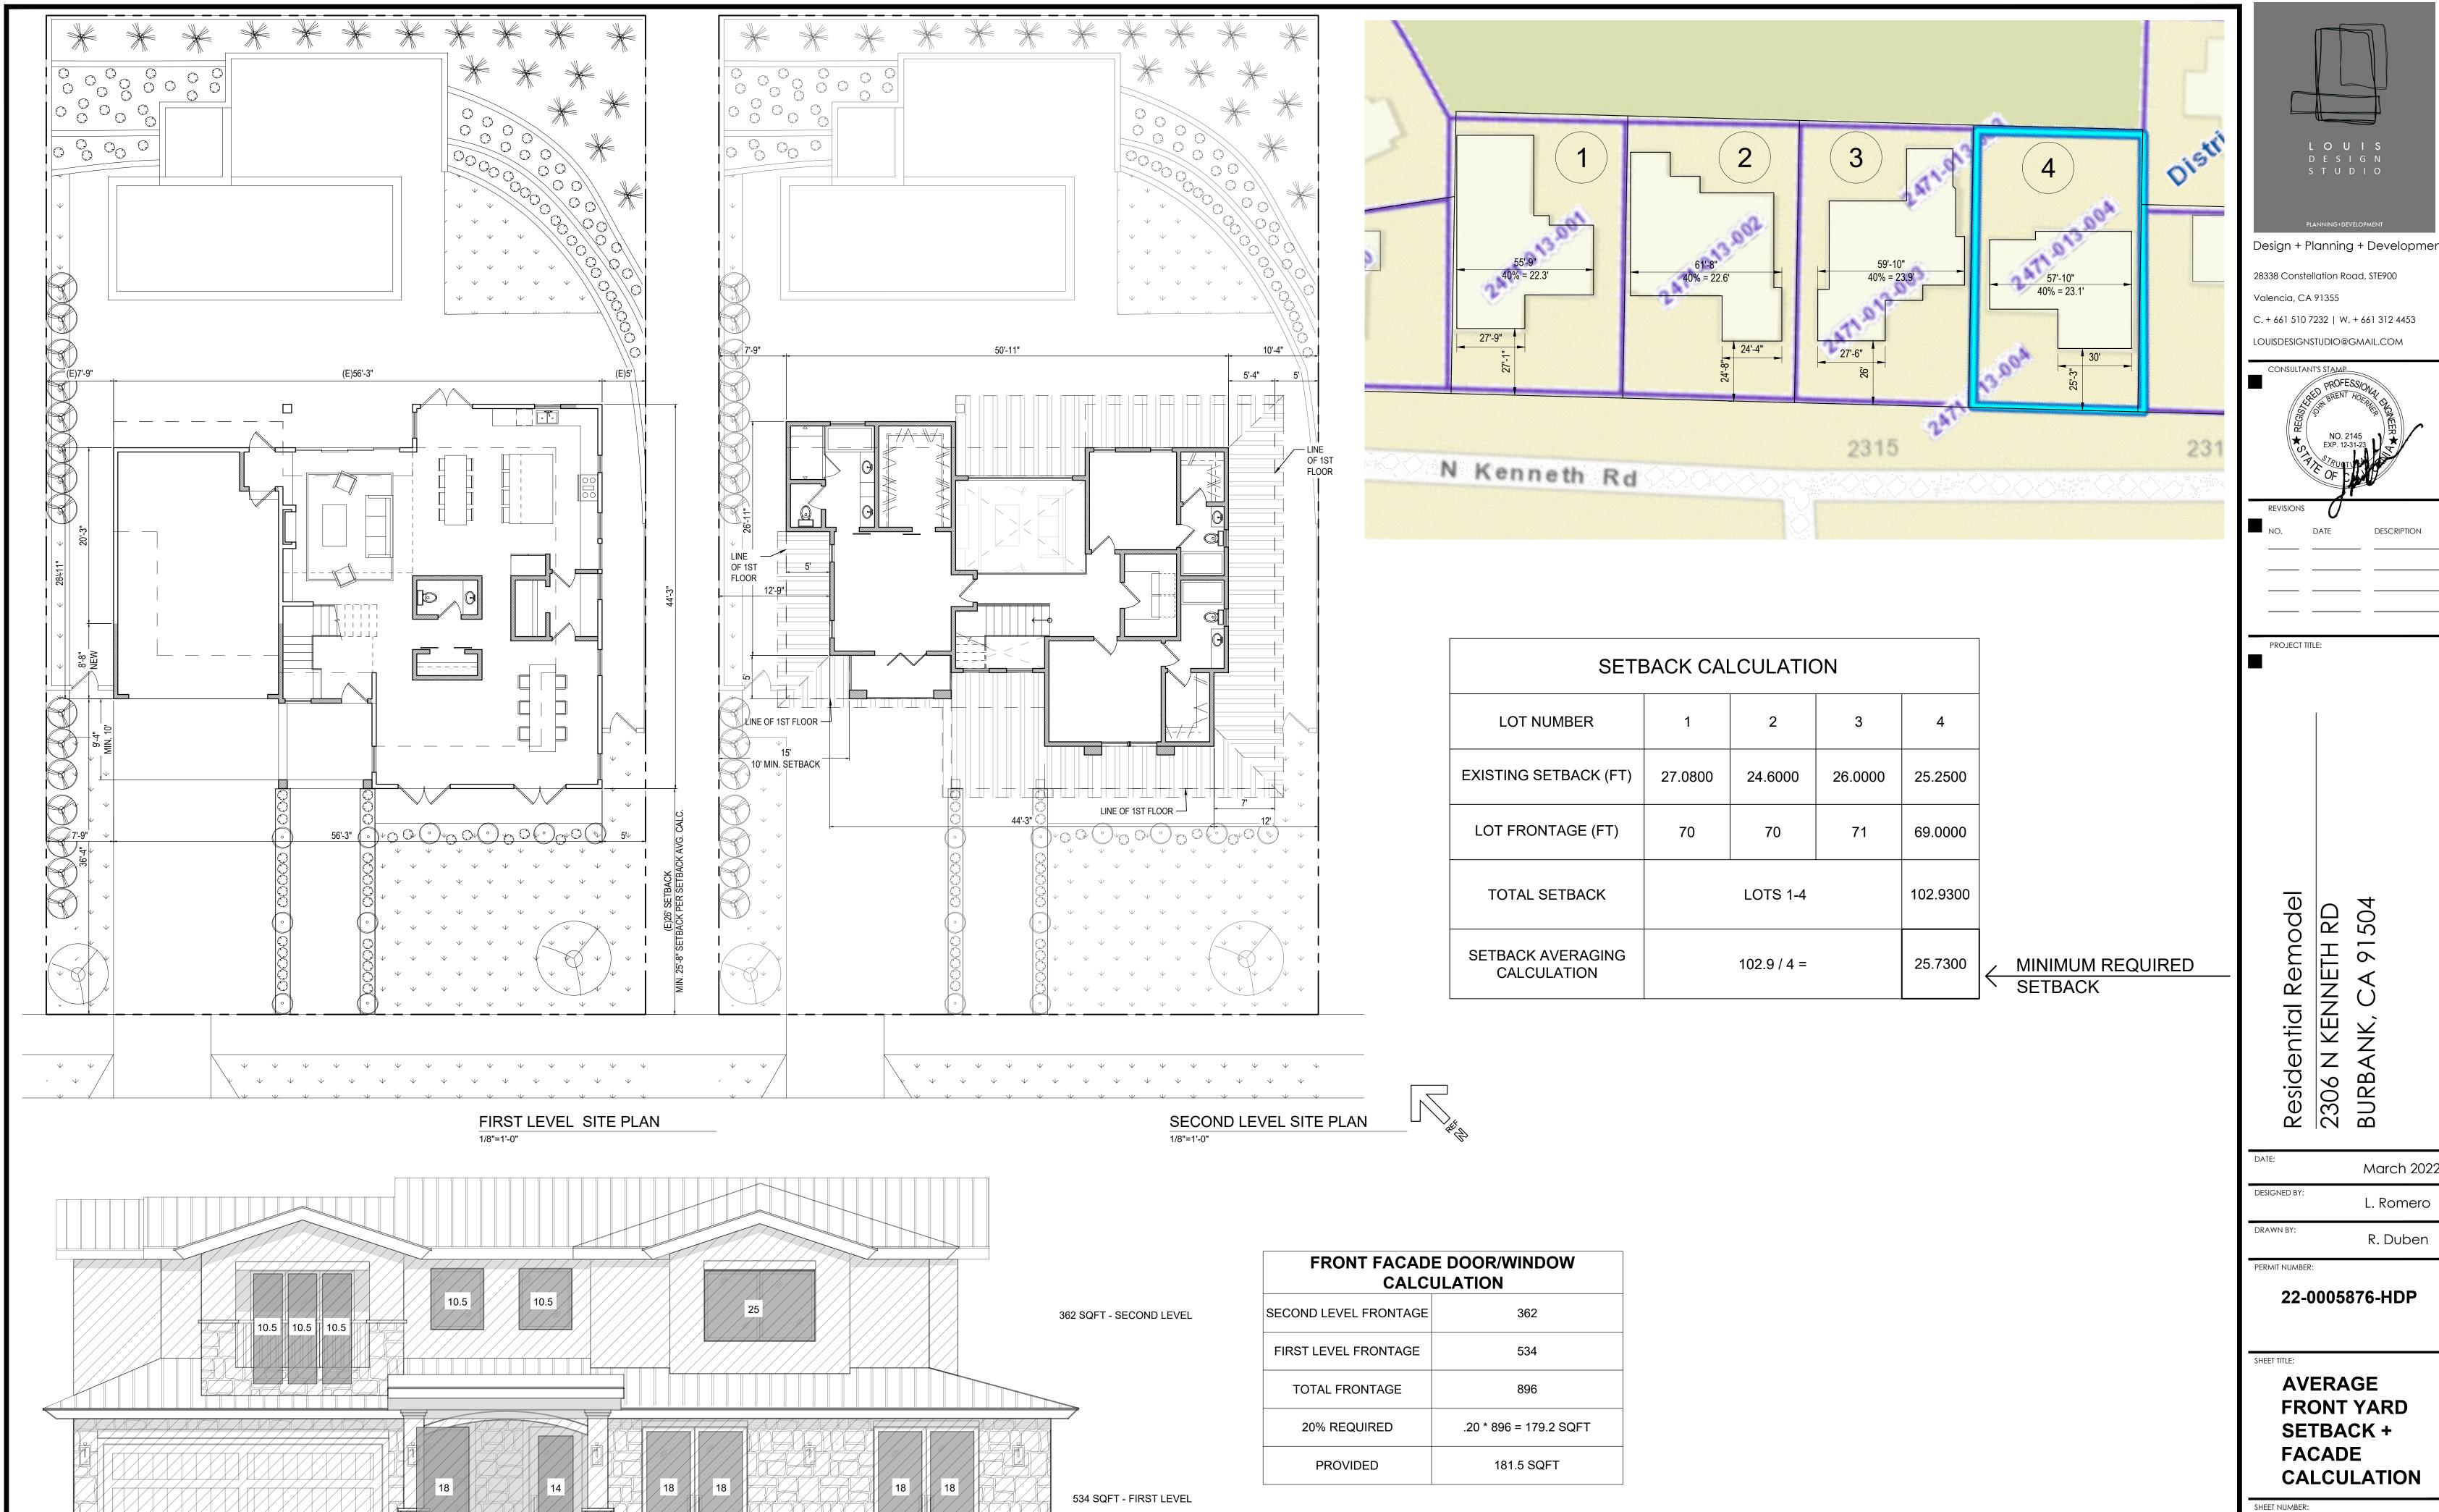

FRONT FACADE ELEVATION

LOUIS DESIGN STUDIO

Design + Planning + Development

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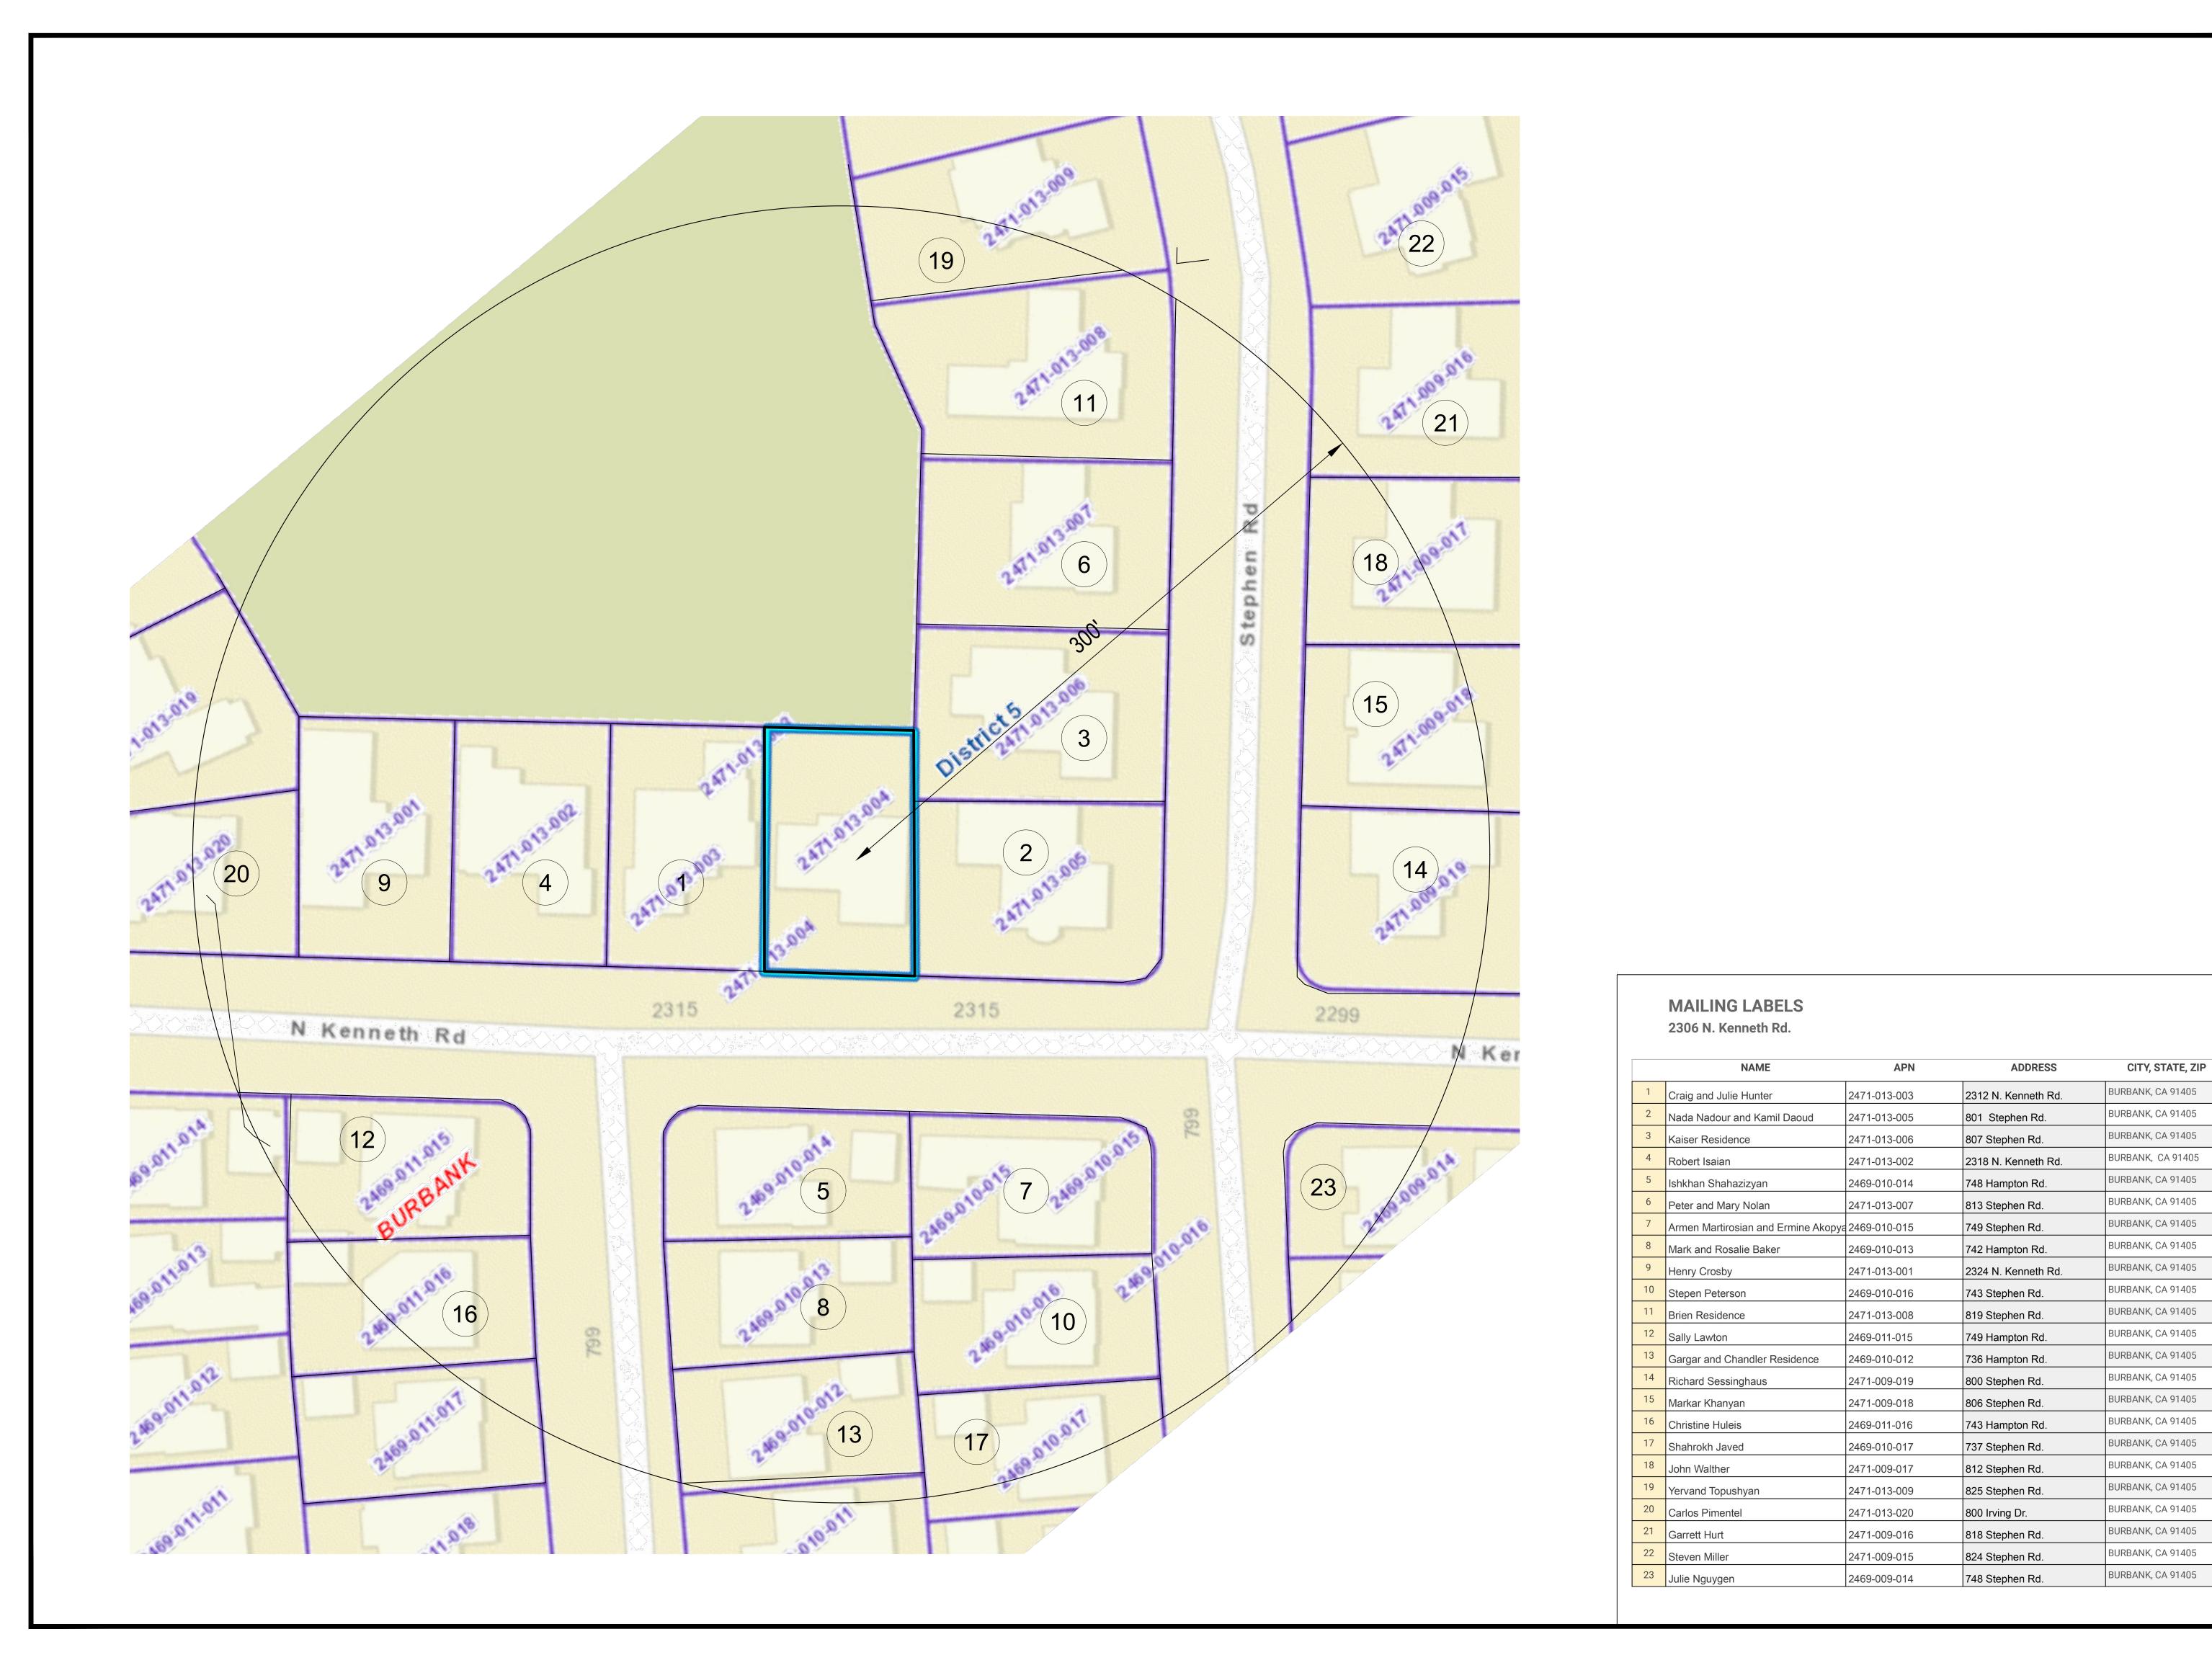
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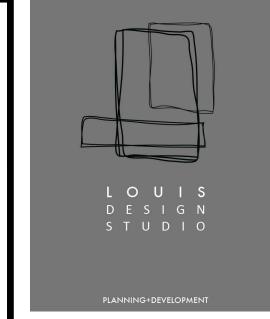
March 2022

R. Duben

22-0005876-HDP

AVERAGE FRONT YARD SETBACK + **FACADE**





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LOUISDESIGNSTUDIO@GMAIL.COM



REVISIONS
NO. DATE

PROJECT TITLE:

model TH RD

Residential Remodel 2306 N KENNETH RD BURBANK, CA 91504

DESIGNED BY:

L. Romero

DRAWN BY:

R. Duben

PERMIT NUMBER:


22-0005876-HDP


CET TITI E:

300' RADIUS MAP


SHEET NUMBER:

A0.5

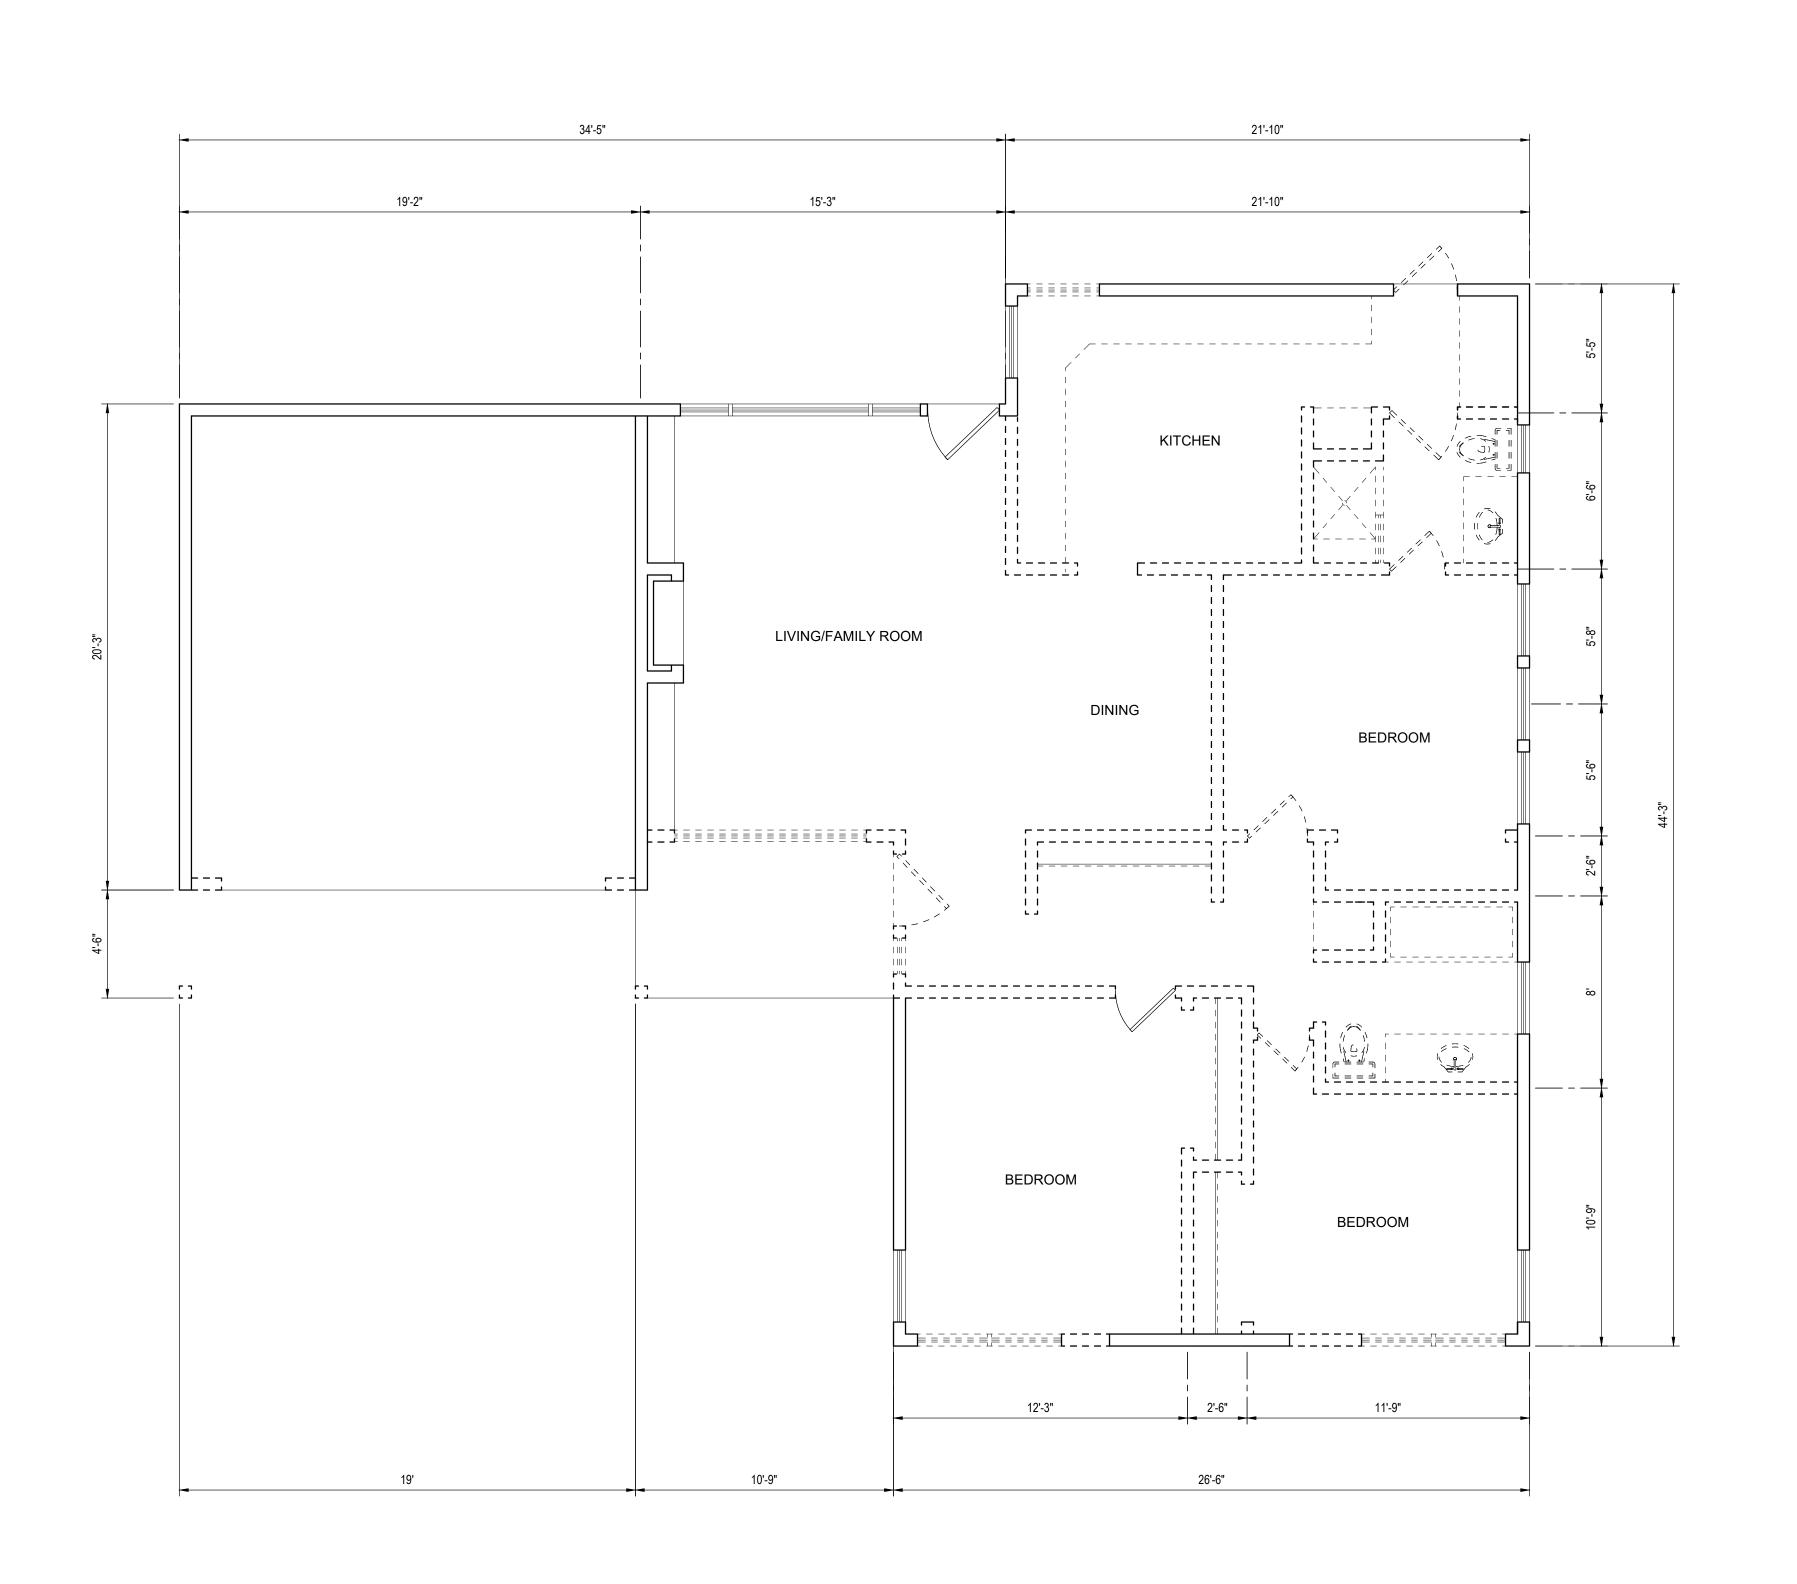

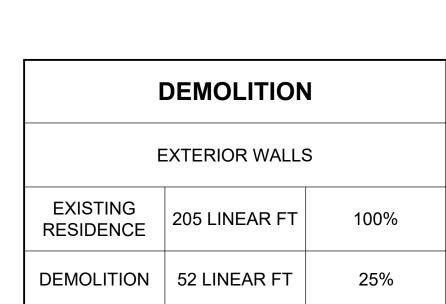

	LEGEND
	EXISTING WALLS
	NEW WALLS
	EXISTING WALLS TO BE REMOVED
SM	SMOKE DETECTOR 120V HARD WIRED WITH BATTERY BACK-UP
СМ	CARBON MONOXIDE DETECTOR 120V HARDWIRED WITH BATTERY BACK-UP
	BATHROOM FAN (MUST BE CAPABLE OF A MIN. 50 CFM) VENTED DIRECTLY TOT HE OUTSIDE. ENERGY STAR CONTROLLED W/ HUMIDITY STAR.
	ADDITION AREA TO 1ST FLOOR

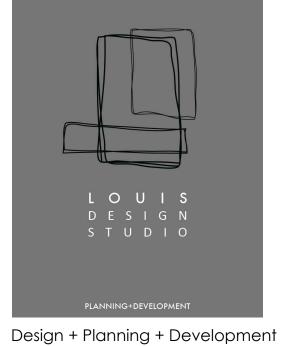

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DESCRIPTION

PROJECT TITLE:

Residential Remodel 2306 N KENNETH RD BURBANK, CA 91504

March 2022 DESIGNED BY: L. Romero DRAWN BY: R. Duben


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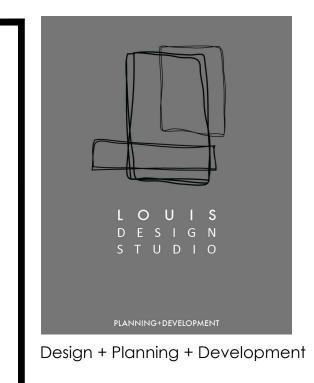
EXISTING/DEMO FLOOR PLAN

SHEET NUMBER:

EXISTING FIRST LEVEL

1/4"=1'-0"



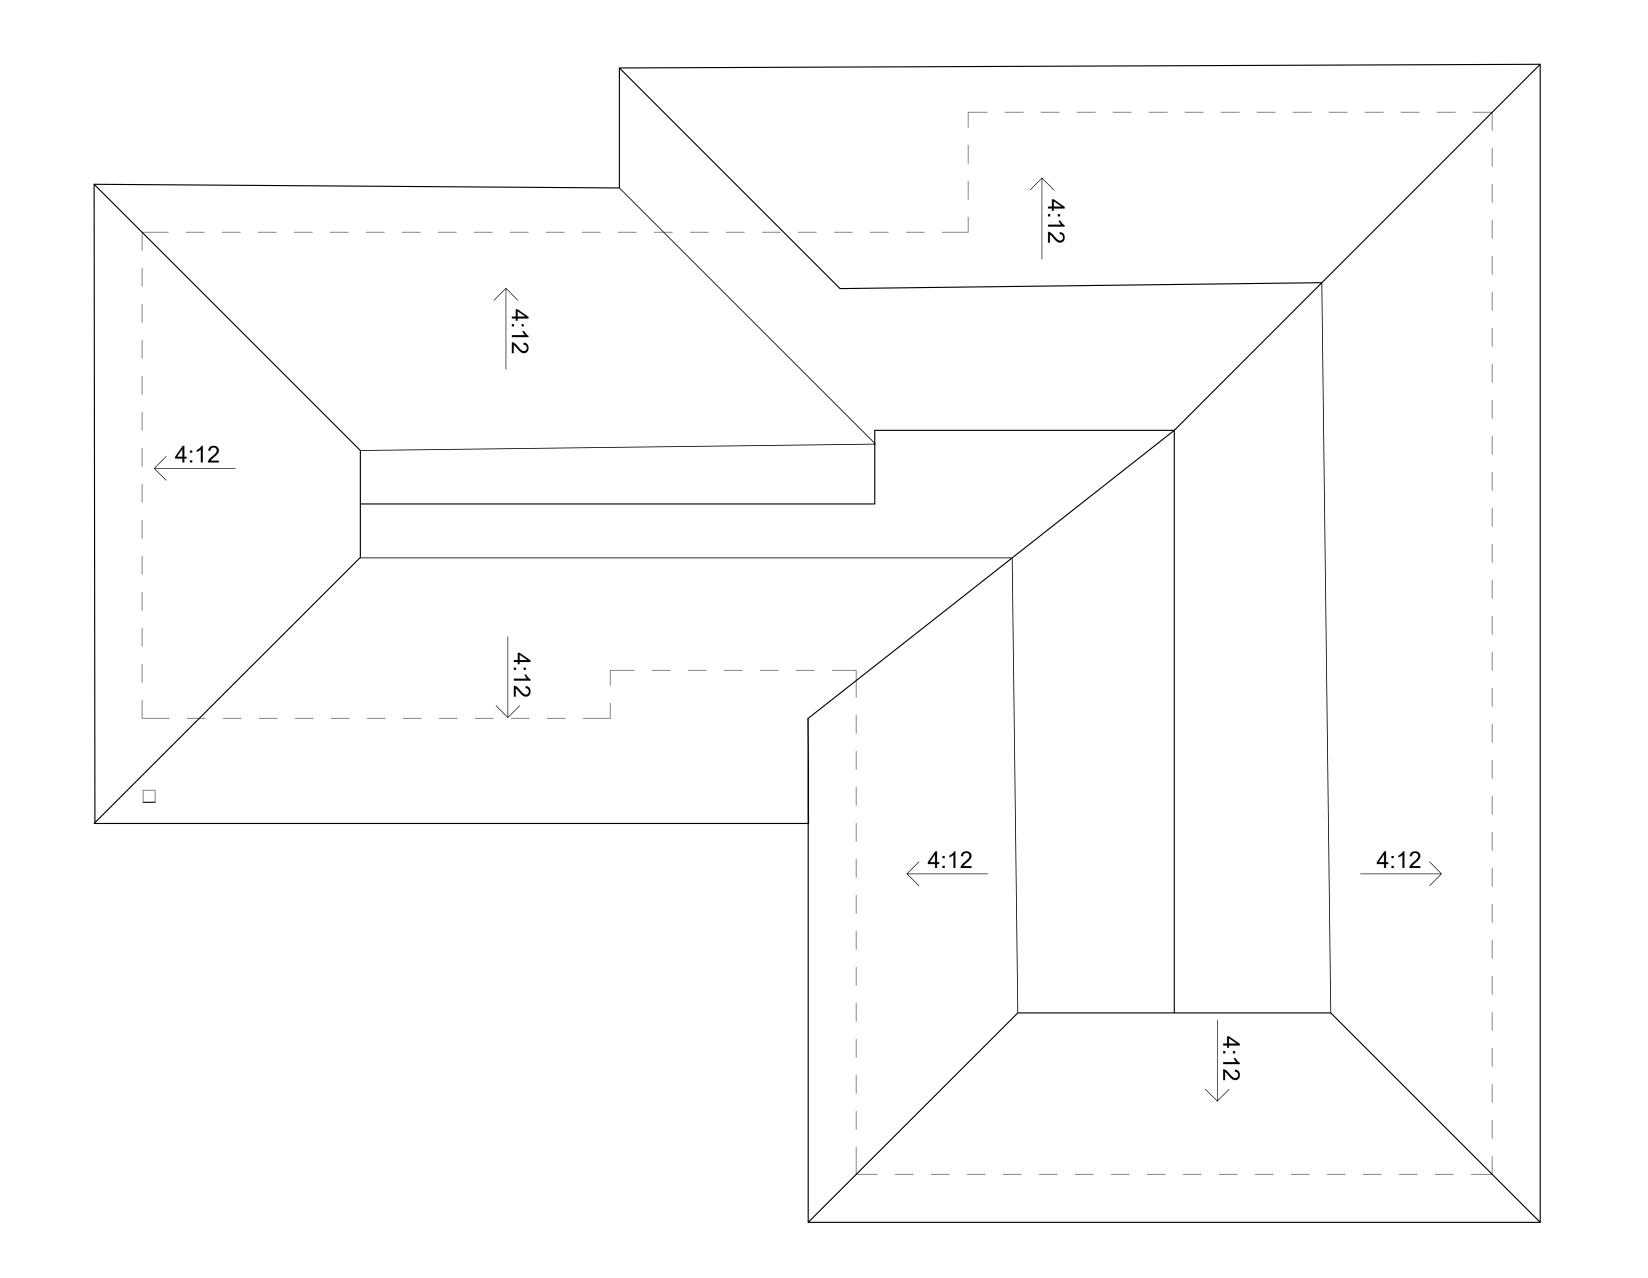

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PROJECT TITLE:

Residential Remodel 2306 N KENNETH RD BURBANK, CA 91504

March 2022 L. Romero R. Duben

22-0005876-HDP

EXISTING ROOF PLAN

NOTES

- A. The construction shall not restrict a five-foot clear and unobstructed access to any water or power distribution facilities (Power poles, pull-boxes, transformers, vaults, pumps, valves, meters, appurtenances, etc.) or to the location of the hook-up. The construction shall not be within ten feet of any power lines-whether or not the lines are located on the property. Failure to comply may cause construction delays and/or additional expenses.
- An approved Seismic Gas Shutoff Valve will be installed on the fuel gas line on the downstream side of the utility meter and be rigidly connected to the exterior of the building or structure containing the fuel gas piping. (Per Ordinance 170,158) (Separate plumbing permit is required).
- Plumbing fixtures are required to be connected to a sanitary sewer or to an approved sewage disposal system
- Kitchen sinks, lavatories, bathtubs, showers, bidets, laundry tubs and washing machine outlets shall be provided with hot and cold water and connected to an approved water supply (R306.4).
- Bathtub and shower floors, walls above bathtubs with a showerhead, and shower compartments shall be finished with a nonabsorbent surface. Such wall surfaces shall extend to a height of not less than 6 feet above the floor (R307.2).
- Provide ultra-low flush water closets for all new construction. Existing shower heads and toilets must be adapted for low water consumption.
- Unit Skylights shall be labeled by a LA City Approved Labeling Agency. Such label shall state the approved labeling agency name, product designation and performance grade rating. (Research Report not required). (R308.6.9)
- I. Water heater must be strapped to wall.(Sec. 507.3, LAPC)
- For existing pool on site, provide an alarm for doors to the dwelling that form a part of the pool enclosure. The alarm shall sound continuously for a min. of 30 seconds when the door is opened. It shall automatically reset and be equipped with a manual means to deactivate (for 15 secs. max.) for a single opening. The deactivation switch shall be at least 54" above the floor. (6109 of LABC)
- For existing pool on site, provide anti-entrapment cover meeting the current ASTM or ASME for the suction outlets of the swimming pool, toddler pool and spa for single family dwellings per Assembly Bill (AB) No. 2977. (3162B)
- Automatic garage door openers, if provided, shall be listed in accordance with UL 325. (R309.4)
- Smoke detectors shall be provided for all dwelling units intended for human occupancy, where a permit is required for alterations, repairs, or additions. (R314.2)
- Where a permit is required for alterations, repairs or additions, existing dwellings or sleeping units that have attached garages or fuel-burning appliances shall be provided with a carbon monoxide alarm in accordance with Section R315.2. Carbon monoxide alarms shall only be required in the specific dwelling unit or sleeping unit for which the permit was obtained. (R315.2.)
- Every space intended for human occupancy shall be provided with natural light by means of exterior glazed openings in accordance with Section R303.1 or shall be provided with artificial light that is adequate to provide an average illumination of 6 foot-candles over the area of the room at a height of 30 inches above the floor level. (R303.1)
- A copy of the evaluation report and/or conditions of listing shall be made available at the job site

- An approved smoke alarm shall be installed in each sleeping room & hallway or area giving access to a sleeping room, and on each story and basement for dwellings with more than one story. Smoke alarms shall be interconnected so that actuation of one alarm will activate all the alarms within the individual dwelling unit. In new construction smoke alarms shall receive their primary power source from the building wiring and shall be equipped with battery back-up and low battery signal. (R314)
- An approved carbon monoxide alarm shall be installed in dwelling units and in sleeping units within which fuel-burning appliances are installed and in dwelling units that have attached garages. Carbon monoxide alarm shall be provided outside of each separate dwelling unit sleeping area in the immediate vicinity of the bedroom(s) and on every level of a dwelling unit including basements. (R315)

- The means of egress shall provide a continuous and unobstructed path of vertical and horizontal egress travel from all portions of the dwelling to the exterior of the dwelling at the required egress door without requiring travel through a garage. The required egress door shall open directly into a public way or to a yard or court that opens to a public way.(R311.1)
- Provide emergency egress from sleeping rooms. Show details on plans. Minimum - 24" clear height, 20" clear width, 5.7 sf minimum area (5.0 sf at grade level) & 44" maximum to sill. (R310.2.1)

GREEN BUILDING CODE: RESIDENTIAL BUILDINGS

- 1. Roofs with slopes < 2:12 shall have a 3-year aged SRI value of at least 75 or both a 3-year aged solar reflectance of at least 0.63 and a thermal emittance of at least 0.75. Roofs with slopes > 2:12 shall have an aged SRI value of at least 16 or both a 3-year solar reflectance of at least 0.20 and a
- thermal emittance of at least 0.75. The required hardscape used to reduce heat island effects shall have a solar reflectance value of at least 0.30 as determined per ASTM E1918 or
- ASTM C1549. (4.106.7) The flow rates for all plumbing fixtures shall comply with the maximum flow rates in Section 4.303.1. (4.303.1)
- When a shower is served by more than one showerhead, the combined flow rate of all the showerheads controlled by a single valve shall not exceed 2.0 gallons per minute at 80psi, or the shower shall be designed to only allow one showerhead to be in operation at a time. (4.303.1.3.2) Annular spaces around pipes, electric cables, conduits, or other openings
- in the building's envelope at exterior walls shall be protected against the passage of rodents by closing such openings with cement mortar, concrete masonry, or metal plates. Piping prone to corrosion shall be protected in accordance with Section 313.0 of the Los Angeles Plumbing Code.
- 10. Materials delivered to the construction site shall be protected from rain or
- other sources of moisture. (4.407.4) 1. Only a City of Los Angeles permitted hauler will be used for hauling of construction waste. (4.408.1)
- 12. For all new equipment, an Operation and Maintenance Manual including, at a minimum, the items listed in Section 4.410.1, shall be completed and placed in the building at the time of final inspection. (4.410.1) 13. All new gas fireplaces must be direct-vent, sealed combustion type. Wood
- burning fireplaces are prohibited per AQMD Rule 445. (4.503.1, AQMD 14. All duct and other related air distribution component openings shall be
- covered with tape, plastic, or sheet metal until the final startup of the heating, cooling and ventilating equipment. (4.504.1) 15. Paints and coatings, adhesives, caulks and sealants shall comply with the Volatile Organic Compound (VOC) limits listed in Tables 4.504.1-4.504.3.


16. The VOC Content Verification Checklist, Form GRN 2, shall be completed

- and verified prior to final inspection approval. The manufacturer's specifications showing VOC content for all applicable products shall be readily available at the job site and be provided to the field inspector for verification. (4.504.2.4)
- 17. All new carpet and carpet cushions installed in the building interior shall meet the testing and product requirements of one of the following
- a. Carpet and Rug Institute's Green Label Plus Program
- b. California Department of Public Health's Specification 01350
- c. NSF/ANSI 140 at the Gold level
- d. Scientific Certifications Systems Indoor Advantage™ Gold 18. 80% of the total area receiving resilient flooring shall comply with one or more of the following (4.504.4):
- a. VOC emission limits defined in the CHPS High Performance Products
- b. Certified under UL GREENGUARD Gold
- c. Certification under the Resilient Floor Covering Institute (RFCI) FloorScore
- d. Meet the California Department of Public Health's Specification 01350 19. New hardwood plywood, particle board, and medium density fiberboard composite wood products used in the building shall meet the formaldehyde
- limits listed in Table 4.504.5. (4.504.5) 20. The Formaldehyde Emissions Verification Checklist, form GRN 3, shall be completed prior to final inspection approval.
- 21. Mechanically ventilated buildings shall provide regularly occupied areas of the building with a MERV 13 filter for outside and return air. Filters shall be installed prior to occupancy and recommendations for maintenance with filters of the same value shall be included in the operation and maintenance manual, (4,504.6)
- 22. A 4-inch thick base of ½ inch or larger clean aggregate shall be provided for proposed slab on grade construction. A vapor barrier shall be provided in direct contact with concrete for proposed slab on grade construction.
- 23. Building materials with visible signs of water damage shall not be installed. Wall and floor framing shall not be enclosed until it is inspected and found to be satisfactory. (4.505.3)
- 24. Newly installed bathroom exhaust fans shall be ENERGY STAR compliant and be ducted to terminate to the outside of the building. Fans must be controlled by a humidistat which shall be readily accessible. Provide the manufacturer's cut sheet for verification. (4.506.1)
- 26. The heating and air-conditioning systems shall be sized and designed using ANSI/ACCA Manual J-2004, ANSI/ACCA 29-D-2009 or ASHRAE handbooks and have their equipment selected in accordance with ANSI/ACCA 36-S Manual S-2004. (4.507.2)


WATER CONSERVATION: RESIDENTIAL BUILDINGS

- 2. Water use reduction shall be met by complying with one of the following: A. Provide a 20% reduction in the overall potable water use within the building. The reduction shall be based on the maximum allowable water use for plumbing fixtures and fittings as required by the Los Angeles Plumbing Code. Calculations demonstrating a 20% reduction in the building "water use baseline", as established in Table 4.303.4.1, shall be provided; or
- B. New fixtures and fittings shall comply with the maximum flow rates shown in Table 4.303.4.2, or
- C. Plumbing fixtures shall use recycled water. Exception: Fixture replacements (4.303.4)
- 3. New building on a site with 500 square feet or more of cumulative landscape area shall have separate meters or submeters for outdoor water use. (4.304.3) 4. Additions and alterations on a site with 500 square feet or more of cumulative
- landscape area and where the entire potable water system is replaced, shall have separate meters or submeters for outdoor water use. (4.304.3)
- 5. In other than single family dwellings, locks shall be installed on all publicly accessible exterior faucets and hose bibs.(4.304.4)
- Except as provided in this section, for sites with over 500 square feet of landscape area, alternate waste piping shall be installed to permit discharge from the clothes washer, bathtub, showers, and bathroom/restrooms wash basins to be used for a future graywater
- irrigation system. (4.305.1) 8. Except as provided in this section, where City-recycled water is available within 200 feet of the property line, water closets, urinals, floor drains, and process cooling and heating in the building shall be supplied from recycled water and shall be installed in accordance with the Los Angeles Plumbing Code. (4.305.2)

	LEGEND
	EXISTING WALLS
	NEW WALLS
	EXISTING WALLS TO BE REMOVED
SM	SMOKE DETECTOR 120V HARD WIRED WITH BATTERY BACK-UP
Осм	CARBON MONOXIDE DETECTOR 120V HARDWIRED WITH BATTERY BACK-UP
	BATHROOM FAN (MUST BE CAPABLE OF A MIN. 50 CFM) VENTED DIRECTLY TOT HE OUTSIDE. ENERGY STAR CONTROLLED W/ HUMIDITY STAR.
	ADDITION AREA TO 1ST FLOOR

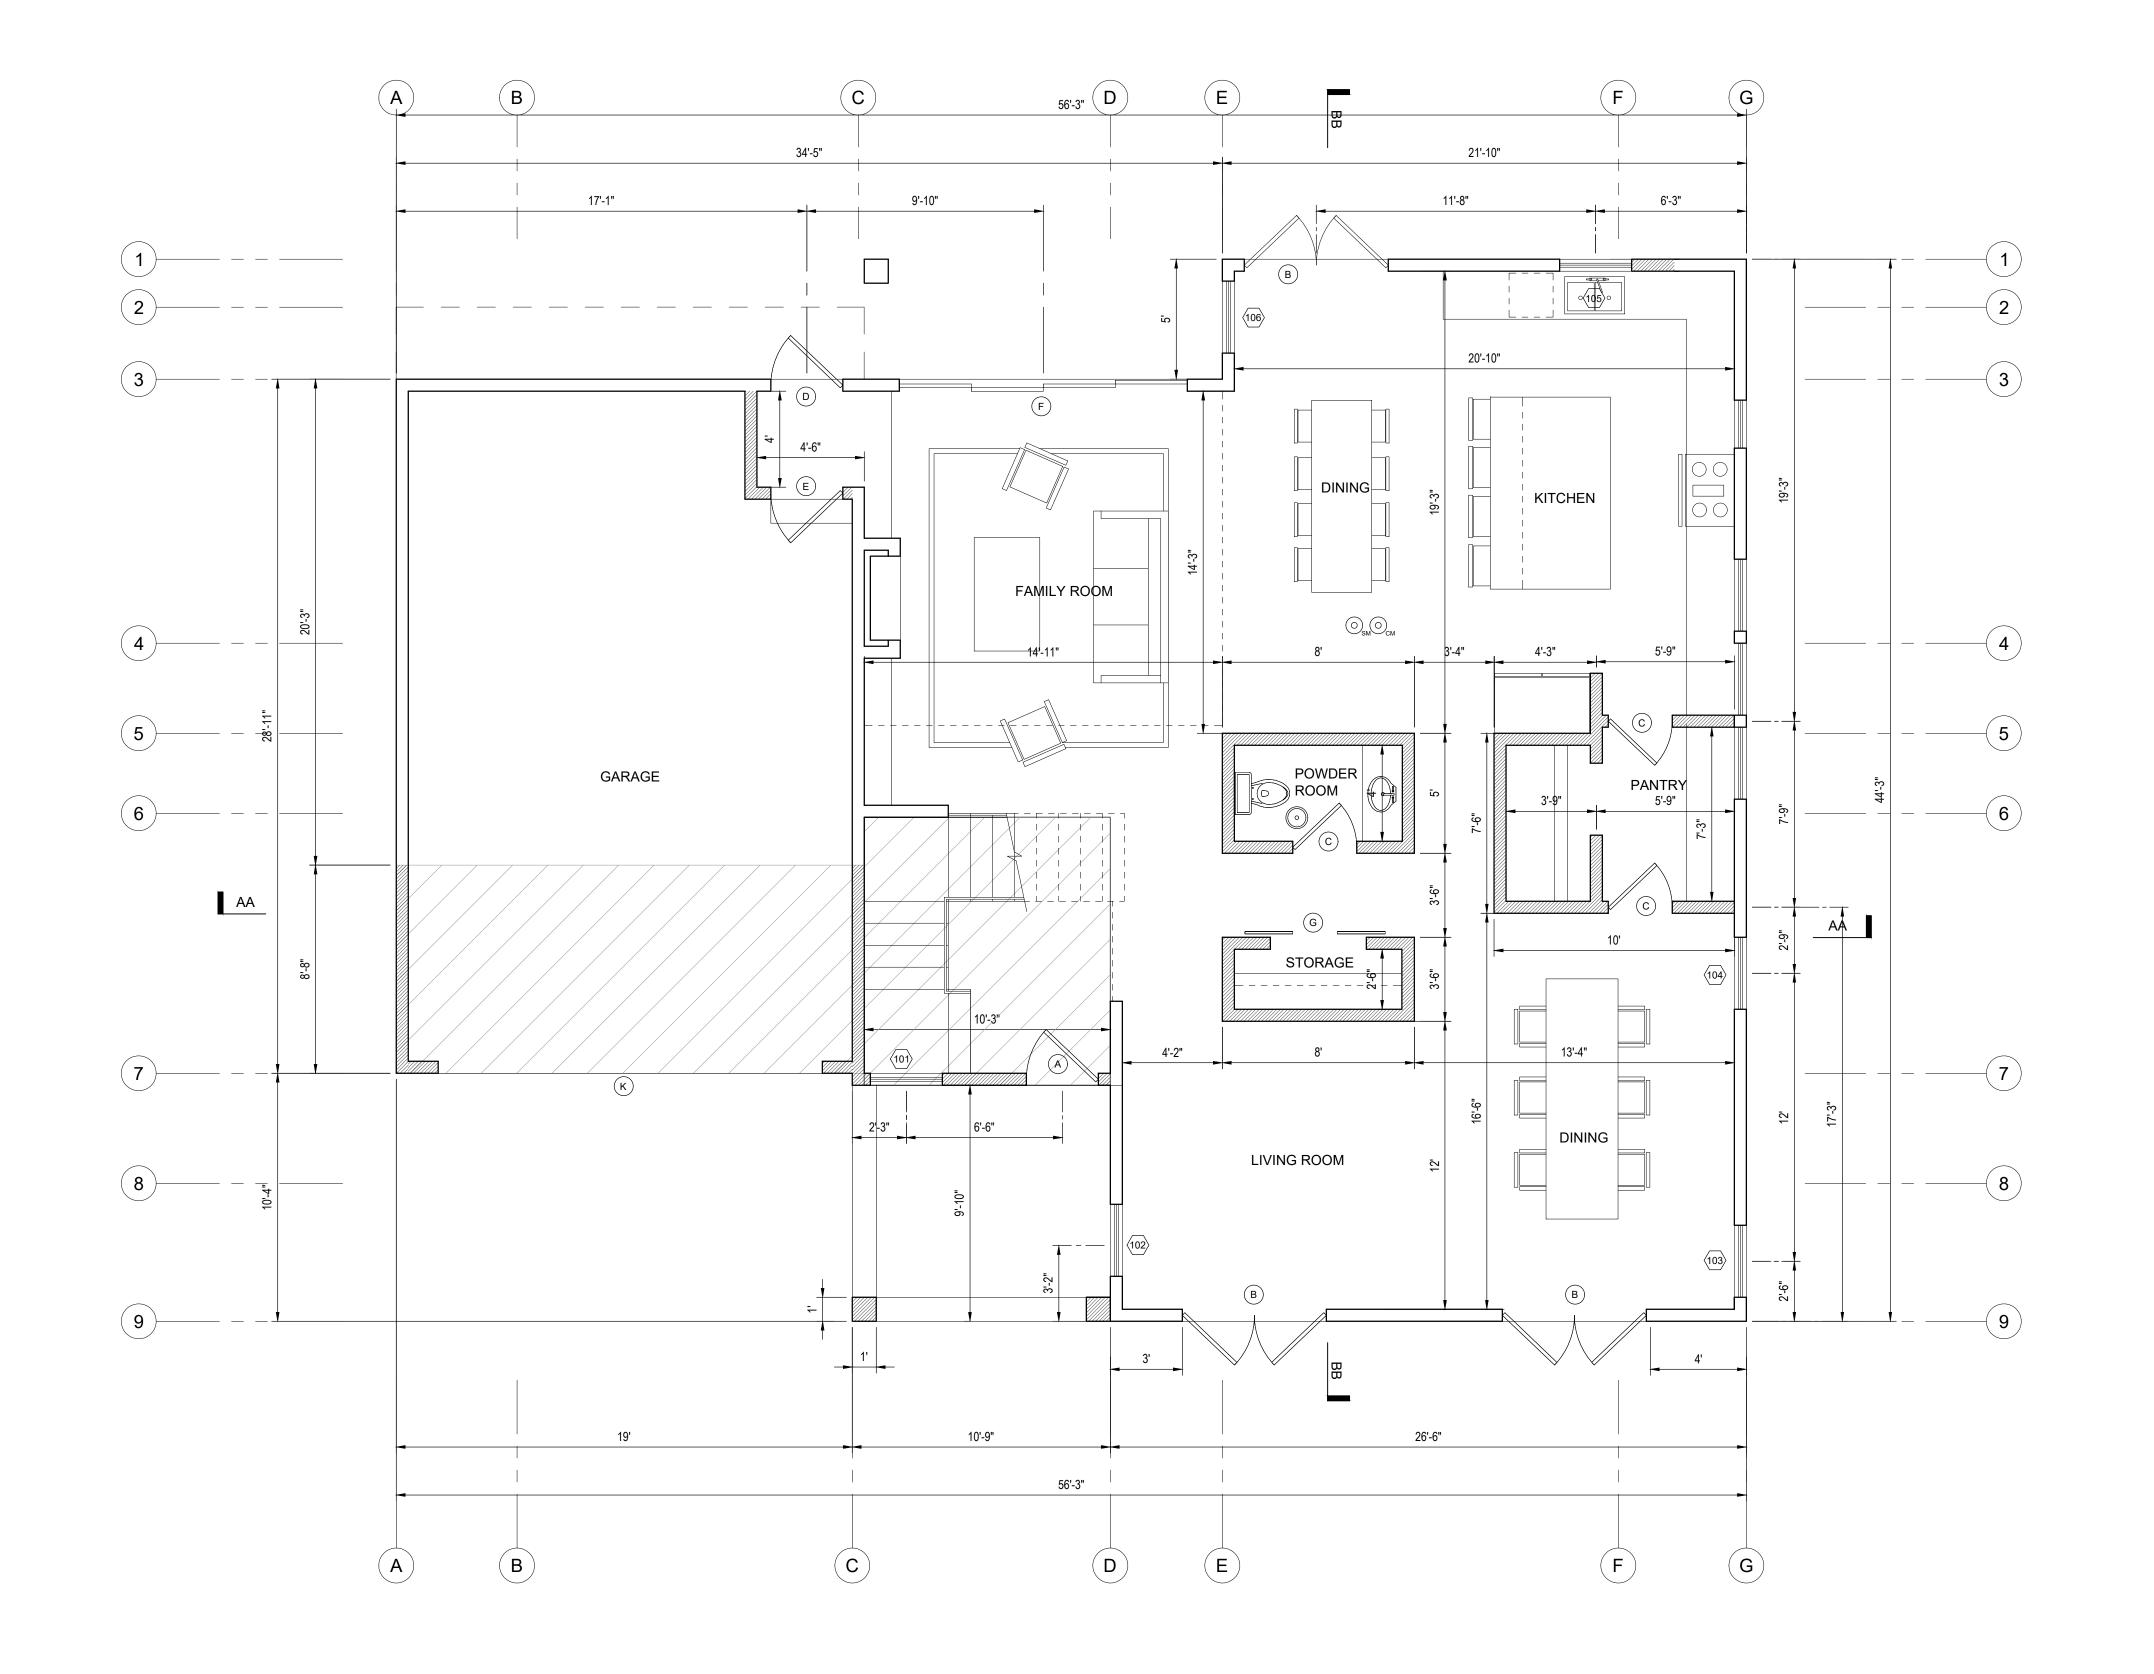



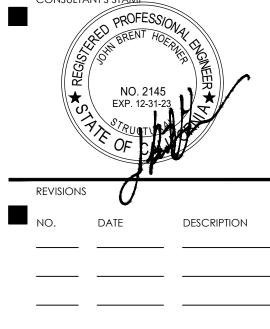

PROJECT TITLE:

N KENNETH RD SANK, CA 91504 sidential 308 BURI

DATE: March 2022 DESIGNED BY: L. Romero

R. Duben

PERMIT NUMBER:

DRAWN BY:


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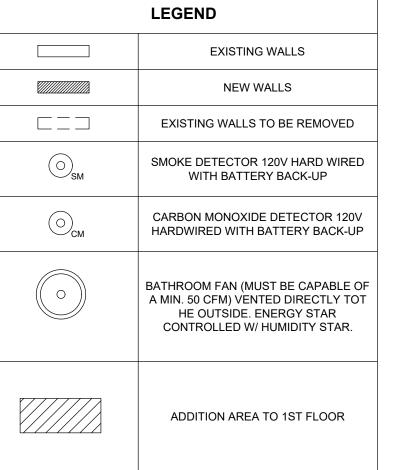
NEW FIRST LEVEL FLOOR PLAN

SHEET NUMBER:

NEW FIRST LEVEL

1/4" = 1'-0"



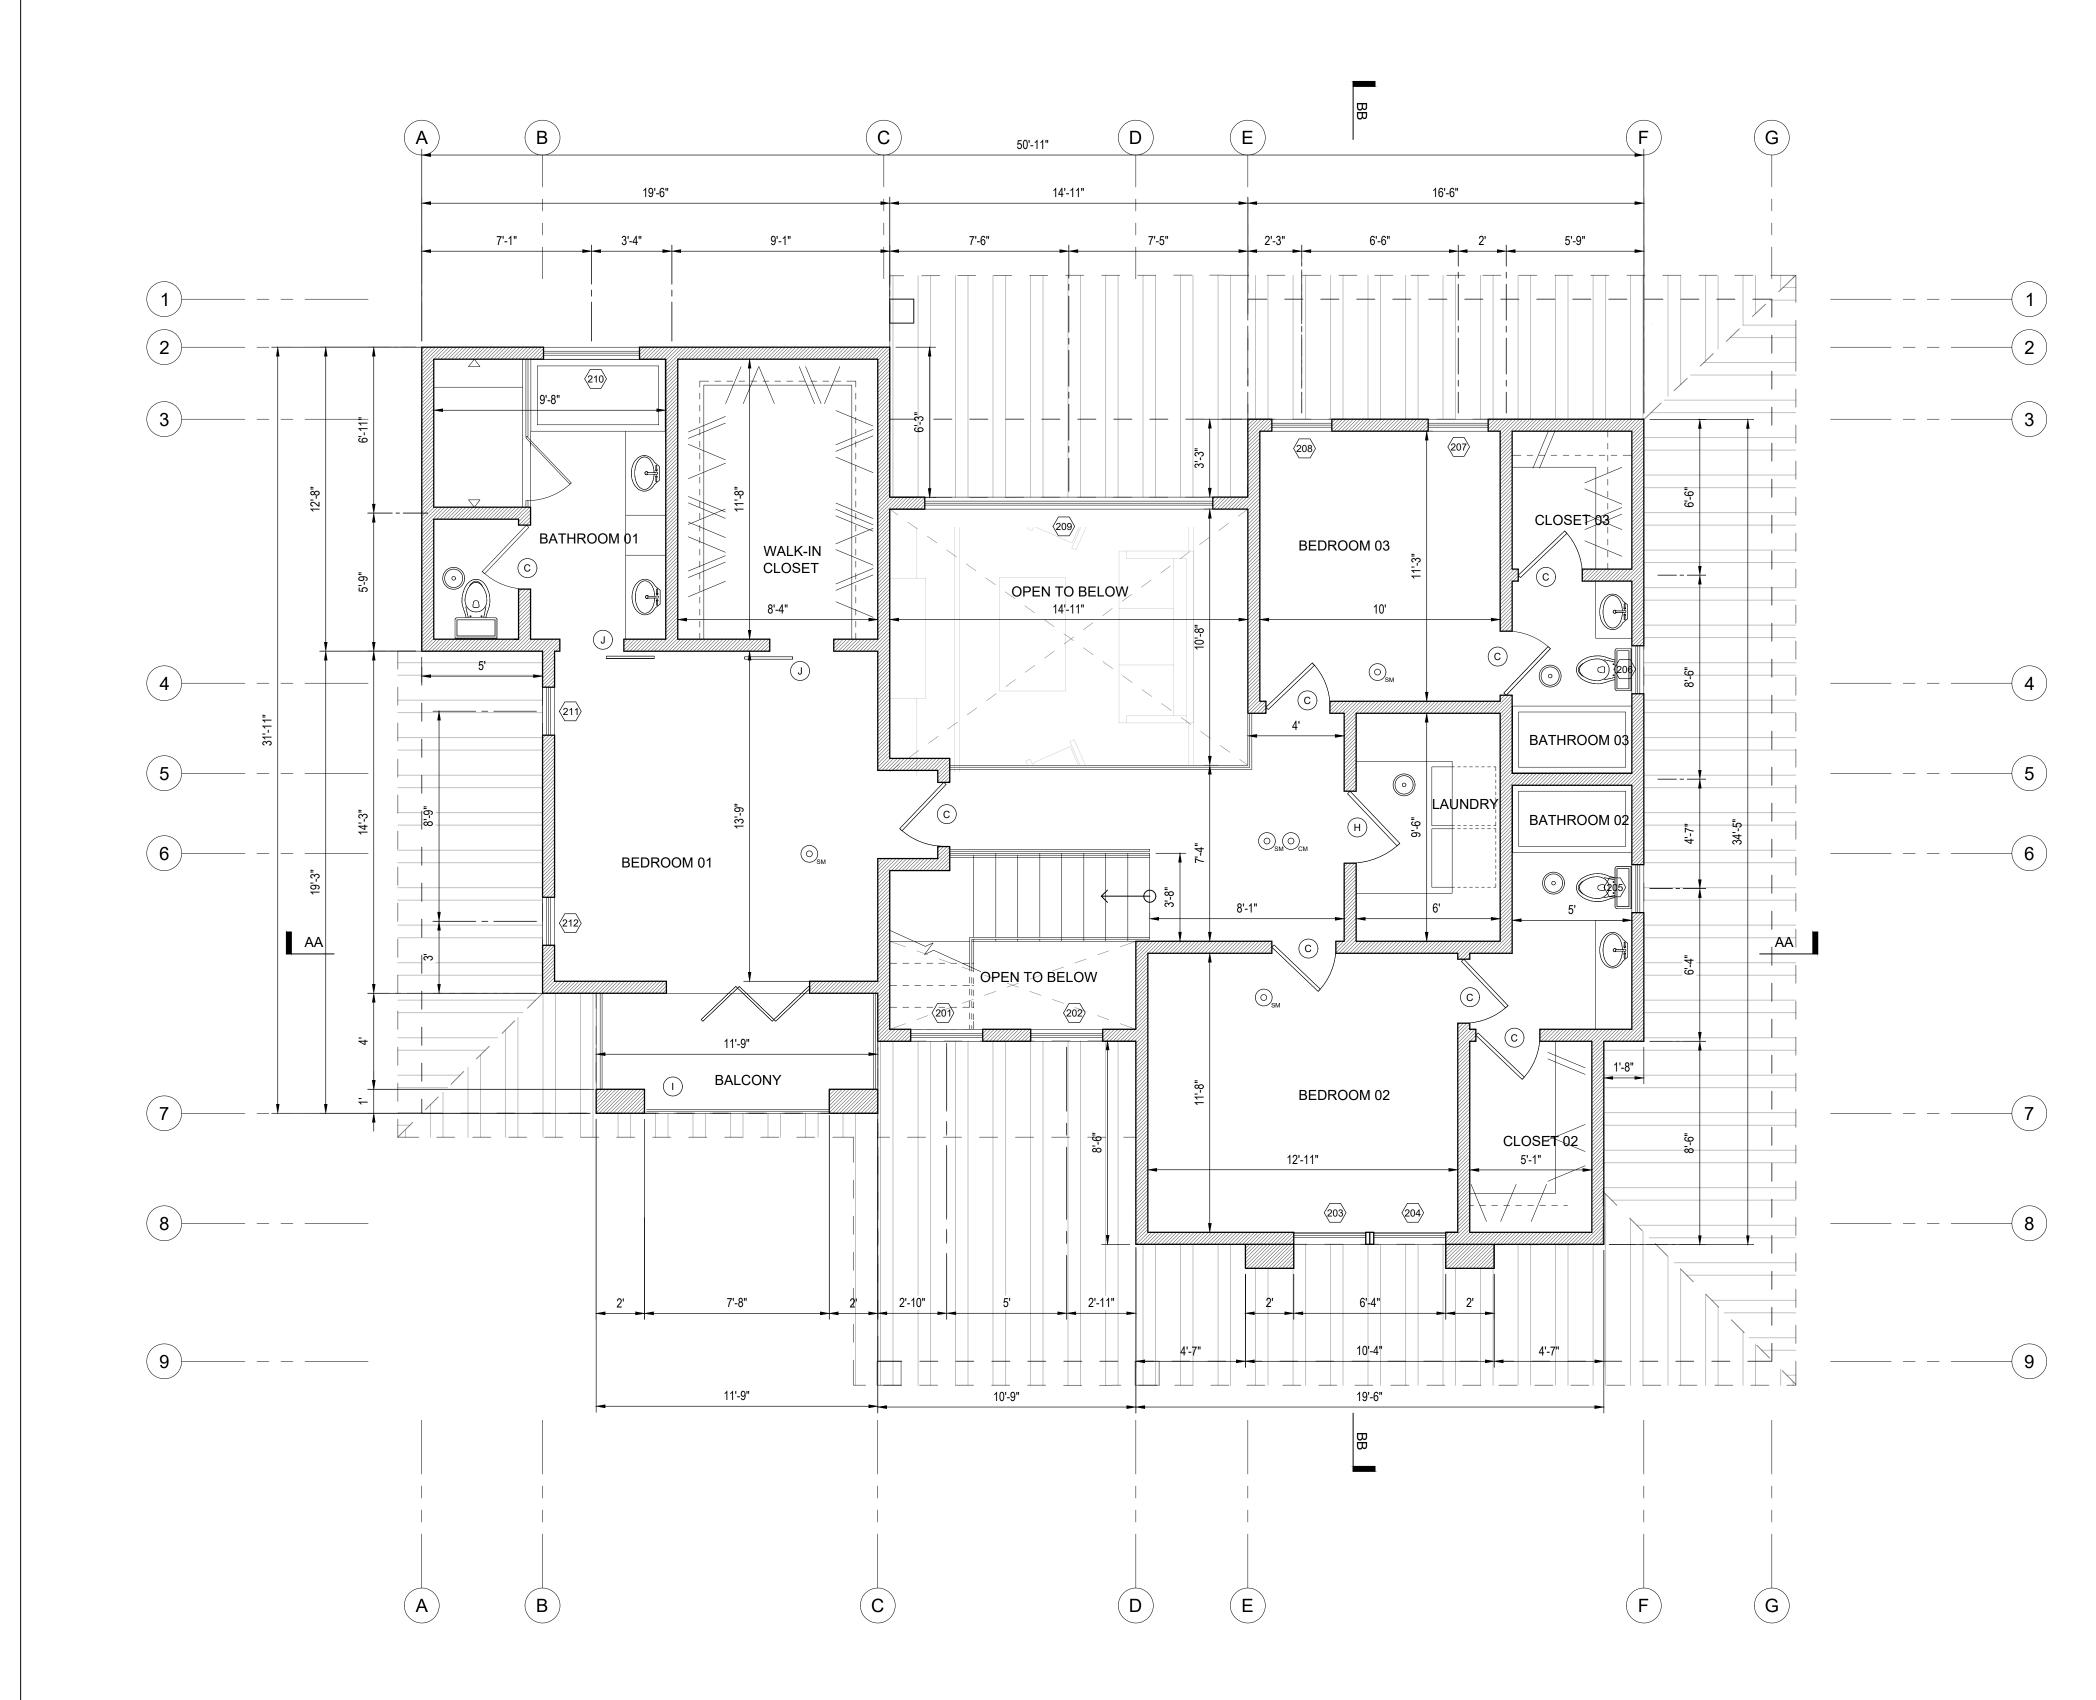

NEW SECOND LEVEL

1/4" = 1'-0"

LOUIS

Design + Planning + Development 28338 Constellation Road, STE900

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CONSULTANT'S STAME

DESCRIPTION

PROJECT TITLE:

Residential Remodel 2306 N KENNETH RD BURBANK, CA 91504

DATE: March 2022 DESIGNED BY: L. Romero


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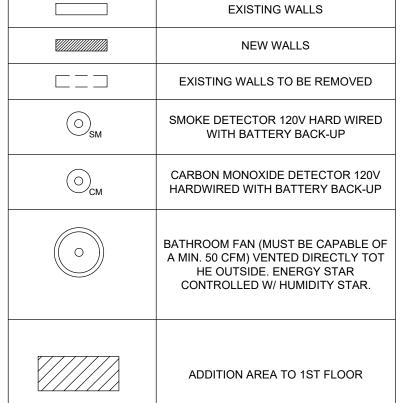
R. Duben

PERMIT NUMBER:

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NEW SECOND LEVEL FLOOR PLAN



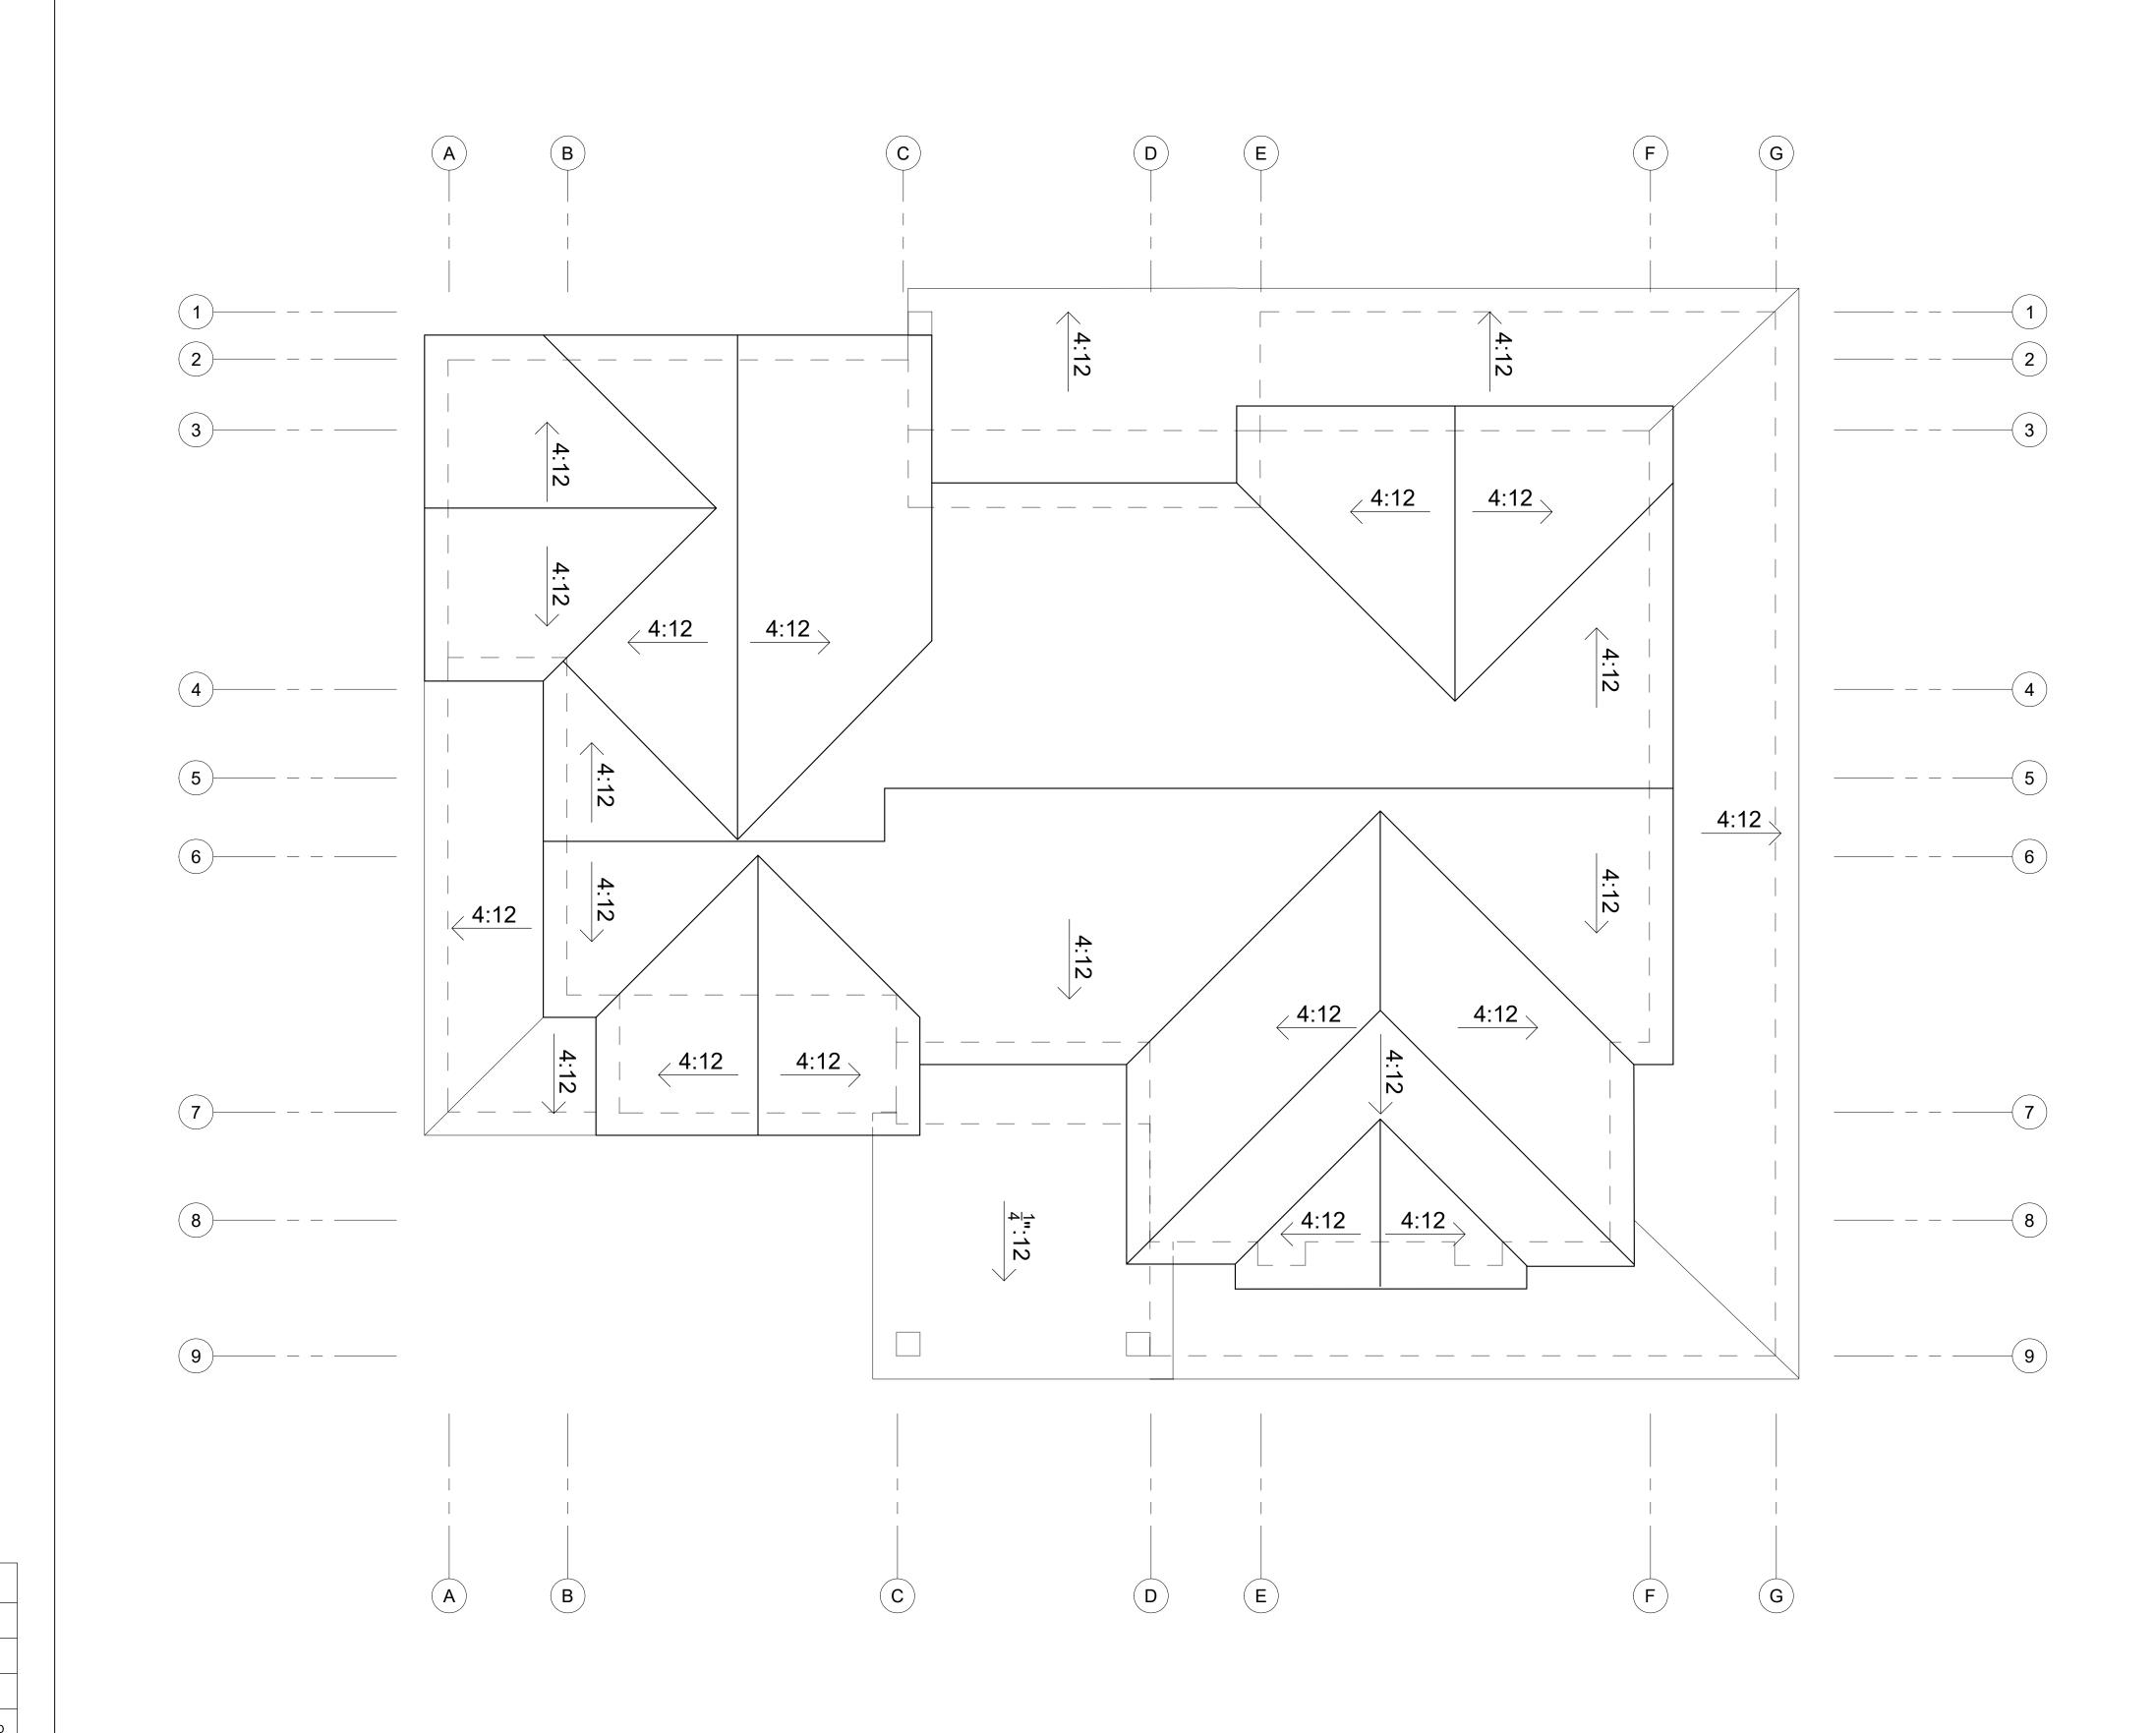

LEGEND

NEW ROOF PLAN

1/4" = 1'-0"

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DESCRIPTION

PROJECT TITLE:

Residential Remodel 2306 N KENNETH RD BURBANK, CA 91504

DATE: March 2022 DESIGNED BY: L. Romero


DRAWN BY: R. Duben

PERMIT NUMBER:

22-0005876-HDP

NEW ROOF PLAN

				DOOF	RSCHEDULE						
SYMBOL	QUANTITY	EXISTING/NEW	WIDTH	HEIGHT	TYPE		MATERIAL		-	NOTES	
Α	1	NEW	3'-0"	8'-0"	1 DOOR - SWING		STEEL			TEMPERED	
В	3	NEW	6'-0"	8'-0"	2 DOOR - SWING		STEEL			TEMPEREI	D
С	11	NEW	2'-8"	6'-8"	1 DOOR - SWING		HOLLOW CORE		RE		
	1	NEW	3'-0"	8'-0"	1 DOOR - SWING					TEMEDDE	
D	I	INEVV	3-0	0-0	1 DOOR - SWING			STEEL		TEMERPE	
E	1	NEW	3'-0"	6'-8"	1 DOOR - SWING			STEEL		20-MIN FIRE R CLOSING LA	•
F	1	NEW	12'-0"	8'-0"	4 DOOR - SLIDER			STEEL		TEMERPED	
G	2	NEW	2'-0"	6'-8"	1 DOOR - BARN SLIE)ER	Н	OLLOW CO	RE		
Н	1	NEW	3'-0"	6'-8"	1 DOOR - SWING		Н	OLLOW CO	RE		
I	1	NEW	6'-0"	8'-0"	3 DOOR - BIFOLD			STEEL		TEMPEREI)
J	2	NEW	2'-8"	6'-8"	1 DOOR - BARN SLID	DER	Н	OLLOW CO	RE		
K	1	NEW	16'-0"	8'-0"	GARAGE - ROLL U	Р		STEEL			
				WINDC	W SCHEDULE						
SYMBOL	EXISTING/NEV	N LOCATION	WIDTH	HEIGHT	TYPE	MATE	RIAL	GLAZING	TEMPERED	U-FACTOR	SHGC
LEVEL 1			L					1		L	
101	NEW	ENTRY	3'-0"	6'-0"	SINGLE HUNG	VIN	YL	DUAL		.3	.23
102	NEW	LIVING ROOM	M 3'-0"	6'-0"	SINGLE HUNG	VIN	YL	DUAL		.3	.23
103	NEW	DINING ROOI	M 3'-0"	6'-0"	SINGLE HUNG	VIN	YL	DUAL		.3	.23
104	NEW	DINING ROOI	M 3'-0"	6'-0"	SINGLE HUNG	VIN	YL	DUAL		.3	.23
105	NEW	KITCHEN	4'-0"	4'-6"	SINGLE HUNG	VIN	YL	DUAL	TEMPERED	.3	.23
106	NEW	DINING	3'-0"	6'-0"	SINGLE HUNG	VIN	YL	DUAL		.3	.23
107	EXISTING	KITCHEN	3'-0"	5'-0"	SINGLE HUNG	VIN	YL	DUAL		.3	.23
108	EXISTING	KITCHEN	3'-0"	5'-0"	SINGLE HUNG	VIN	YL	DUAL		.3	.23
109	EXISTING	KITCHEN	3'-0"	5'-0"	SINGLE HUNG	VIN	YL	DUAL		.3	.23
110	EXISTING	KITCHEN	2'-0"	5'-0"	SINGLE HUNG	VIN	YL	DUAL		.3	.23
LEVEL 2											
201	NEW	FOYER	3'-0"	1'-6"	FIXED	VIN	YL	DUAL		.3	.23
202	NEW	FOYER	3'-0"	1'-6"	FIXED	VIN	YL	DUAL		.3	.23
203	NEW	BEDROOM 0	2 3'-0"	4'-0"	SINGLE HUNG	VIN	YL	DUAL		.3	.23
204	NEW	BEDROOM 0	2 3'-0"	4'-0"	SINGLE HUNG	VIN	YL	DUAL		.3	.23
205	NEW	BATHROOM ()2 2'-0"	3'-0"	SINGLE HUNG	VIN	YL	DUAL	TEMPERED	.3	.23
206	NEW	BATHROOM ()3 2'-0"	3'-0"	SINGLE HUNG	VIN	YL	DUAL	TEMPERED	.3	.23
207	NEW	BEDROOM 0	3 2'-6"	4'-0"	CASEMENT	VIN	YL	DUAL		.3	.23
208	NEW	BEDROOM 0	3 2'-6"	4'-0"	CASEMENT	VIN	YL	DUAL		.3	.23
209	NEW	FAMILY ROO	M 12'-0"	8'-0"	4 PANELS - FIXED	VIN	YL	DUAL		.3	.23
210	NEW	BATHROOM (01 4'-0"	4'-0"	SINGLE HUNG	VIN	YL	DUAL	TEMPERED	.3	.23
211	NEW	BEDROOM 0	1 2'-0"	4'-0"	CASEMENT	VIN	YL	DUAL		.3	.23
212	NEW	BEDROOM 0	1 2'-0"	4'-0"	CASEMENT	VIN	YL	DUAL		.3	.23

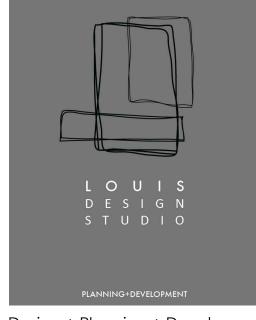

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DESCRIPTION


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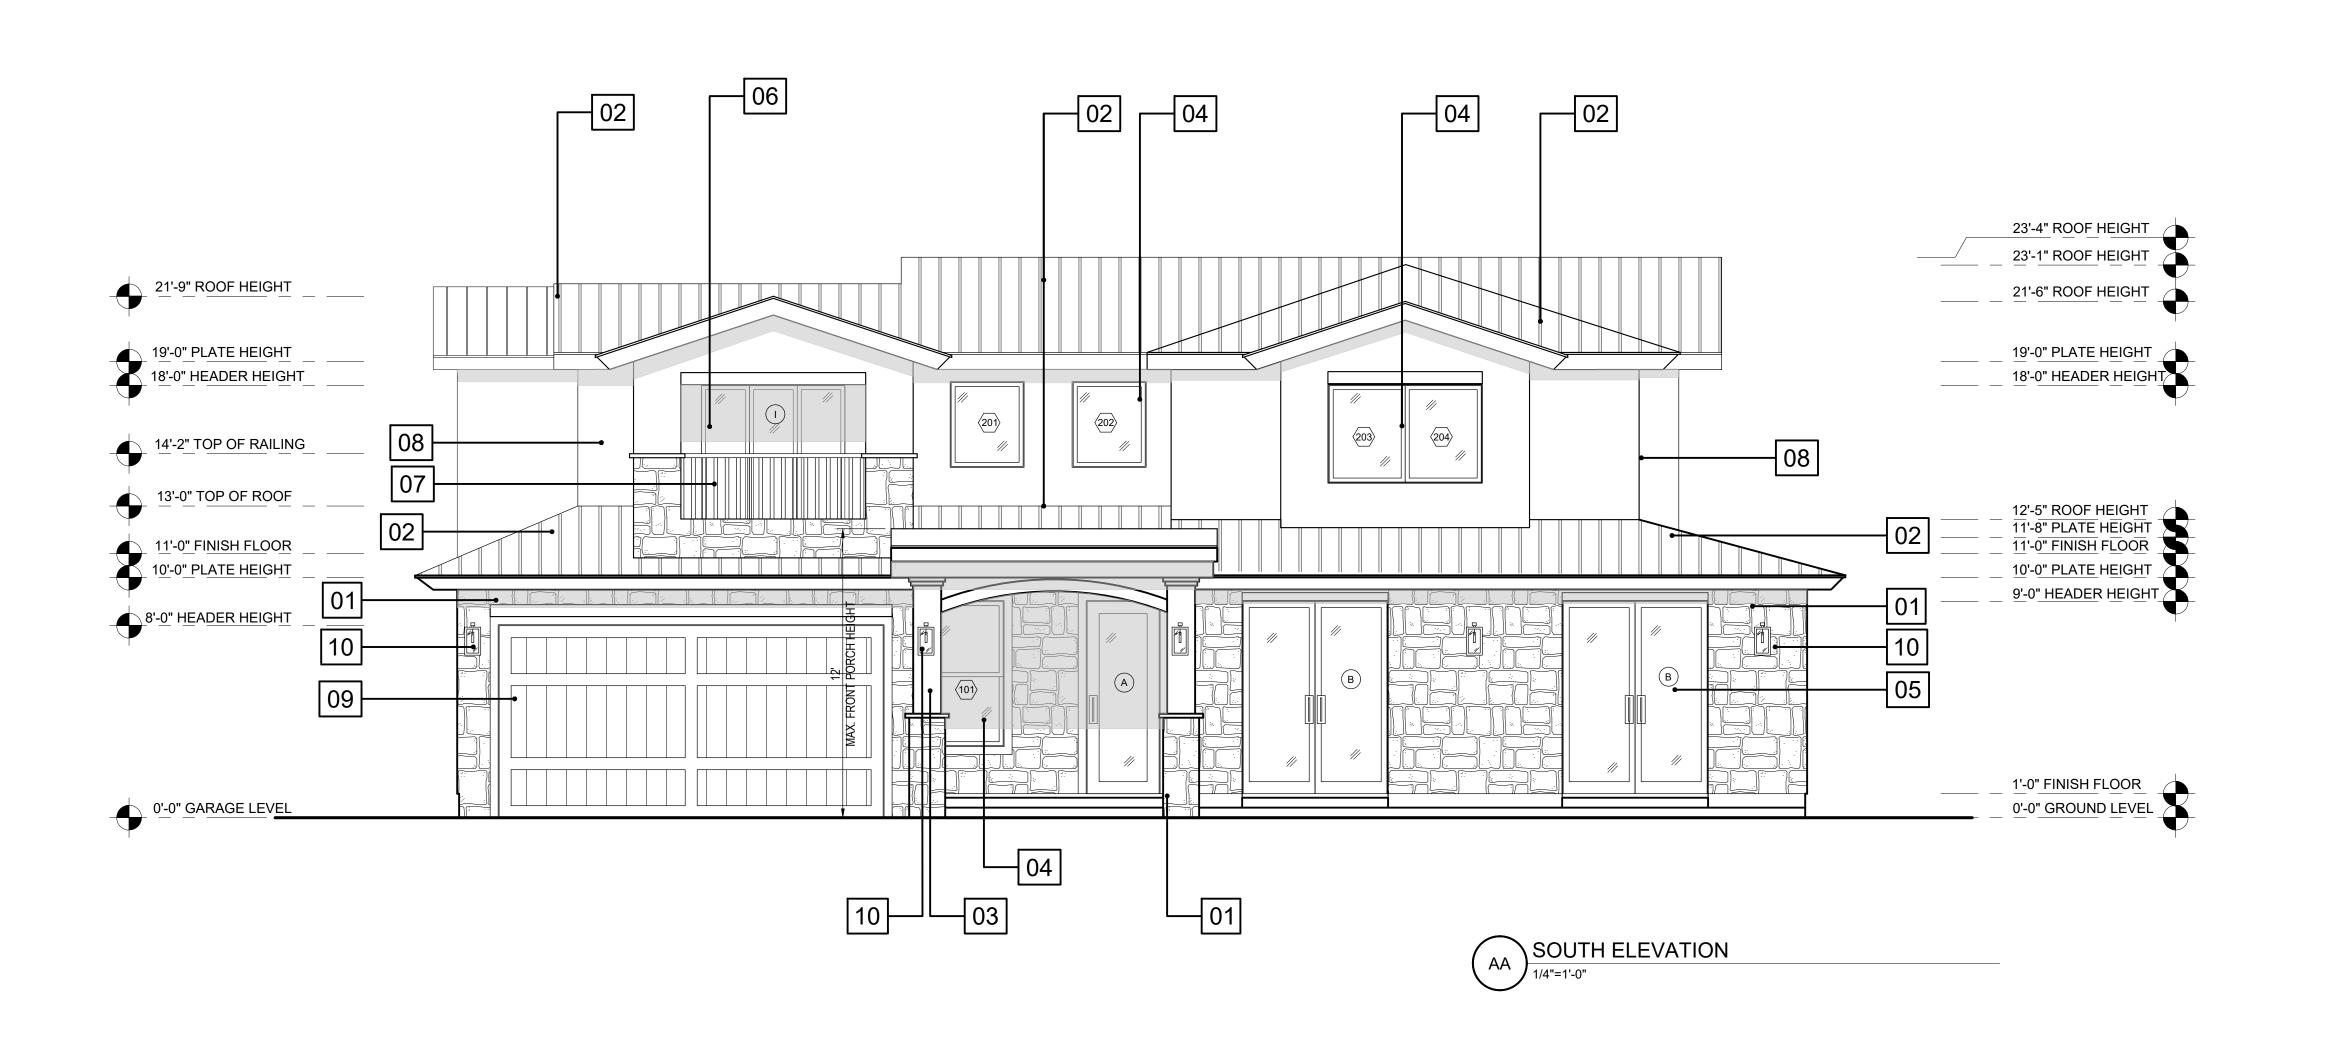
Residential Remodel 2306 N KENNETH RD BURBANK, CA 91504


March 2022 L. Romero R. Duben

22-0005876-HDP


DOOR AND WINDOW SCHEDULE



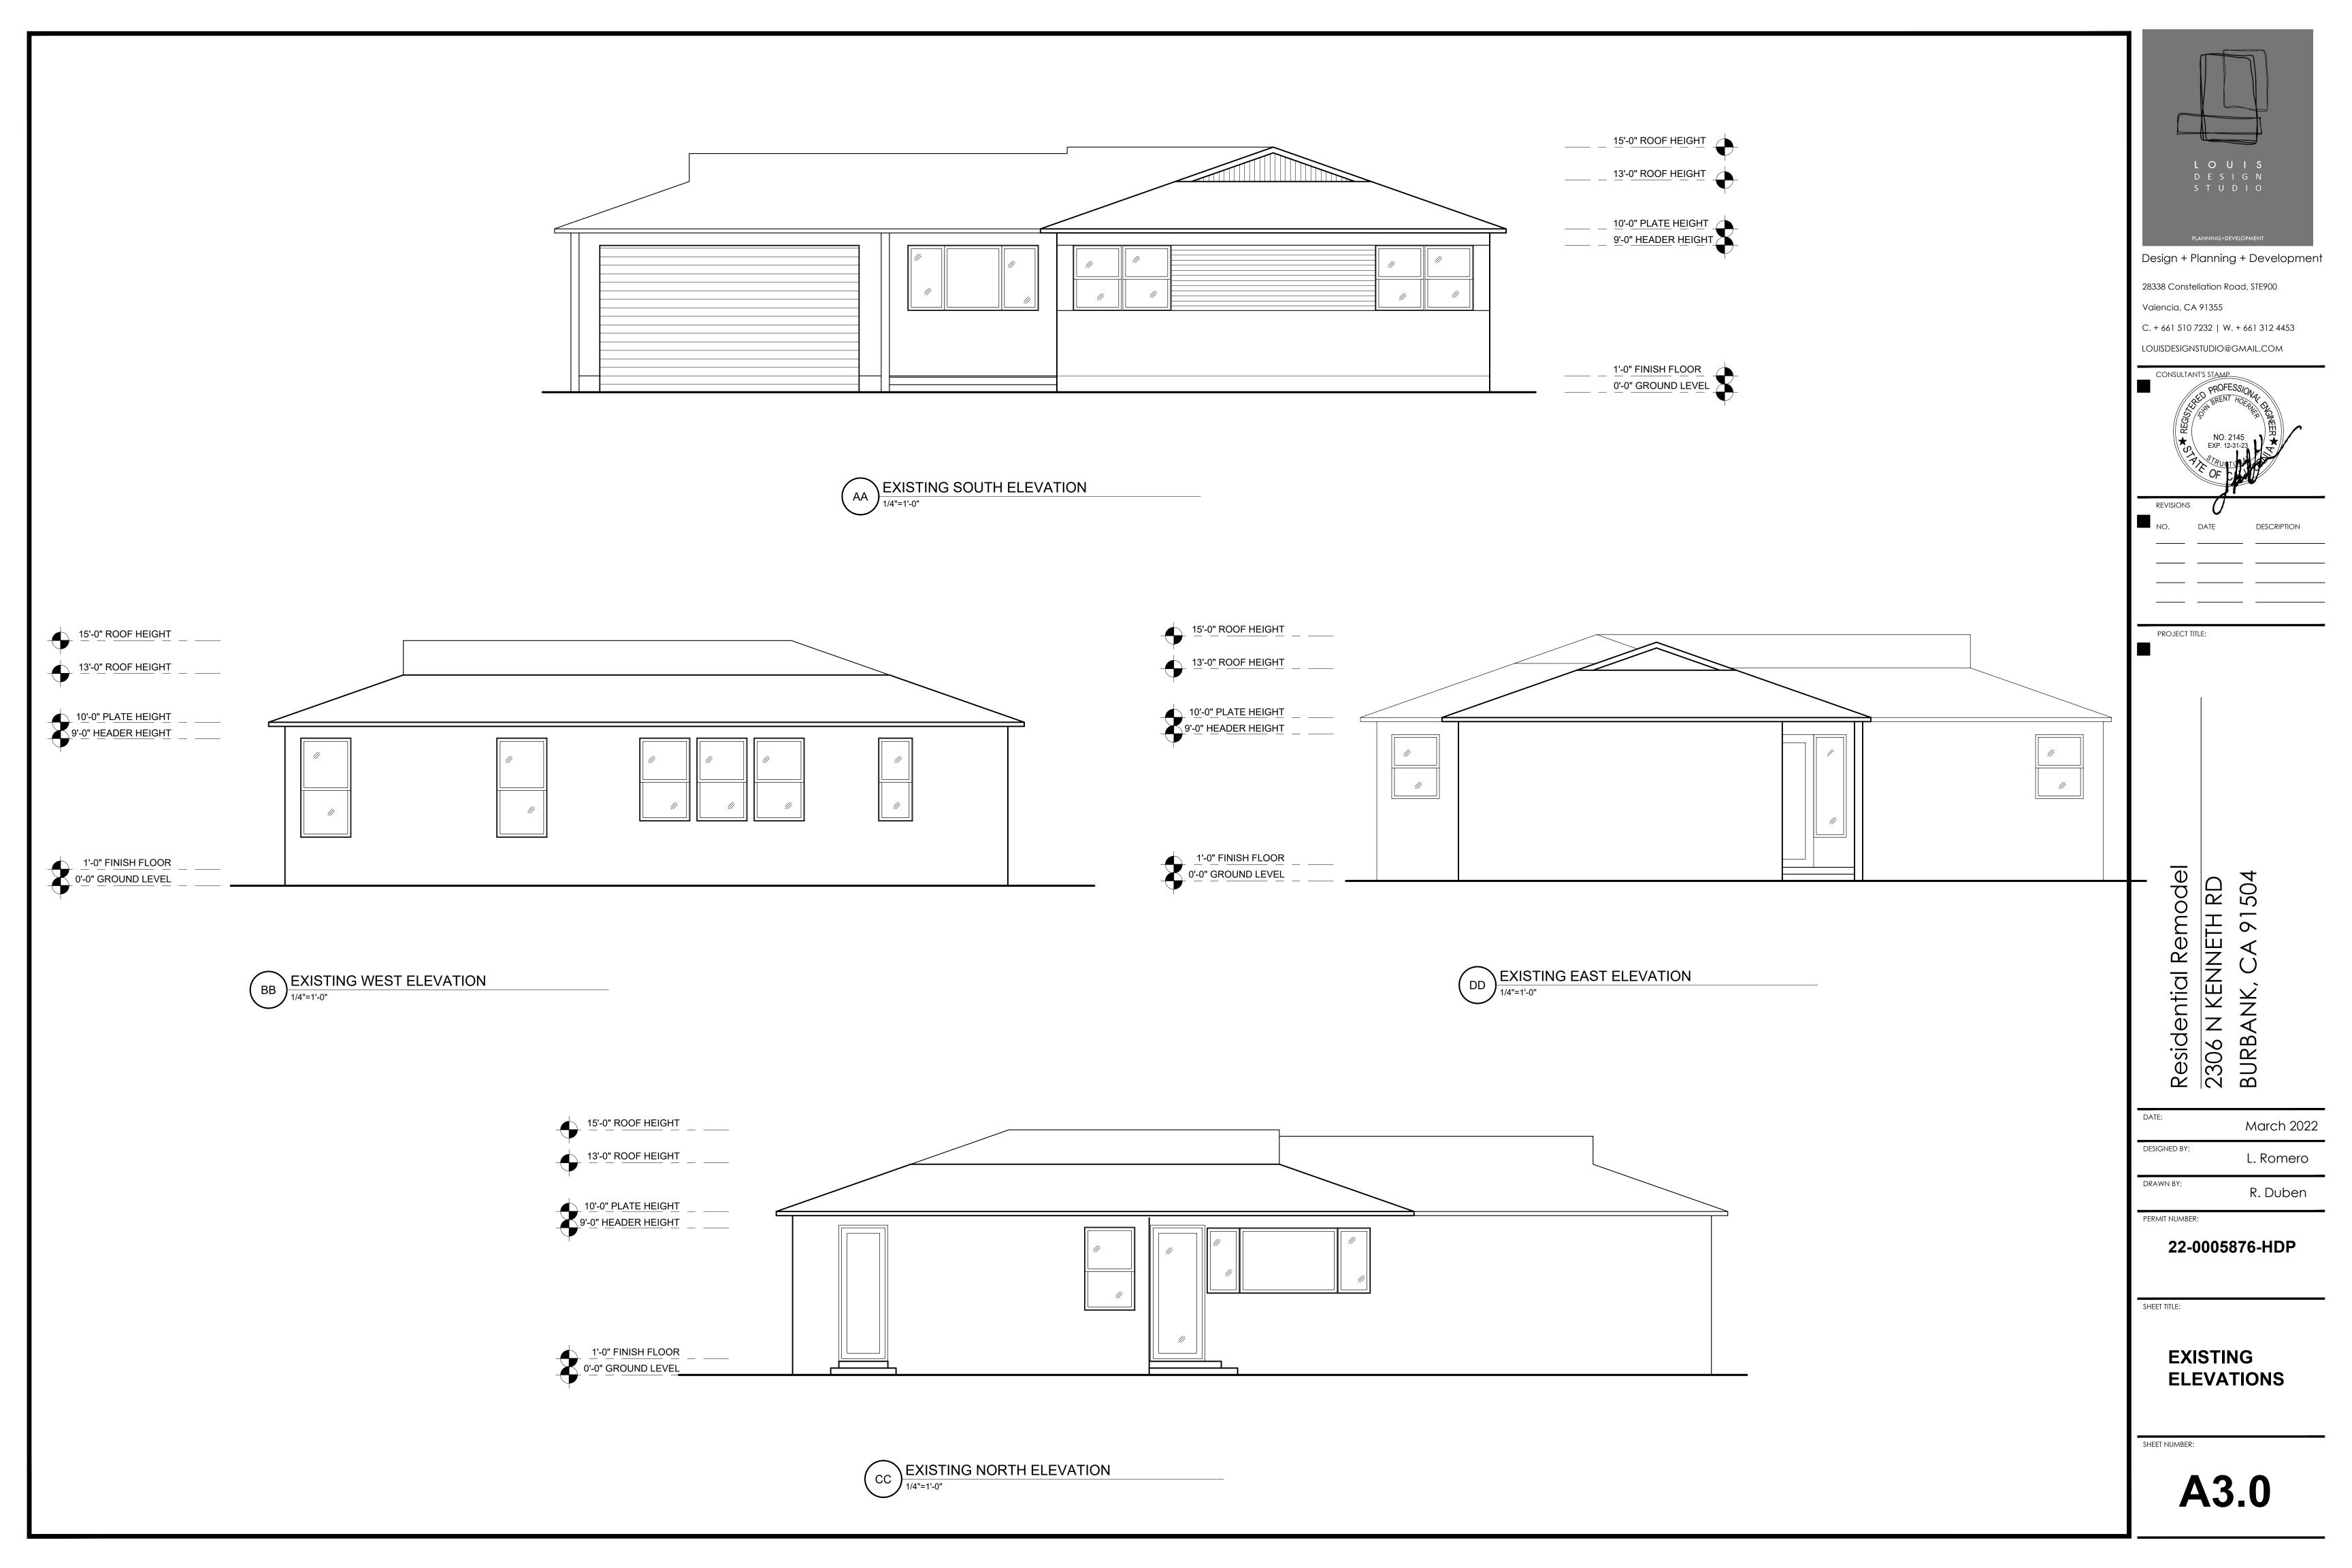

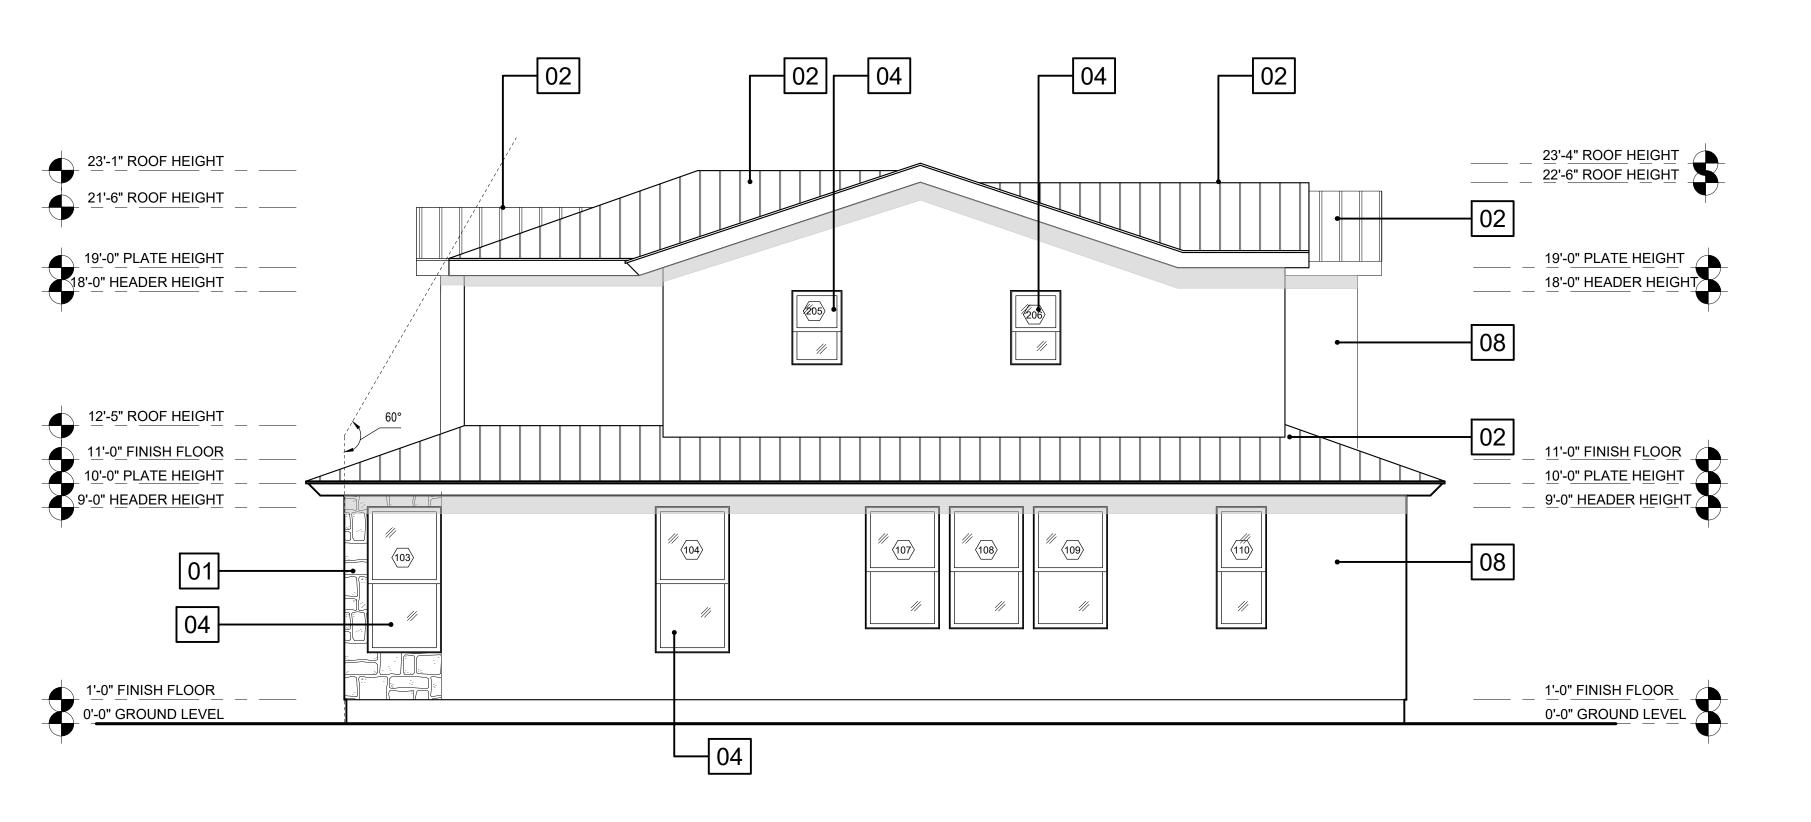



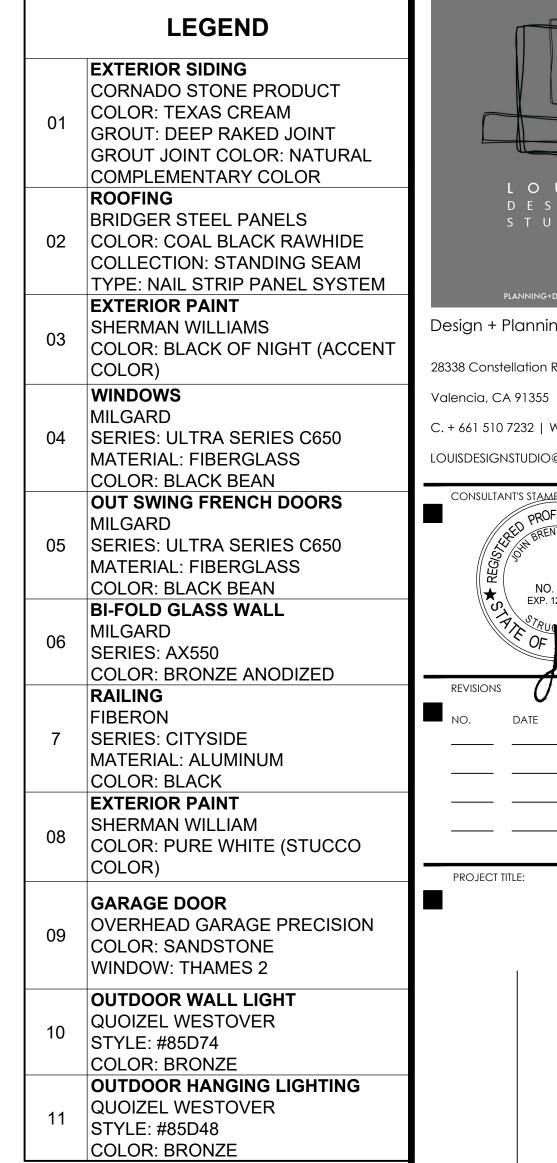

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CONSULTANT'S STAMP PROFESSION BRENT HOS

REVISIONS DESCRIPTION

PROJECT TITLE:

Residential Remodel 2306 N KENNETH RD BURBANK, CA 91504

DATE: March 2022 DESIGNED BY: L. Romero

R. Duben

22-0005876-HDP


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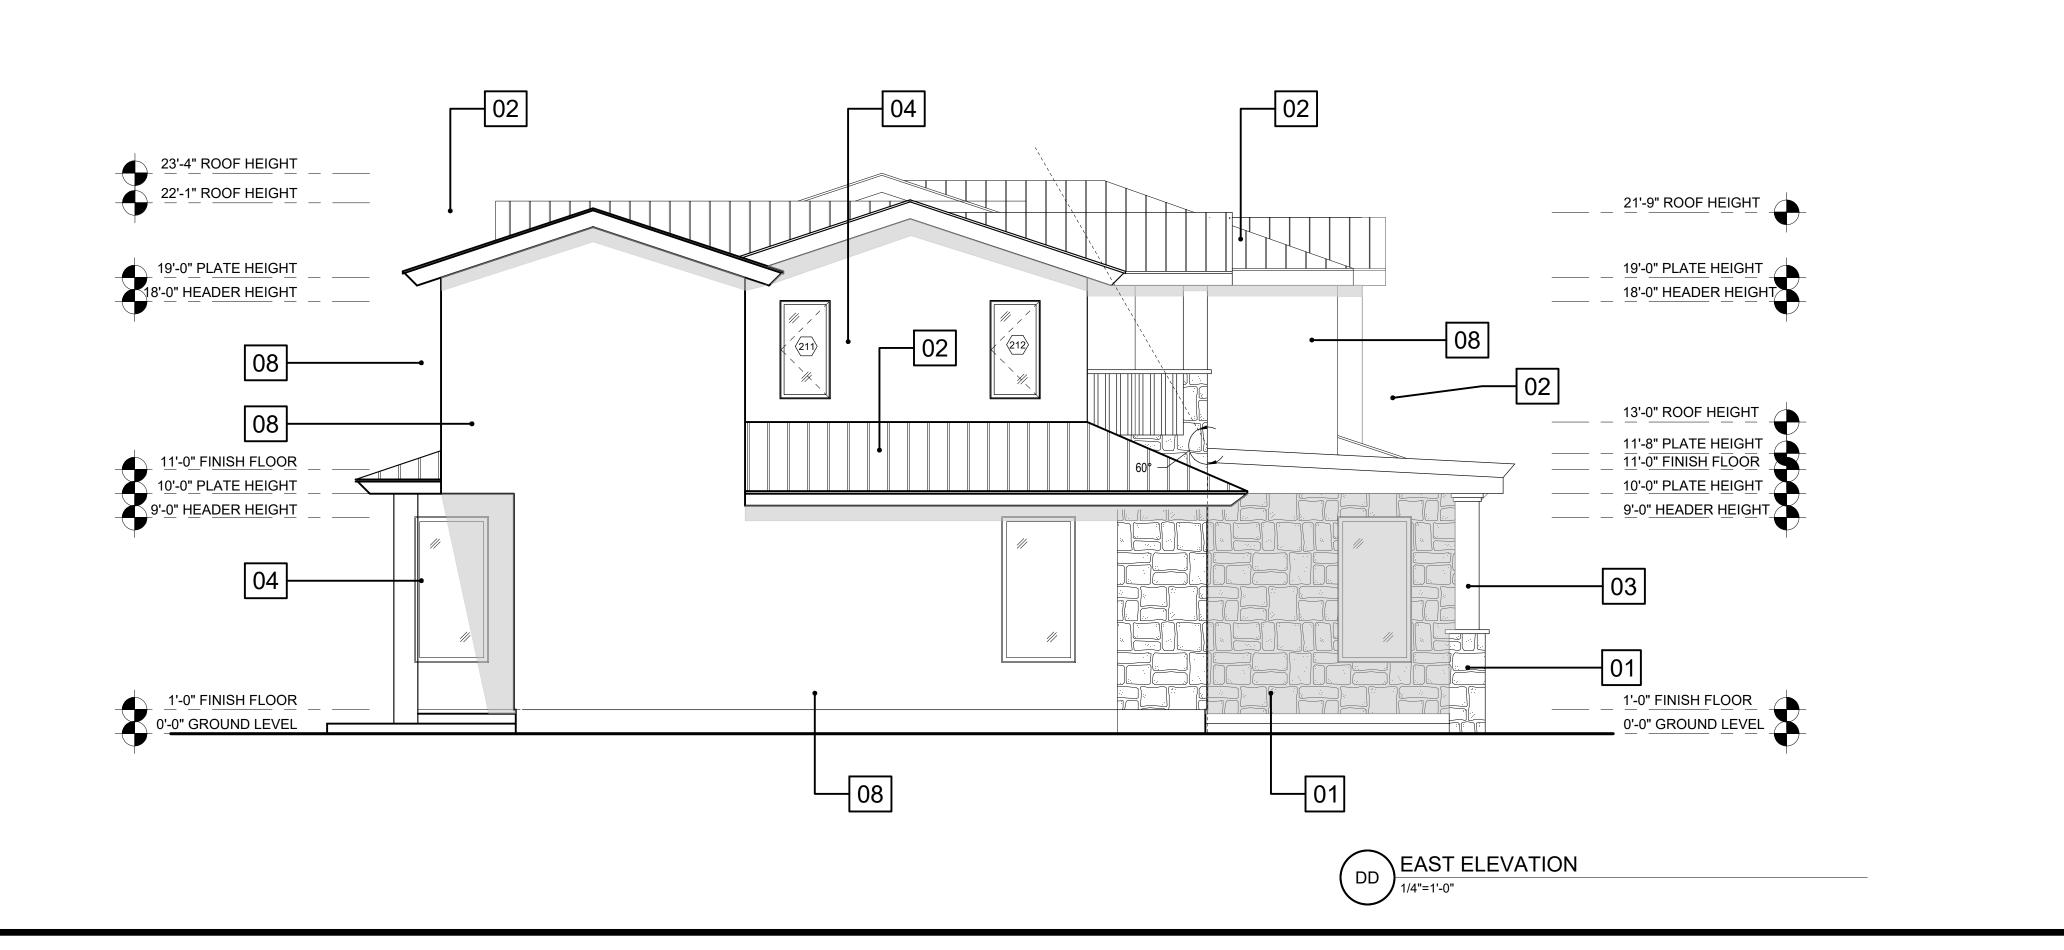
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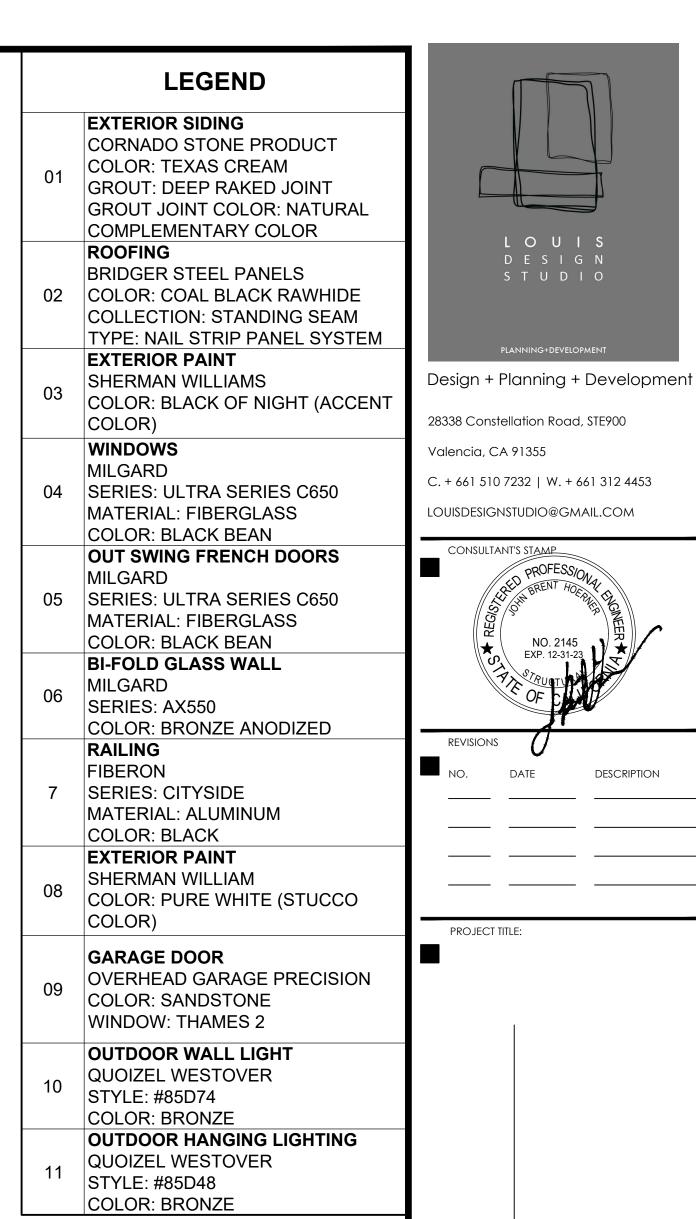
NEW ELEVATIONS

SHEET NUMBER:

A3.1





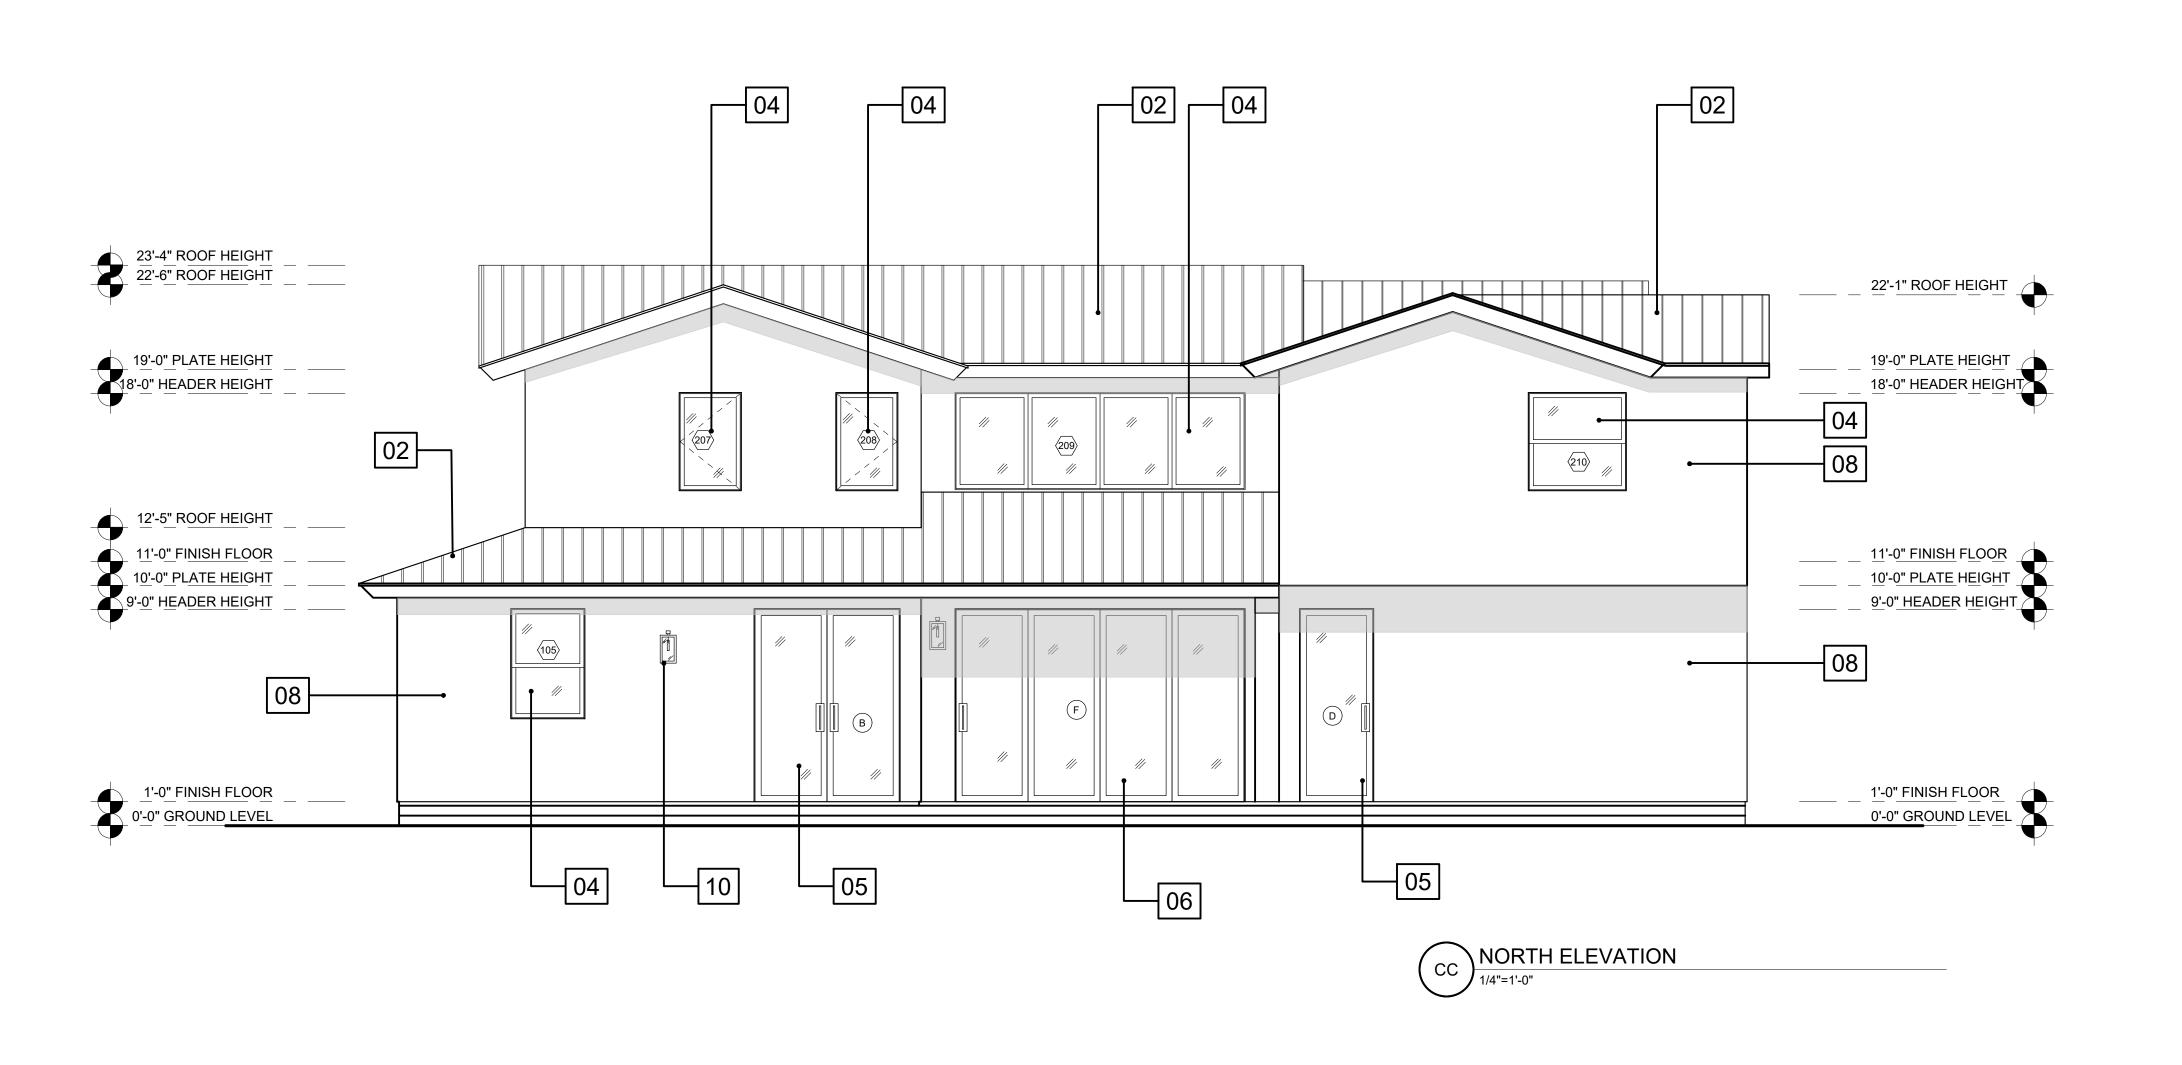

Residential Remodel 2306 N KENNETH RD BURBANK, CA 91504

DESIGNED BY:

L. Romero

DRAWN BY:

R. Duben

PERMIT NUMBER:

22-0005876-HDP

CHEET TITI E

NEW ELEVATIONS

SHEET NUMBER:

A3.2



CORONADO STONE PRODUCTS COLOR: TEXAS CREAM GROUT: DEEP RAKED JOINT GROUT JOINT COLOR: NATURAL COMPLEMENTARY COLOR



MILGARD WINDOWS SERIES: ULTRA SERIES C650 MATERIAL: FIBERGLASS COLOR: BLACK BEAN



FIBERON RAILING SERIES: CITYSIDE MATERIAL: ALUMINUM COLOR: BLACK



QUOIZEL WESTOVER OUTDOOR WALL LIGHT STYLE: #85D74 COLOR: BRONZE



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LOUISDESIGNSTUDIO@GMAIL.COM

Valencia, CA 91355

CONSULTANT'S STAME

REVISIONS

PROJECT TITLE:

DATE

DESCRIPTION

BRIDGERSTEEL PANELS COLOR: COAL BLACK RAWHIDE COLLECTION: STANDING SEAM TYPE: NAIL STRIP PANEL SYSTEM



MILGARD OUT-SWING FRENCH DOORS SERIES: ULTRA SERIES C650 MATERIAL: FIBERGLASS COLOR: BLACK BEAN



80

SHERMAN WILLIAMS, EXTERIOR PAINT COLOR: PURE WHITE STUCCO COLOR



QUOIZEL WESTOVER **OUTDOOR HANGING LIGHT** STYLE: #85D48

02

SW 6993

03

Black of Night Interior / Exterior Location Number: 251-C5

SHERMAN WILLIAMS, EXTERIOR PAINT COLOR: BLACK OF NIGHT ACCENT COLOR



MILGARD BI-FOLD GLASS WALL SERIES: AX550 MATERIAL: ALUMINUM COLOR: BRONZE ANODIZED



06


02


OVERHEAD GARAGE PRECISION DOOR SERVICE **GARAGE DOOR COLOR: SANDSTONE** WINDOW: THAMES 2



11

COLOR: BRONZE

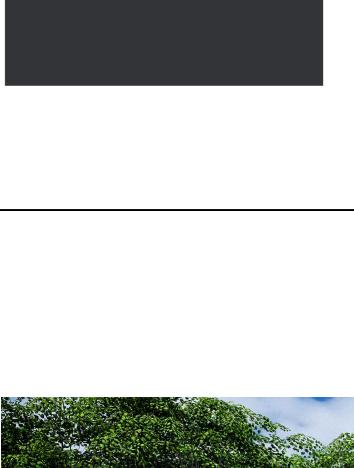

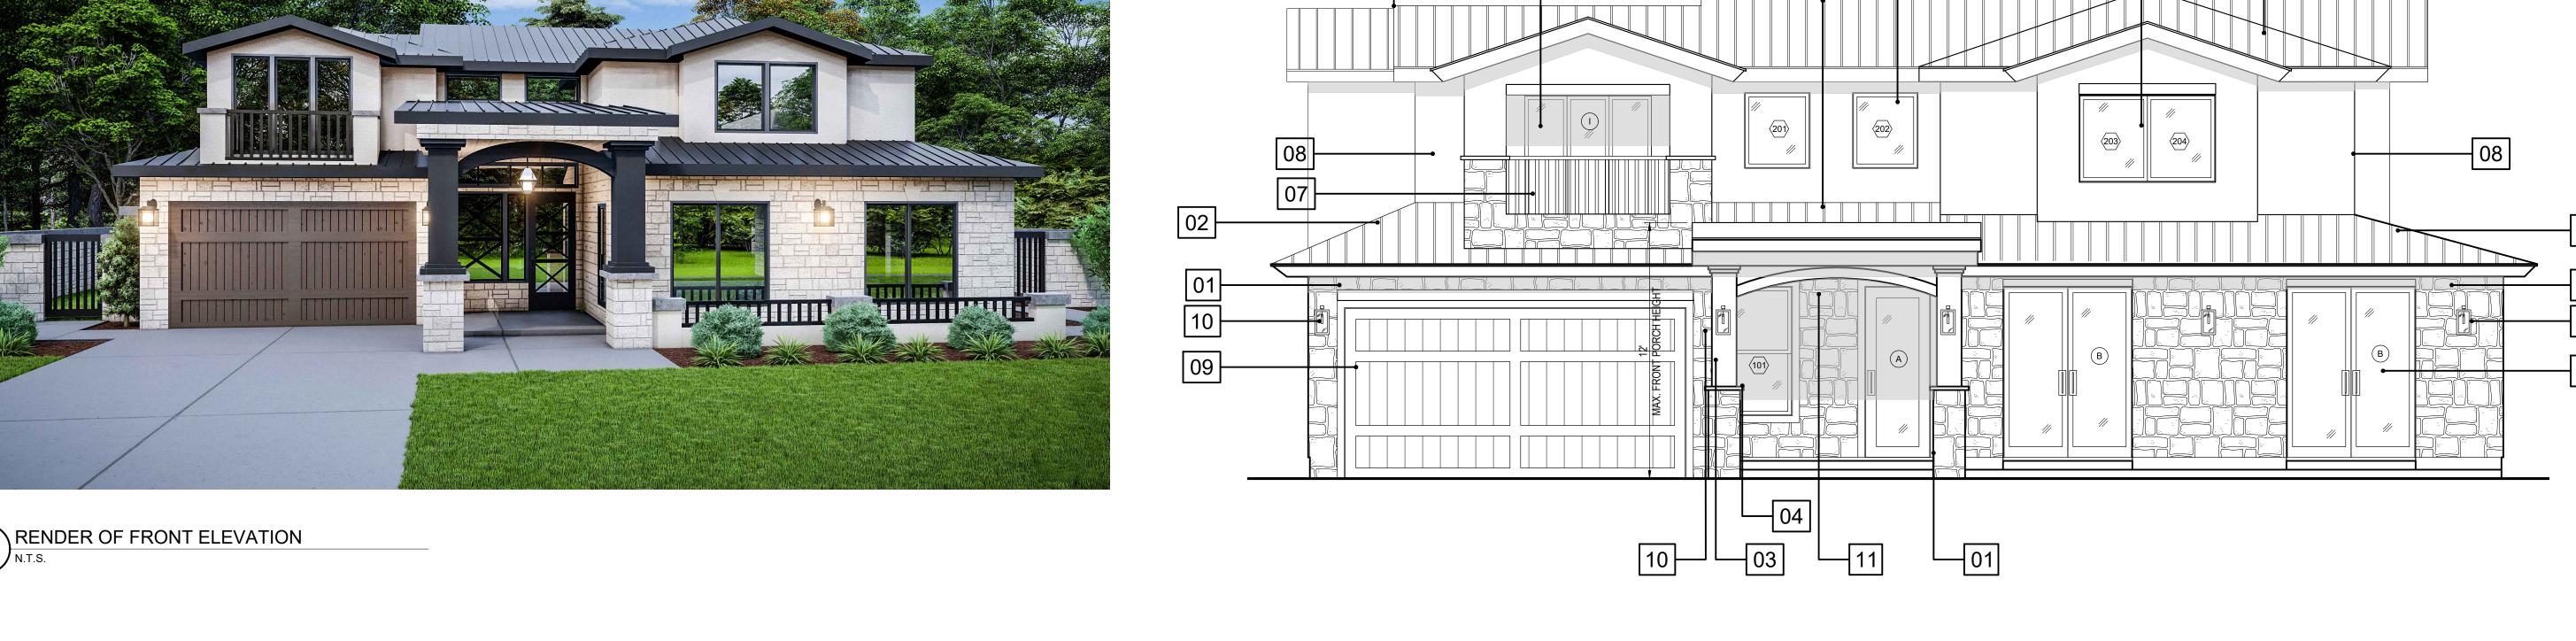


2306 N KENNETH RD BURBANK, CA 91504 March 2022 DESIGNED BY: L. Romero R. Duben


MATERIAL

PALETTE


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A3.3



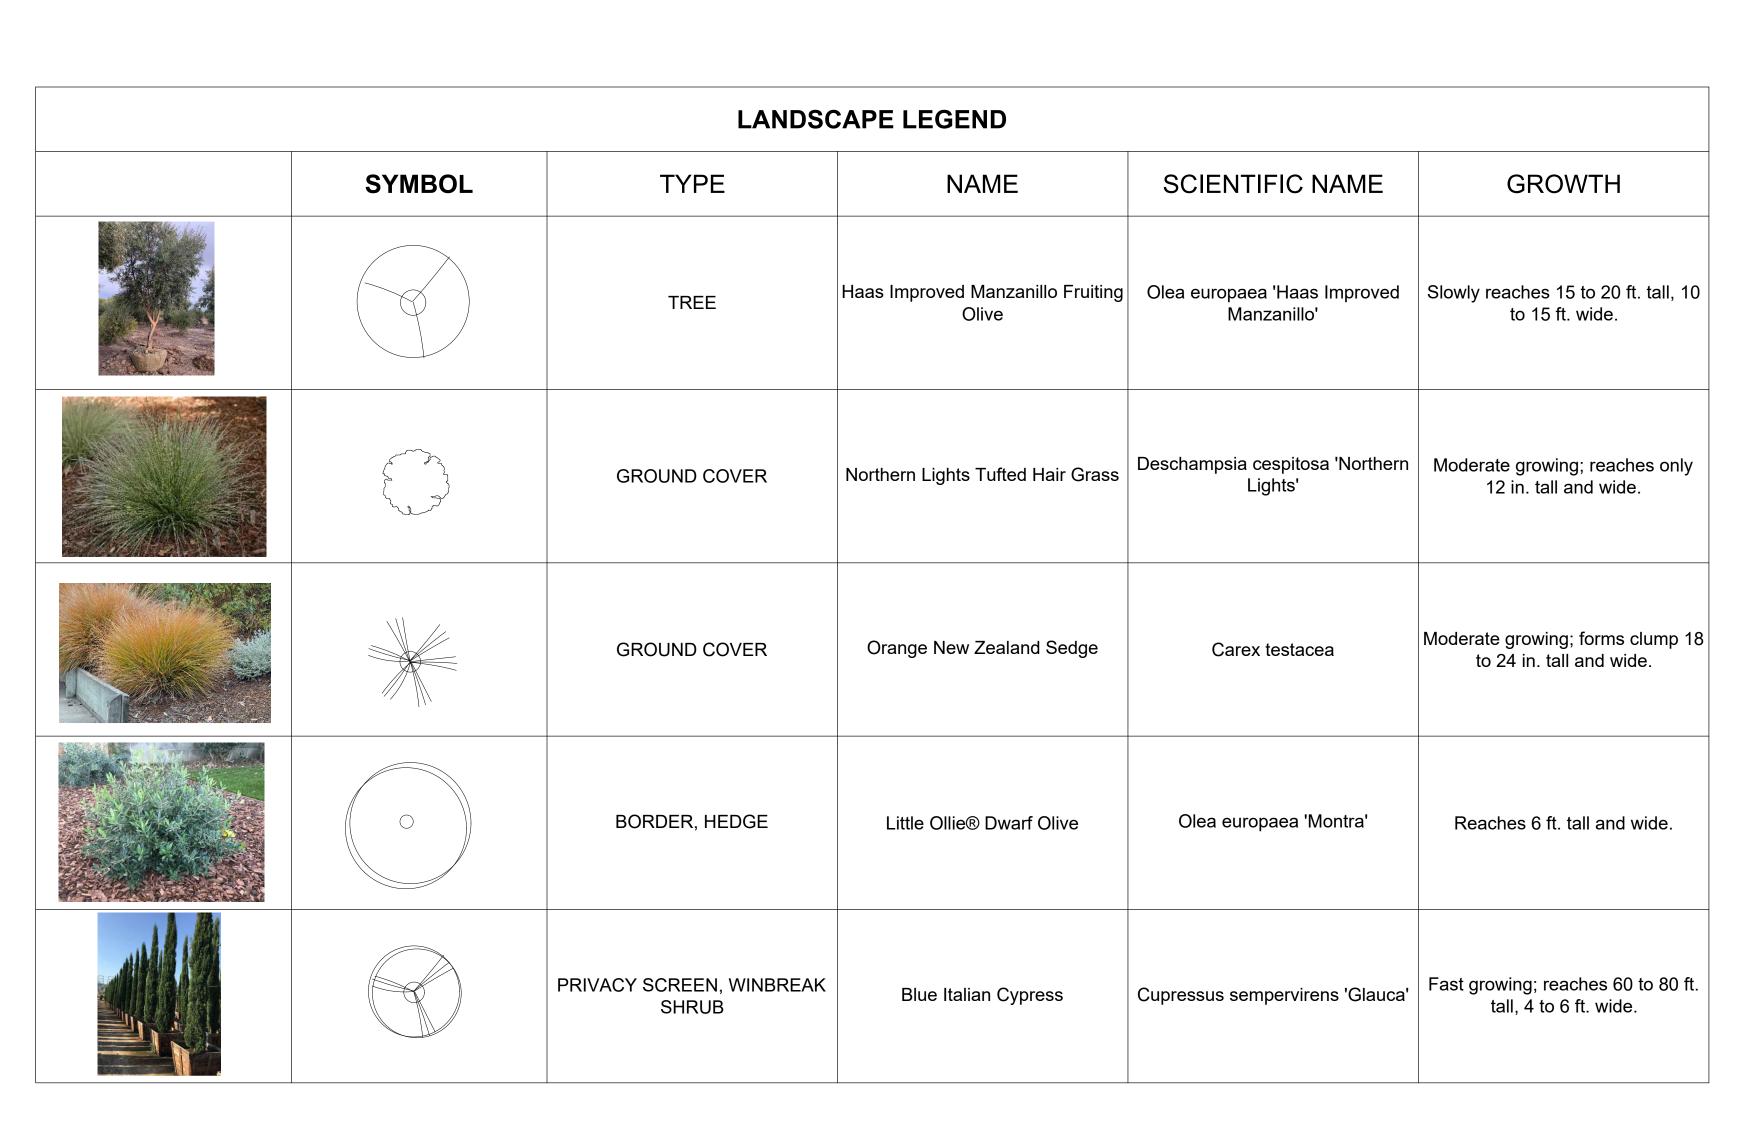

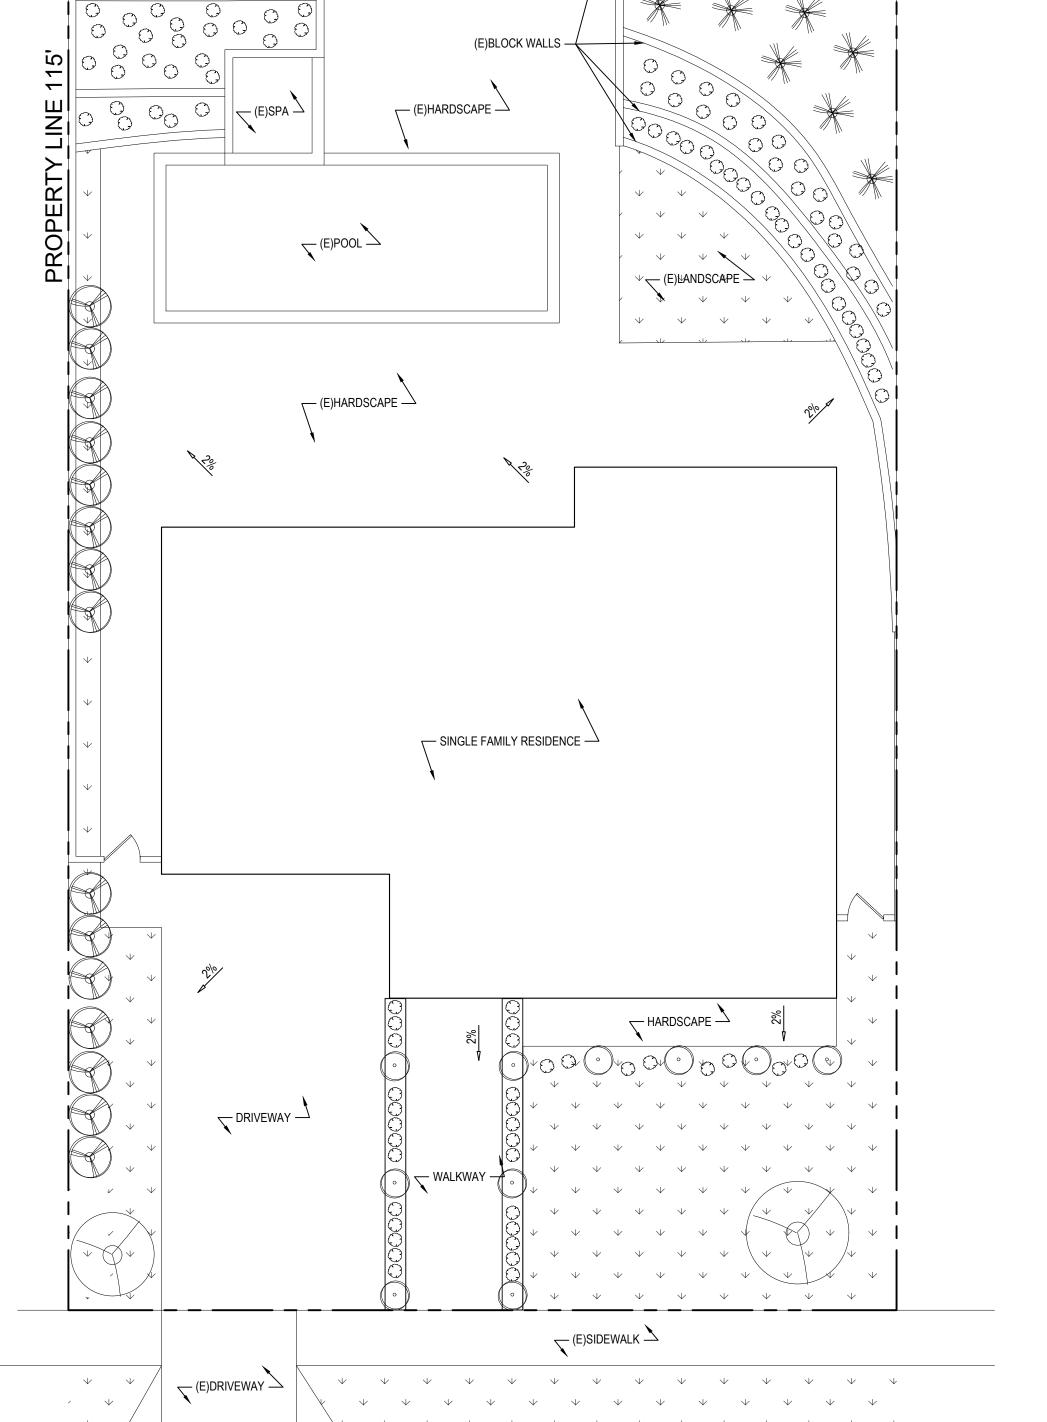PROPERTY LINE 69'

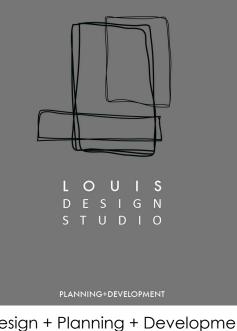

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PROJECT TITLE:

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DATE: March 2022 DESIGNED BY: L. Romero

R. Duben

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DRAWN BY:

PERMIT NUMBER:

LANDSCAPE **PLAN**