1018 N SUNSET CANYON DR, BURBANK, CA 91504

KAMILLA KHUDYAKOVA

STORM WATER MANAGEMENT NOTES:

- 1. Eroded sediments and other pollutants must be retained on site and may not be transported from the site via sheetflow, swales, area drains, natural drainage courses or winds.
- 2. Stockpiles of earth and other construction related materials must be protected from being transported from the site by the forces of wind or water.
- 3. Fuels, oils, solvents and other toxic materials must be stored in accordance with their listing and are not to contaminate the soil and surface waters. All approved storage containers are to be protected from the weather. Spills must be cleaned up immediately and disposed of in a proper manner. Spills may not be washed into the drainage system.
- 4. Non-stormwater runoff from equipment and vehicle washing and any other activity shall be contained at the project site. 5. Excess or waste concrete may not be washed into the public way or any other drainage system. Provisions shall be
- made to retain concrete wastes on site until they can be disposed of as solid waste.
- 6. Trash and construction related solid wastes must be deposited into a covered receptacle to prevent contamination of rainwater and dispersal by wind.
- 7. Sediments and other materials may not be tracked from the site by vehicle traffic. The construction entrance roadways must be stabilized so as to inhibit sediments from being deposited into the public way.
- 8. Accidental depositions must be swept up immediately and may not be washed down by rain or other means.
- 9. Any slopes with disturbed soils or denuded of vegetation must be stabilized so as to inhibit erosion by wind and water. 10. Schedule construction activity to reduce area and duration of soil exposed to erosion by wind, rain, runoff and vehicle

BACKWATER VALVE TO BE INSTALLED ON PRIVATE BUILDING SEWER PER BMC 8-1-313 AND REQUIREMENTS OF THE CITY'S CDD-BUILDING DEPARTMENT. IT IS NOTED AND ACKNOWLEDGED THAT CITY STAFF WILL NOT SIGN OFF ON THE FINAL BUILDING PERMIT APPROVAL AND/OR CERTIFICATE OF OCCUPANCY UNTIL THE OWNER/DEVELOPER PROVIDES PROOF THAT THE BACKWATER VALVE(S) HAVE BEEN INSTALLED.

PER BMC 9-3-407, BEST MANAGEMENT PRACTICES SHALL APPLY TO ALL CONSTRUCTION PROJECTS AND SHALL BE REQUIRED FROM THE TIME OF LAND CLEARING, DEMOLITION OR COMMENCEMENT OF CONSTRUCTION UNTIL RECEIPT OF A CERTIFICATE OF OCCUPANCY.

EFFECTIVE JANUARY 1, 2017 NEW INSTALLATION GAS WATER HEATER SHALL HAVE ALL THE FOLLOWING AS PER 2016 ENERGY STANDARDS 150.0 (N):

- 1) A 120V ELECTRICAL RECEPTACLE IS WITHIN 3 FEET FROM THE WATER HEATER AND ACCESSIBLE WITH NO OBSTRUCTIONS.
- 2) A CATEGORY III OR IV VENT, OR A TYPE B VENT WITH STRAIGHT PIPE BETWEEN OUTSIDE AND WATER HEATER.
- 3) A CONDENSATE DRAIN NO MORE THAN 2 INCHES HIGHER THAN THE BASE ON WATER HEATER FOR NATURAL DRAINING.
- 4) A GAS SUPPLY LINE WITH CAPACITY OF AT LEAST 200,000 BTU/HR.

ANY EXISTING FIXTURE OR CONNECTION TO THE SEWER MAIN LINE MUST BE CAPPED BEFORE BUILDING DEMOLITION ACTIVITIES OCCUR.

THE NFRC TEMPROARY LABEL DISPLAYED ON WINDOWS AND SKYLIGHTS(INCL.TUBULAR)MUST REMAIN ON THE UNIT UNTIL FINAL INSPECTION HAS BEEN COMPLETED.

EXISTING NONCOMPLIANT PLUMBING FIXTURE REPLACEMENT REQUIREMENT: SENATE BILL 407 (SB 407) REQUIRES NONCOMPLIANT PLUMBING FIXTURES TO BE REPLACED BY WATERCONSERVING PLUMBING FIXTURES WHEN A PROPERTY IS UNDERGOING ALTERATIONS OR IMPROVEMENTS. THIS BILL APPLIES TO ALL SINGLE-FAMILY RESIDENTIAL AND MULTI-FAMILY RESIDENTIAL BUILDINGS CONSTRUCTED ON OR BEFORE JANUARY 1, 1994. FIXTURES INCLUDE WATER CLOSETS, URINALS, SHOWERHEADS, LAVATORY FAUCETS, AND KITCHEN FAUCETS. NONCOMPLIANT FIXTURES CAN ONLY BE REPLACED BY FIXTURES COMPLYING WITH THE REQUIREMENTS OF CALGREEN AND THE CALIFORNIA PLUMBING CODE.

THE WATER-CONSERVING PLUMBING FIXTURE CERTIFICATE OF COMPLIANCE MUST BE SUBMITTED TO THE BUILDING INSPECTOR PRIOR TO THE FINAL BUILDING INSPECTION.

NEW INSTALLATION OF GAS WATER HEATHER SHALL HAVE ALL THE FOLLOWING AS PER 2019 CALIFORNIA ENERGY CODE 150.0(n): 1. A 120V ELECTRICAL RECEPTACLE IS WITHIN 3 FEET FROM THE WATER HEATER AND ACCESSIBLE WITH NO OBSTRUCTIONS.

- 2. A CATEGORY III OR IV VENT, OR A TYPE B VENT WITH STRAIGHT PIPE BETWEEN OUTSIDE TERMINATION AND THE WATER HEATER.
- 3. A CONDENSATE DRAIN NO MORE THAN 2 INCHES HIGHER THAN THE BASE ON WATER HEATER FOR NATURAL DRAINING.
- 4. A GAS SUPPLY LINE WITH CAPACITY OF AT LEAST 200,000 BTU/HR.

NOTE:


1. UNFIRED TANKS SHALL HAVE A MINIMUM R-12 INSULATION 2. R-7.7 INSULATION SHALL BE INSTALLED ON THE FIRST 5 FEET OF HOT AND COLD WATER PIPES.

3. ALL HOT WATER PIPING 3/4" OR LARGER, FROM THE WATER HEATER TO THE KITCHEN FIXTURES, SHALL HAVE R-7.7 INSULATION.

BUILDING MAINTENANCE AND OPERATION SEC.4.410 BUILDING MANUAL: AT THE TIME OF FINAL INSPECTION, A MANUAL, COMPACT DISC,OR OTHER APPROVED MEDIA SHALL BE PLACE IN THE BUILDING THAT CONTAINS THE INFORMATION SPECIFIED IN CALGREEN SEC.4.410.

THE APPROVAL OF PLANS AND SPECIFICATION DOES NOT PERMIT THE VIOLATION OF ANY SECTION OF THE BUILDING CODE OR OTHER CITY ORDINANCE STATE LAW.

PROVIDE ON COVER SHEET IN BOLD LETTER TO CALL "DIG ALERT" PRIOR TO ANY GROUND WORK OR EXCAVATION.

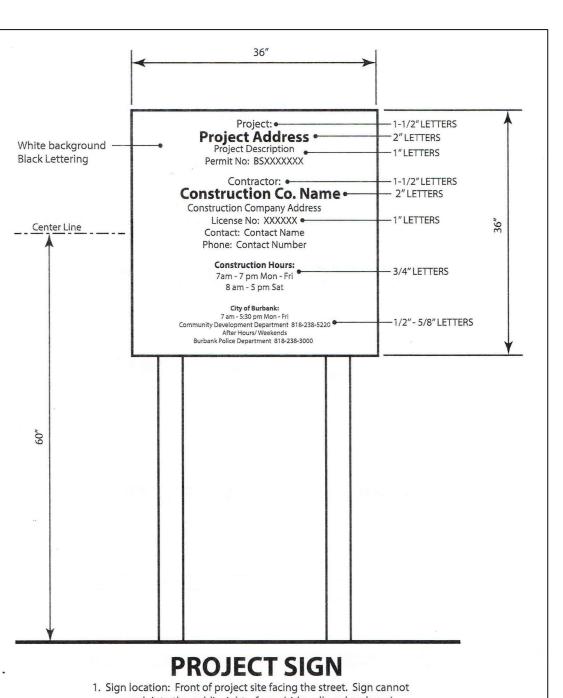


encroach into the public right-of-way (sidewalk and parkway). 2. Sign may be mounted independently or on the construction fence.

PROJECT #: PLOT DATE: 11/5/24 DRAWN BY: CHECKED BY:

0 BURBANI

DR ANYON

SUNS ∞ $\overline{}$ 0

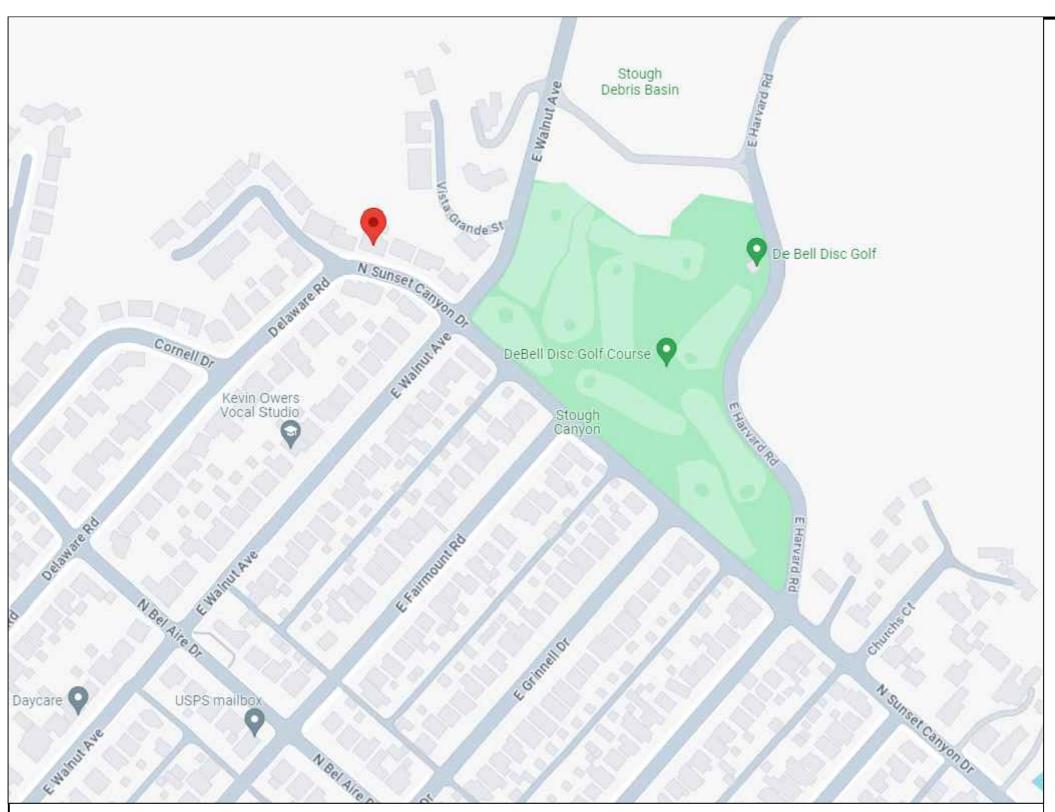

SCOPE OF WORK:

(E) HOUSE REMODELING WITH CHANGING OF CEILING HEIGHT AND

(N) ADDITION AND ADDING A (N) PATIO

LEGAL DESCRIPTION:

SITE ADDRESS:	1018 N SUNSET CANYON DR, BURBANK CA 91504
ACCESSOR PARCEL No. (APN):	2470-009-006
TRACT:	16976
LOT:	78
ZONING:	R-1
CONSTRUCTION TYPE:	TYPE V E

OWNER INFORMATION: KAMILLA KHUDYAKOVA

PROPERTY INFORMATION

NUMBER OF EXISTING BEDROOMS: 4

NUMBER OF EXISTING BATHROOMS: 4

PROPOSED OCCUPANCY USE: R-3


21'-0"

EXISTING OCCUPANCY USE:

BUILDING HEIGHT:

STORY:

ARCHITECT INFORMATION: MAN	VEL VARDANYAN		
		SHEET	INDEX:
AREA INFORMATION)N:	A-1	COVER SHEET
LOT AREA	15,870.0 SQ.FT.	A-2	SITE PLAN
EXISTING HOUSE AREA	2,310.0 SQ.FT.	A-2.1	AVERAGE FRONT CALC. & AVERAGE LOT WIDTH CALC.
EXISTING GARAGE	527.0 SQ.FT.	A-3	EXISTING 1ST FLOOR PLAN
EXISTING PATIO	363.0 SQ.FT.	A-4	EXISTING GARAGE & 2ND FLOOR PLAN
		A-5	EXISTING ROOF PLAN
FLOOR AREA RATIO (LOT (A-6	EXISTING ELEVATION
LOT SIZE 15,870.0 SQ/FT EXISTING HOUSE 2,310.0 S.I	LOT COVERAGE TOTAL 2,310+152+124.71+35+381+527+363=3,892.71	A-7	EXISTING ELEVATION
EXISTING GARAGE 527.0 S.I	2,510+152+124.71+55+561+527+565=5,692.71 3,892.71 S.F. / 15,870 S.F. =%24	A-8	DEMO PLAN
EXISTING PATIO 363.0 S.I (N) 2ND STORY ADDITION (REC. ROOM) 381.0 S.I	- 	A-9	PROPOSED PLANS
(N) 1ST FLOOR ADDITION 152.0 S.I	_	A-10	KEYNOTES
(N) FRONT COVERED PORCH 124.71 S. NEW REAR ADDITION, 35.0 S.	- 	A-11	PROPOSED ROOF PLAN
FAR		A-12	PROPOSED SECTIONS
7500x0.4=3000		A-13	PROPOSED ELEVATIONS
		A-14	PROPOSED ELEVATIONS
[101/AL=0,727 3.1./0,002./1 3.1.]			

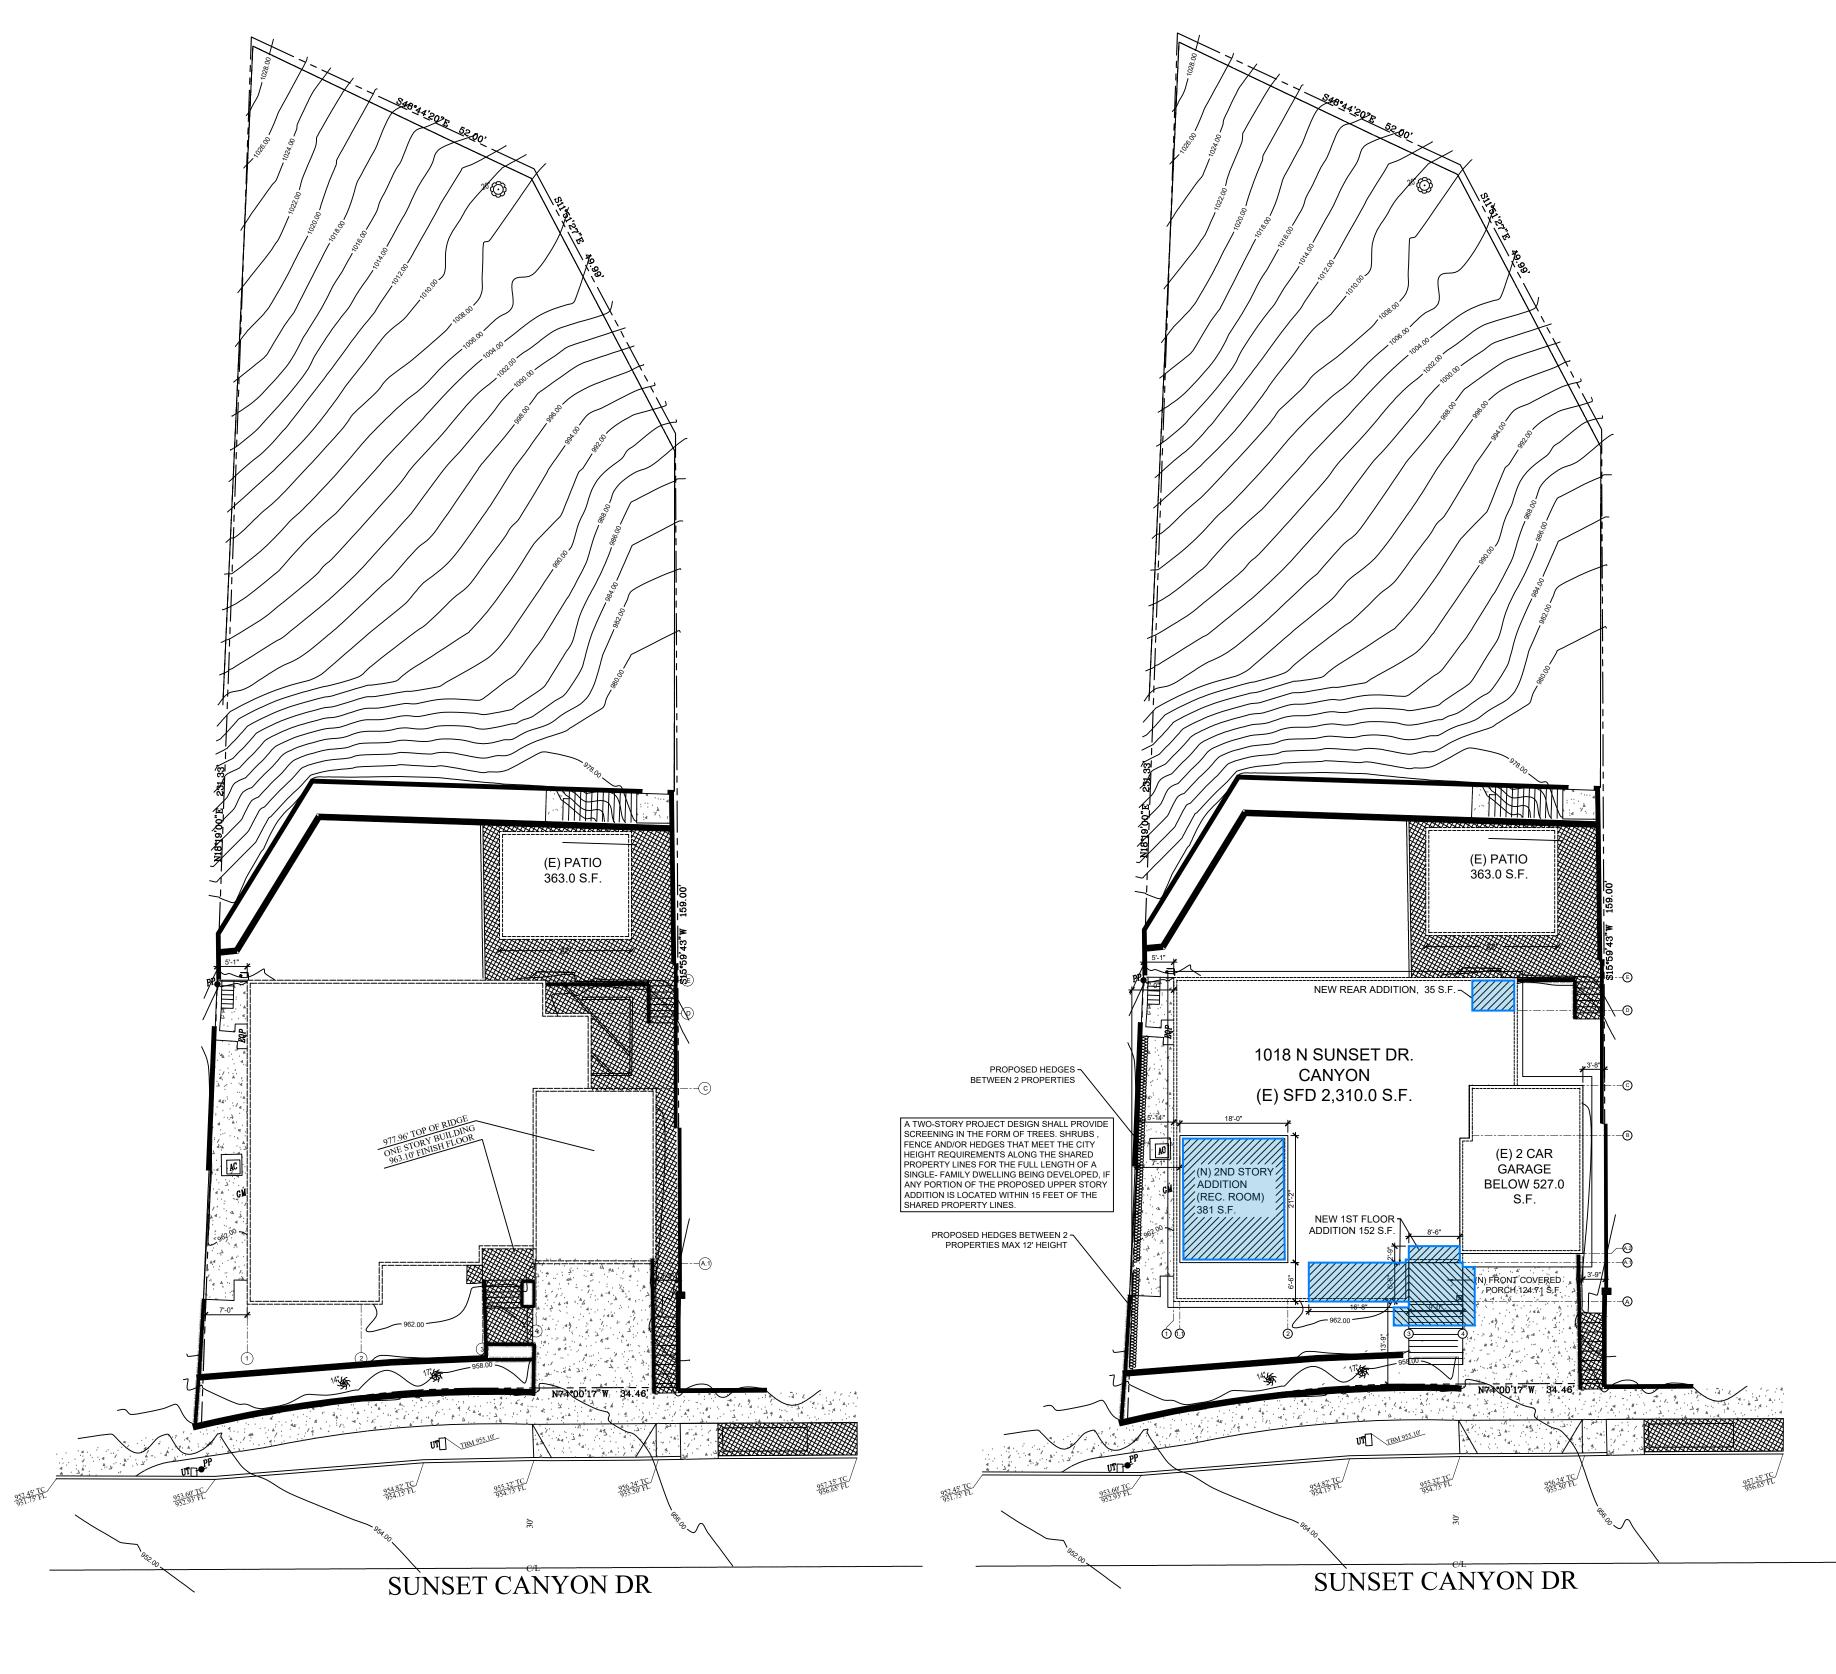

EXISTING FLOOR PLAN SCALE: 1/16"=1'-0"

PROPOSED FLOOR PLAN SCALE: 1/16"=1'-0"

STAMP:

PROJECT #: PLOT DATE: DRAWN BY:

91504

BURBAN

DR,

CANYON


SUNSE_


Z

018

Khudyakova

Kamilla

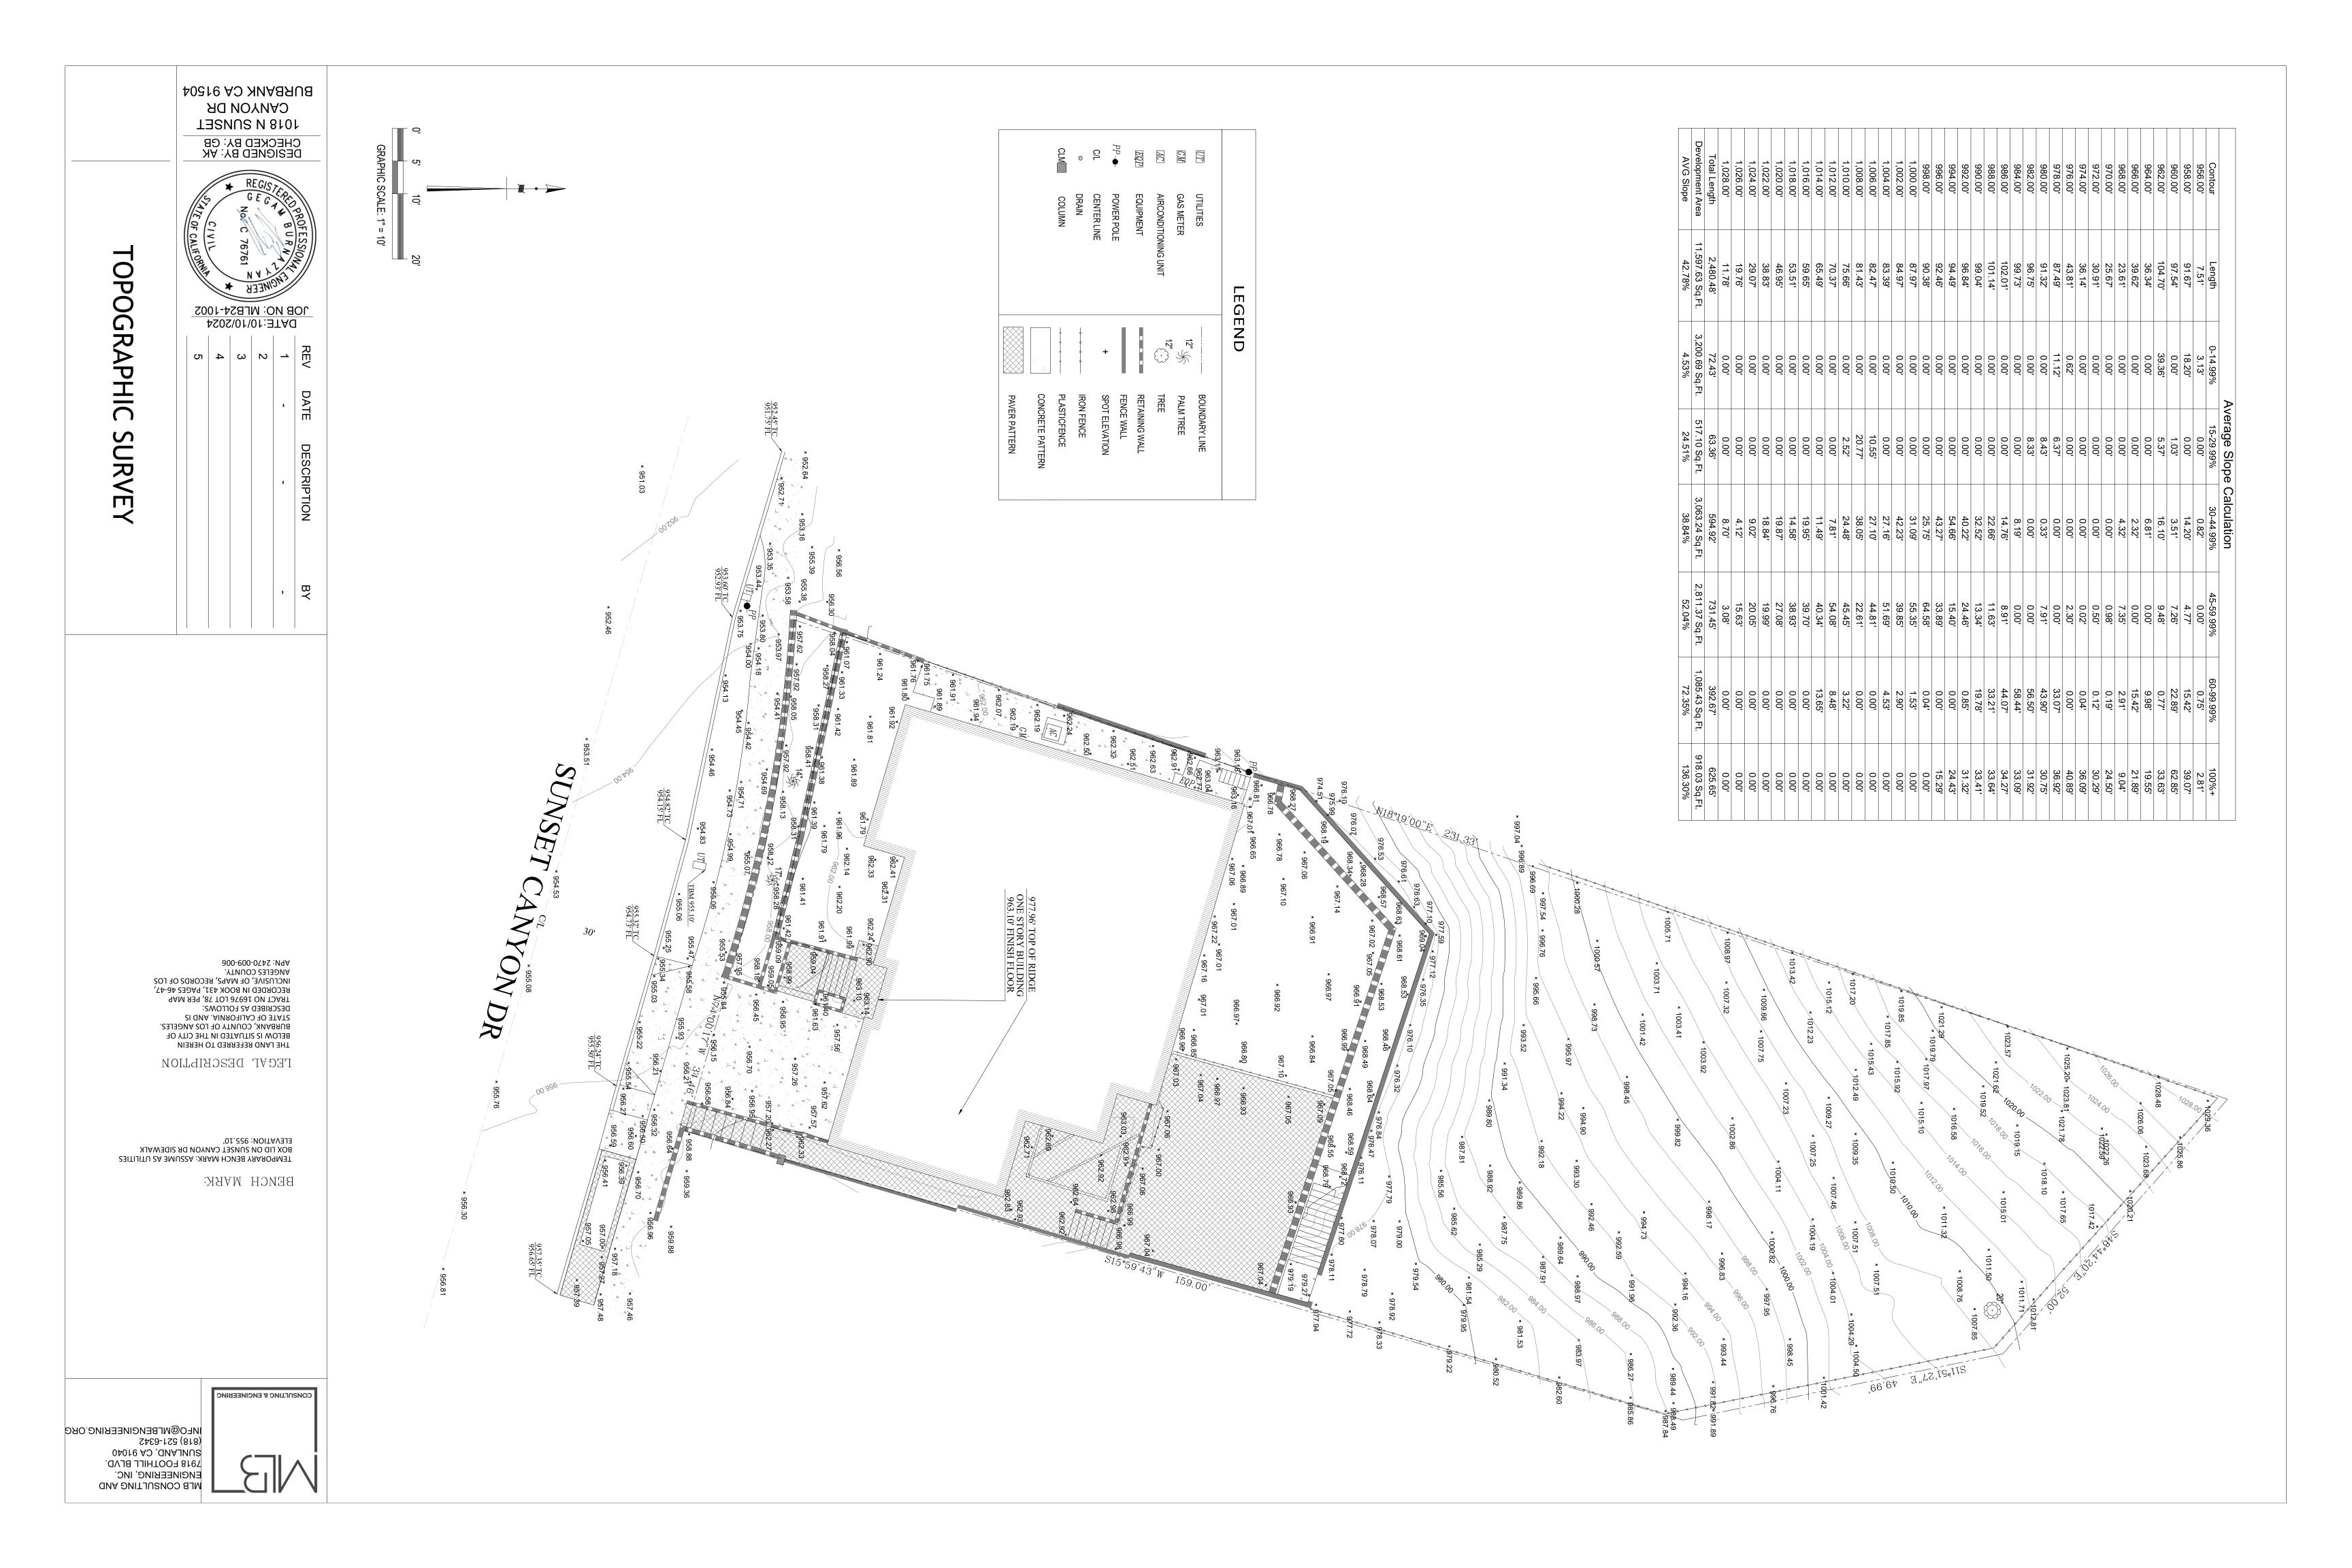


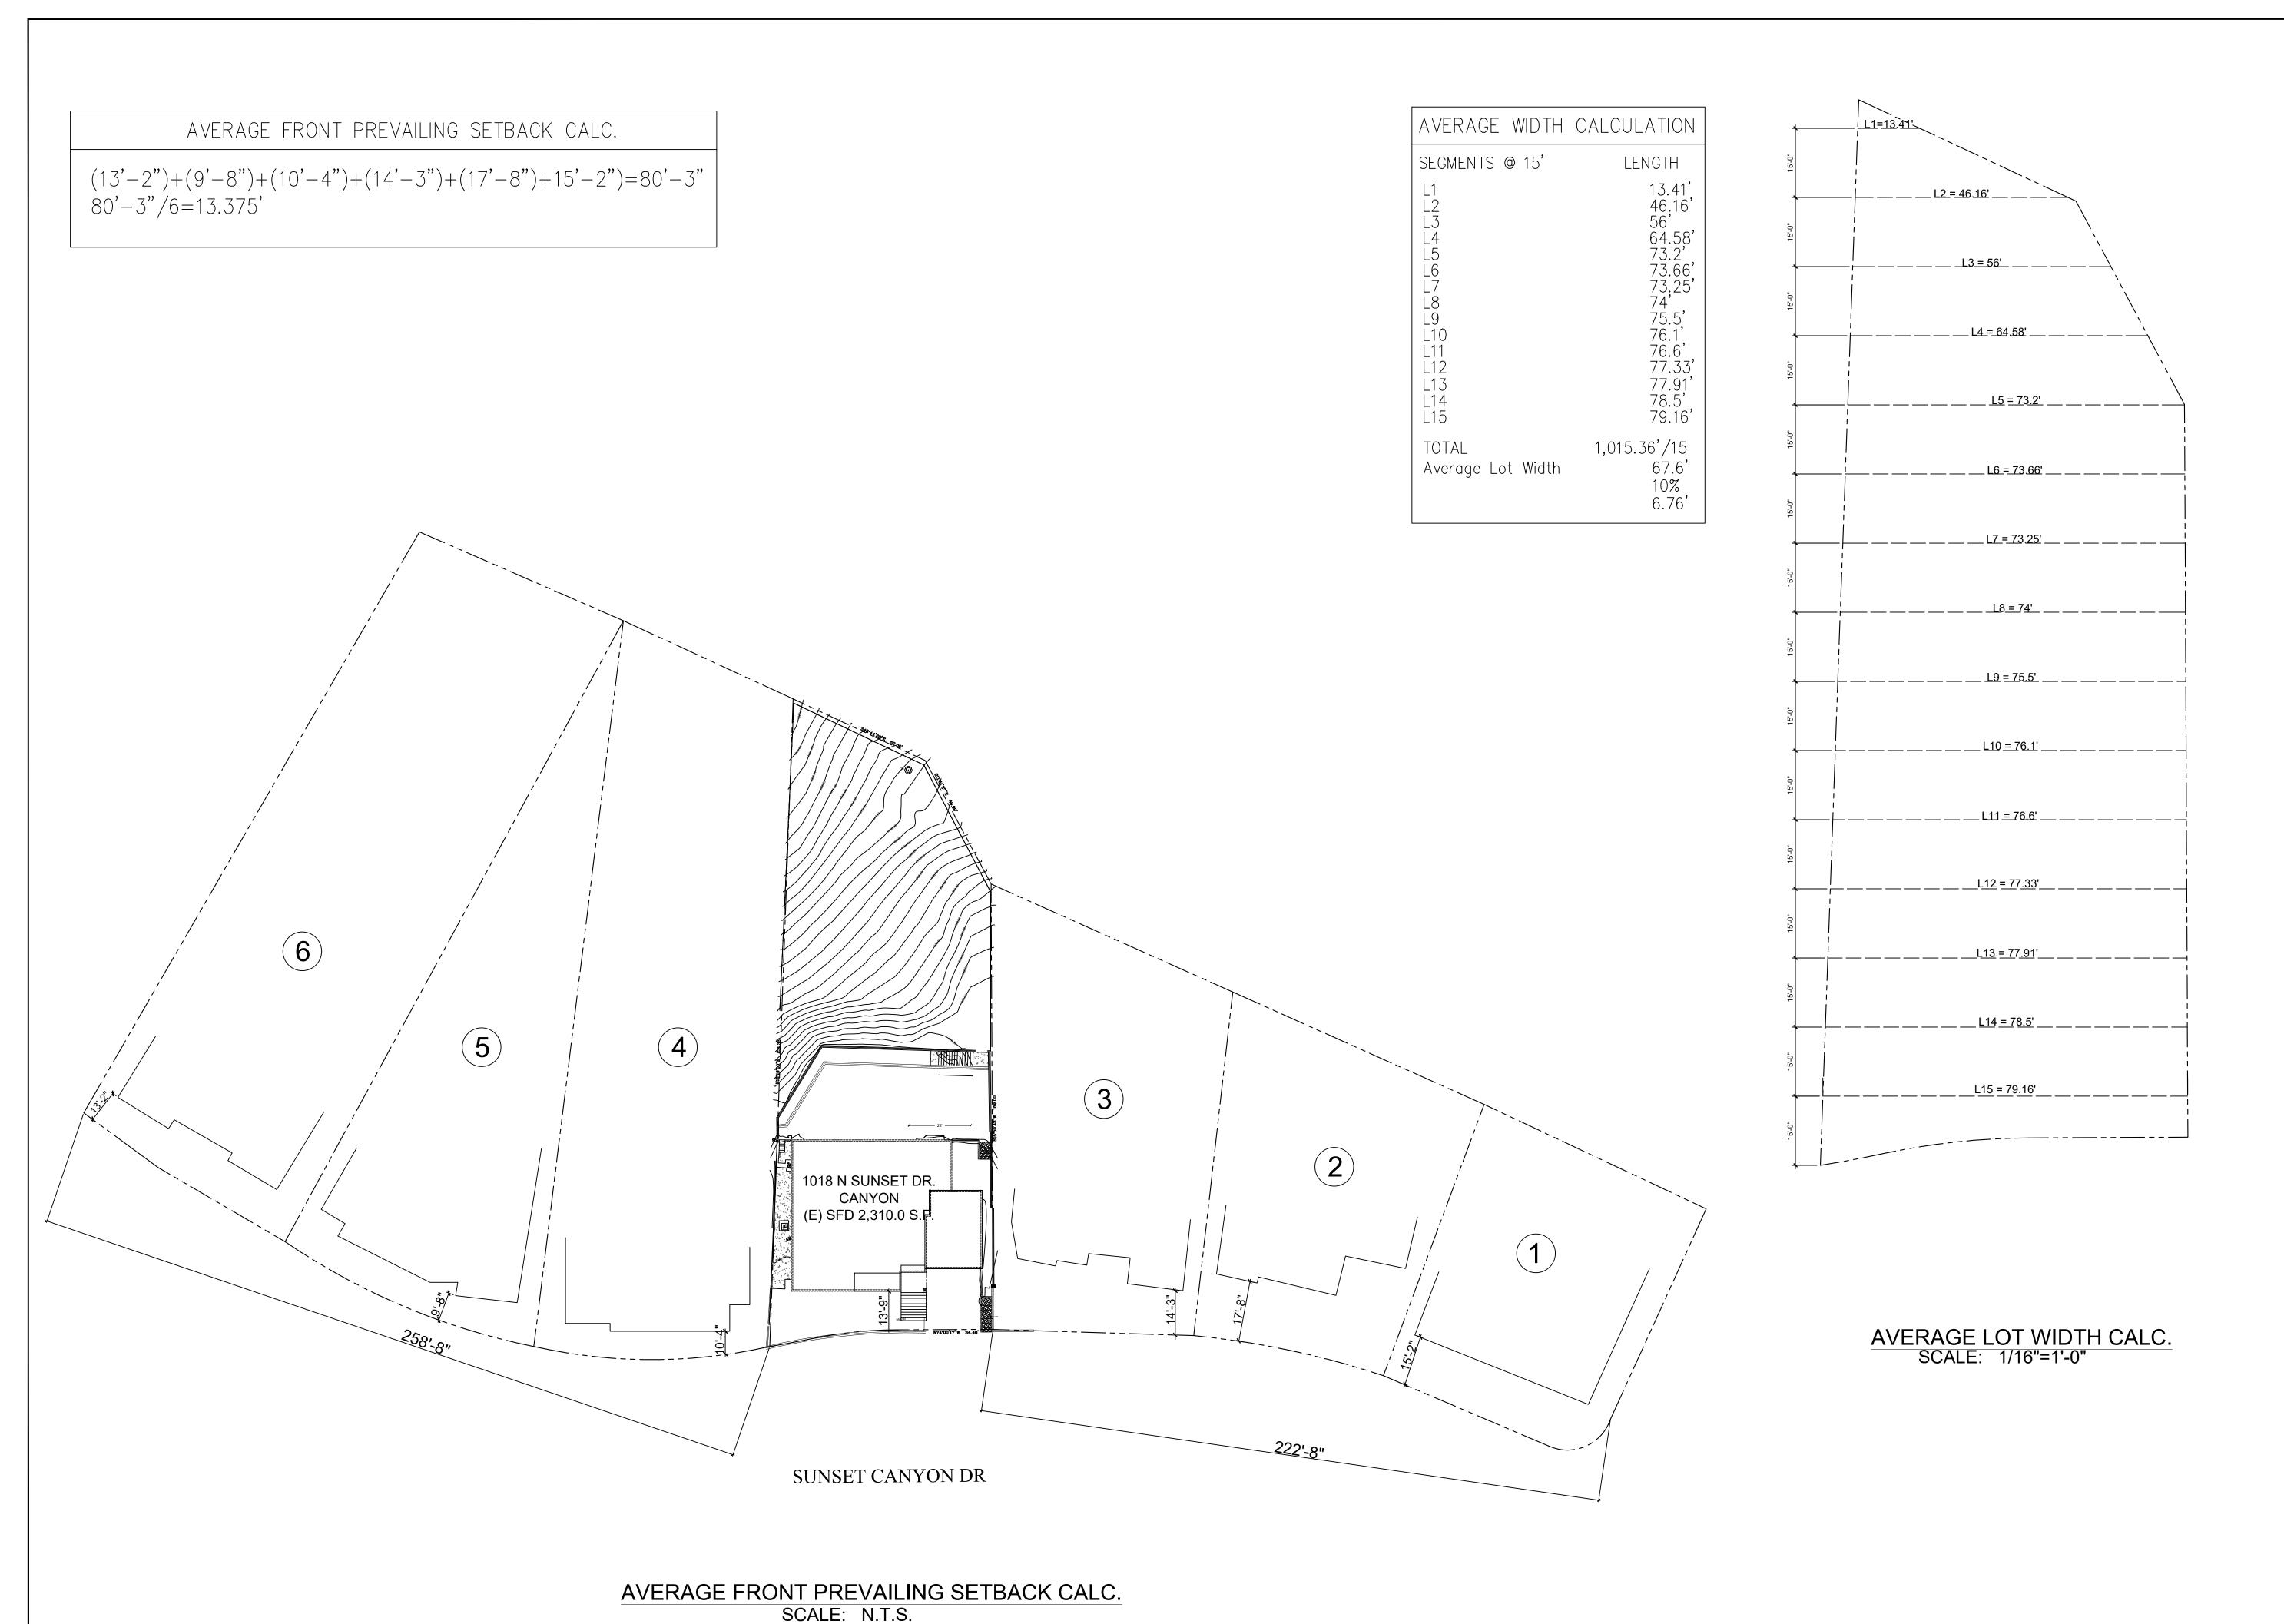

PROJECT #: PLOT DATE: DRAWN BY: 91504 BURBANK CANYON DR, 1018

SHEE

A-2.

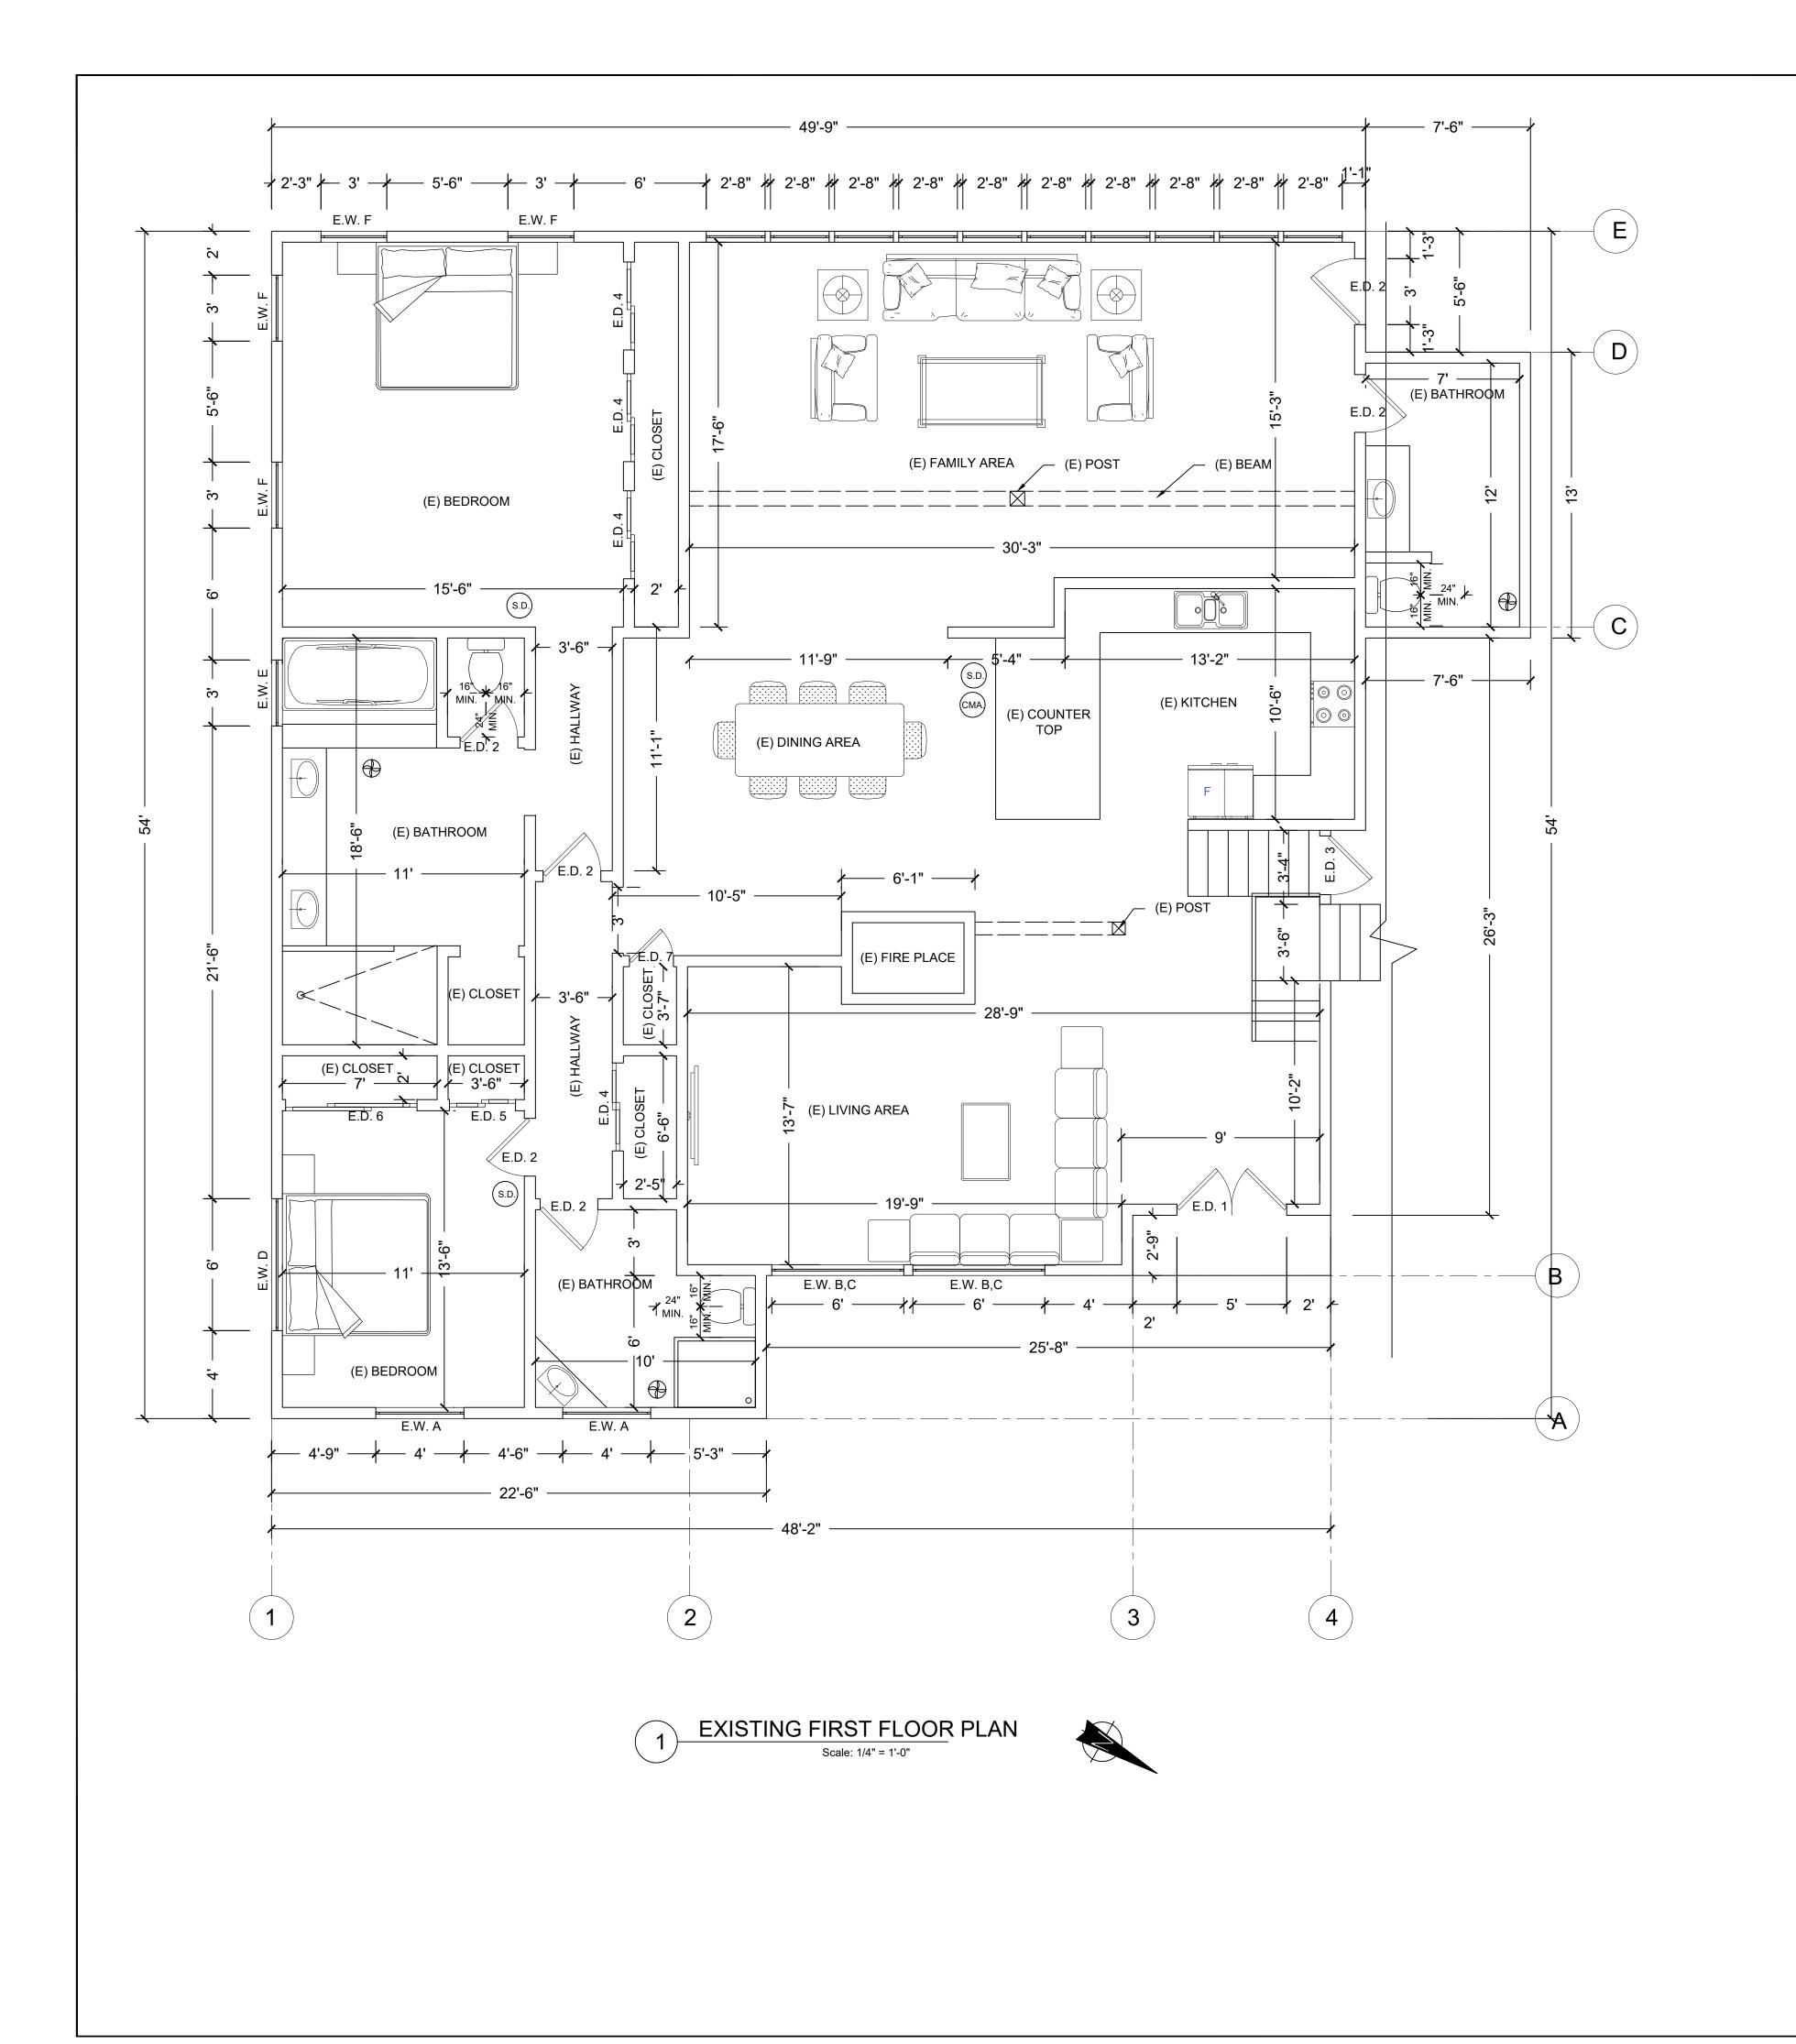

FLOOR PLAN KEYNOTES:

SMOKE DETECTORS SHALL BE PROVIDED AS FOLLOWS: 120v HARD-WIRED SMOKE ALARMS WITH BATTERY BACK-UP SHALL BE INSTALLED IN ALL OF THE FOLLOWING LOCATIONS: EACH BEDROOM, OC CEILING OR WALL OUTSIDE OF EACH SEPARATE BEDROOM, AND EACH STORY, INCLUDING BASEMENTS (NEW CONSTRUCTION). WHERE MORE THAN ONE SMOKE ALARM IS REQUIRED TO BE INSTALLED WITHIN AN INDIVIDUAL DWELLING OR SLEEPING UNIT, THE SMOKE ALARM SHALL BE INTERCONNECTED IN SUCH A MANNER THAT THE ACTIVATION OF ONE WILL ACTIVATE ALL THE ALARMS IN THE INDIVIDUAL UNIT. THE ALARM SHALL BE CLEARLY AUDIBLE IN ALL BEDROOMS OVER BACKGROUND NOISE LEVELS WITH ALL INTERVENING DOORS CLOSED. (CRC R314.1)

AN APPROVED CARBON MONOXIDE DETECTOR RECEIVING ITS PRIMARY SOURCE OF POWER FROM THE BUILDING WIRING AND HAVING BATTERY BAK-UP SHALL BE INSTALLED OUTSIDE OF EACH SEPARATE SLEEPING AREA OR BEDROOMS AND ONE ON EVERY LEVEL OF THE DWELLING INCLUDING BASEMENTS. WHERE MORE THAN ONE ALARM IS REQUIRED TO BE INSTALLED WITHIN AN INDIVIDUAL DWELLING OR SLEEPING UNIT, THE ALARMS SHALL BE INTERCONNECTED IN SUCH A MANNER THAT THE ACTIVATION OF ONE WILL ACTIVATE ALL THE ALARMS IN THE INDIVIDUAL UNIT. THE ALARM IS PERMITTED TO BE SOLELY BATTERY OPERATED WHERE THE WORK DOES NOT RESULT IN THE REMOVAL OF WALL AND CEILING FINISHES, OR IS NO ACCESS THROUGH AN ATTIC, BASEMENT OR CRAWL SPACE.(CRC R315.1)

50 CFM INTERMITTENT VENTILATION BATHROOM EXHAUST FANS SHALL BE ENERGY STAR COMPLIANT AND BE DUCTED TO TERMINATE TO THE OUTSIDE OF THE BUILDING FANS, NOT FUNCTIONING AS A COMPONENT OF A WHOLE HOUSE VENTILATION SYSTEM, MUST BE CONTROLLED BY A HUMIDITY CONTROL. 4.506.1

001 | ALL WATER CLOSET SHALL USE NO MORE THAN 1.28 GALLONS PER FLUSH.

HOT-MOP SHOWER PAN WITH CERAMIC TILE WAINSCOT UP TO CEILING, (SEE FLOOR PLAN FOR SIZE OF SHOWER). PROVIDE SHATTERROOF GLASS ENCLOSURE. PROVIDE SOAP DISH ÁT TUB AND SHOWER,

003 ALL SHOWERS AND TUB-SHOWERS SHALL HAVE EITHER A PRESSURE BALANCE OR THERMOSTATIC MIXING VALVE.

(004) PROVIDE 72" HIGH NON-ABSORBENT WALL FINISH ADJACENT TO SHOWER.

005 | MINIMUM DIMENSION OF SHOWER TO BE 1024 SQ. INCH WITH 30" DIAMETER CLEAR. 006 PROVIDE TEMPERED GLASS ON DOORS AND ENCLOSURE FOR HOT TUB, BATHTUB, SHOWERS

(ALSO GLAZING $\,\,$ IN WALL ENCLOSING THESE COMPARTMENTS WITHIN $\,\,$ 5'-0" OF STANDING SURFACE). 007 2X6 STUDS AT 16" O.C.PLUMBING WALL.

009 PROVIDE SOUND INSULATION AT ALL BATHROOM & LAUNDRY ROOM WALLS.

010 GAS TANKLESS WATER HEATER (TAKAGI T-H3-OS-N)

GLAZING IN EXTERIOR DOORS OR 40 INCHES OF ANY LOCKING MECHANISM SHALL BE OF FULLY TEMPERED GLASS. OR RATED BURGLARY RESISTANT GLAZING.

012 | A. MINIMUM OF 22"x30" ATTIC ACCESS AT 30" MIN. CLEAR HEADROOM.

013 R-4 INSULATION SHALL BE INSTALLED ON THE FIRST 5 FEET OF HOT AND COLD WATER PIPES.

014 (E)WATER HEATER

015 (E) HVAC UNIT IN THE ROOF

O16 | A MINIMUM 4 MUISTOIL EATTHOUGH TO 14' WITH TWO 90% ELBOWS. A MINIMUM 4" MOISTURE EXHAUST DUCT MUST BE PROVIDED

A FLEXIBLE DUCT CANNOT EXTEND MORE THAN 6'-0" AND CANNOT BE CONCEALED.

017 NEW WASHER AND DRYER

018 | NEW COUNTER W/ CABINETS ABV.

NEW REFRIGERATOR BY OWNER 020 NEW SINK BY OWNER

NEW STOVE BY OWNER

022 NEW DISHWASHER BY OWNER

NEW FULL HEIGHT CABINETS

(E)ELECTRIC METER

WASHER/DRYER SPACE. ROUGH-IN PLUMBING FOR HOT/COLD WATER & WASTE. VENT DRYER TO OUTSIDE AIR, PROVIDE 120V & 220V ELEC. OUTLET AND FUEL GAS OUTLET.

12"x12" MINIMUM PLUMBING ACCESS FOR TUBS.

__ _ _ (E) WALLS TO BE DEMO

1" MAX. DROP. THE LANDING OR FINISHED FLOORS SHALL NOT BE MORE THAN 1 1/2" LOWER THAN THE TOP OF THRESHOLD EXCEPT THE LANDING OR FLOOR ON THE EXTERIOR SIDE SHALL NOT BE MORE THAN 73" BELOW THE TOP OF THRESHOLD PROVIDED THE DOOR DOES NOT SWING OVER THE LANDING OF FLOOR

WALL LEGEND: (N) STUD WALLS (E) WALLS TO REMAIN GENERAL LEGEND:

(E) = EXISTING ELEMENT

(N) = NEW ELEMENT

EXISTING DOOR SCHEDULE							
TAG	DESCRIPTION	WIDTH	HEIGHT				
E.D. 1	DOUBLE EXTERIOR	2-2'-6"	6'-8"				
E.D. 2	SINGLE INTERIOR	2'-8"	6'-8"				
E.D. 3	SINGLE INTERIOR 20 MIN FIRE RATED	2'-8"	6'-8"				
E.D. 4	DOUBLE SLIDING	2-2'-0"	6'-8"				
E.D. 5	DOUBLE SLIDING	2-1'-6"	6'-8"				
E.D. 6	DOUBLE SLIDING	2-3'-0"	6'-8"				
E.D. 7	SINGLE INTERIOR	2'-0"	6'-8"				
E.D. 8	GARAGE GATE	16'-0"	7'-0"				
E.D. 9	SINGLE EXTERIOR	3'-0"	6'-8"				

EXISTING WINDOW SCHEDULE							
TAG	DESCRIPTION	WIDTH	HEIGHT				
E.W. A	SINGLE HUNG	4'-0"	4'-0"				
E.W. B	DOUBLE SLIDING	6'-0"	4'-0"				
E.W. C	DOUBLE SLIDING	6'-0"	1'-6"				
E.W. D	DOUBLE SLIDING	6'-0"	2'-0"				
E.W. E	DOUBLE SLIDING	3'-0"	2'-0"				
E.W. F	DOUBLE SLIDING	3'-0"	3'-0"				
E.W. G	SINGLE HUNG	3'-6"	2'-6"				
E.W. H	SINGLE HUNG	4'-0"	4'-0"				
E.W. I	DOUBLE SLIDING	6'-0"	3'-0"				
E.W. J	DOUBLE SLIDING	3'-0"	1'-6"				
E.W. K	DOUBLE SLIDING	2'-0"	3'-0"				


ARCHISET INCORPORATION
Areg Vardanyan
ADD.: 200 W Gleonaks Blvd Suite 104
Glendale, CA 91202
Tel.: (818)-210 8894
E-mail info.archiset@gmail.com

PROJECT #: PLOT DATE: 11/5/24 DRAWN BY: CHECKED BY:

ALL IDEAS, ARRANGEMENTS AND DESIGN CONCEPTS ARE PROPRIETARY TO ARCHISET INC. AND SHALL NOT BE USED OR REPRODUCED IN PART OR IN WHOLE WITHOUT THE EXPRESS PERMISSION IN WRITING BY ARCHISET INCORPORATION

O BURBAN Khudyakova DR Kamilla

018

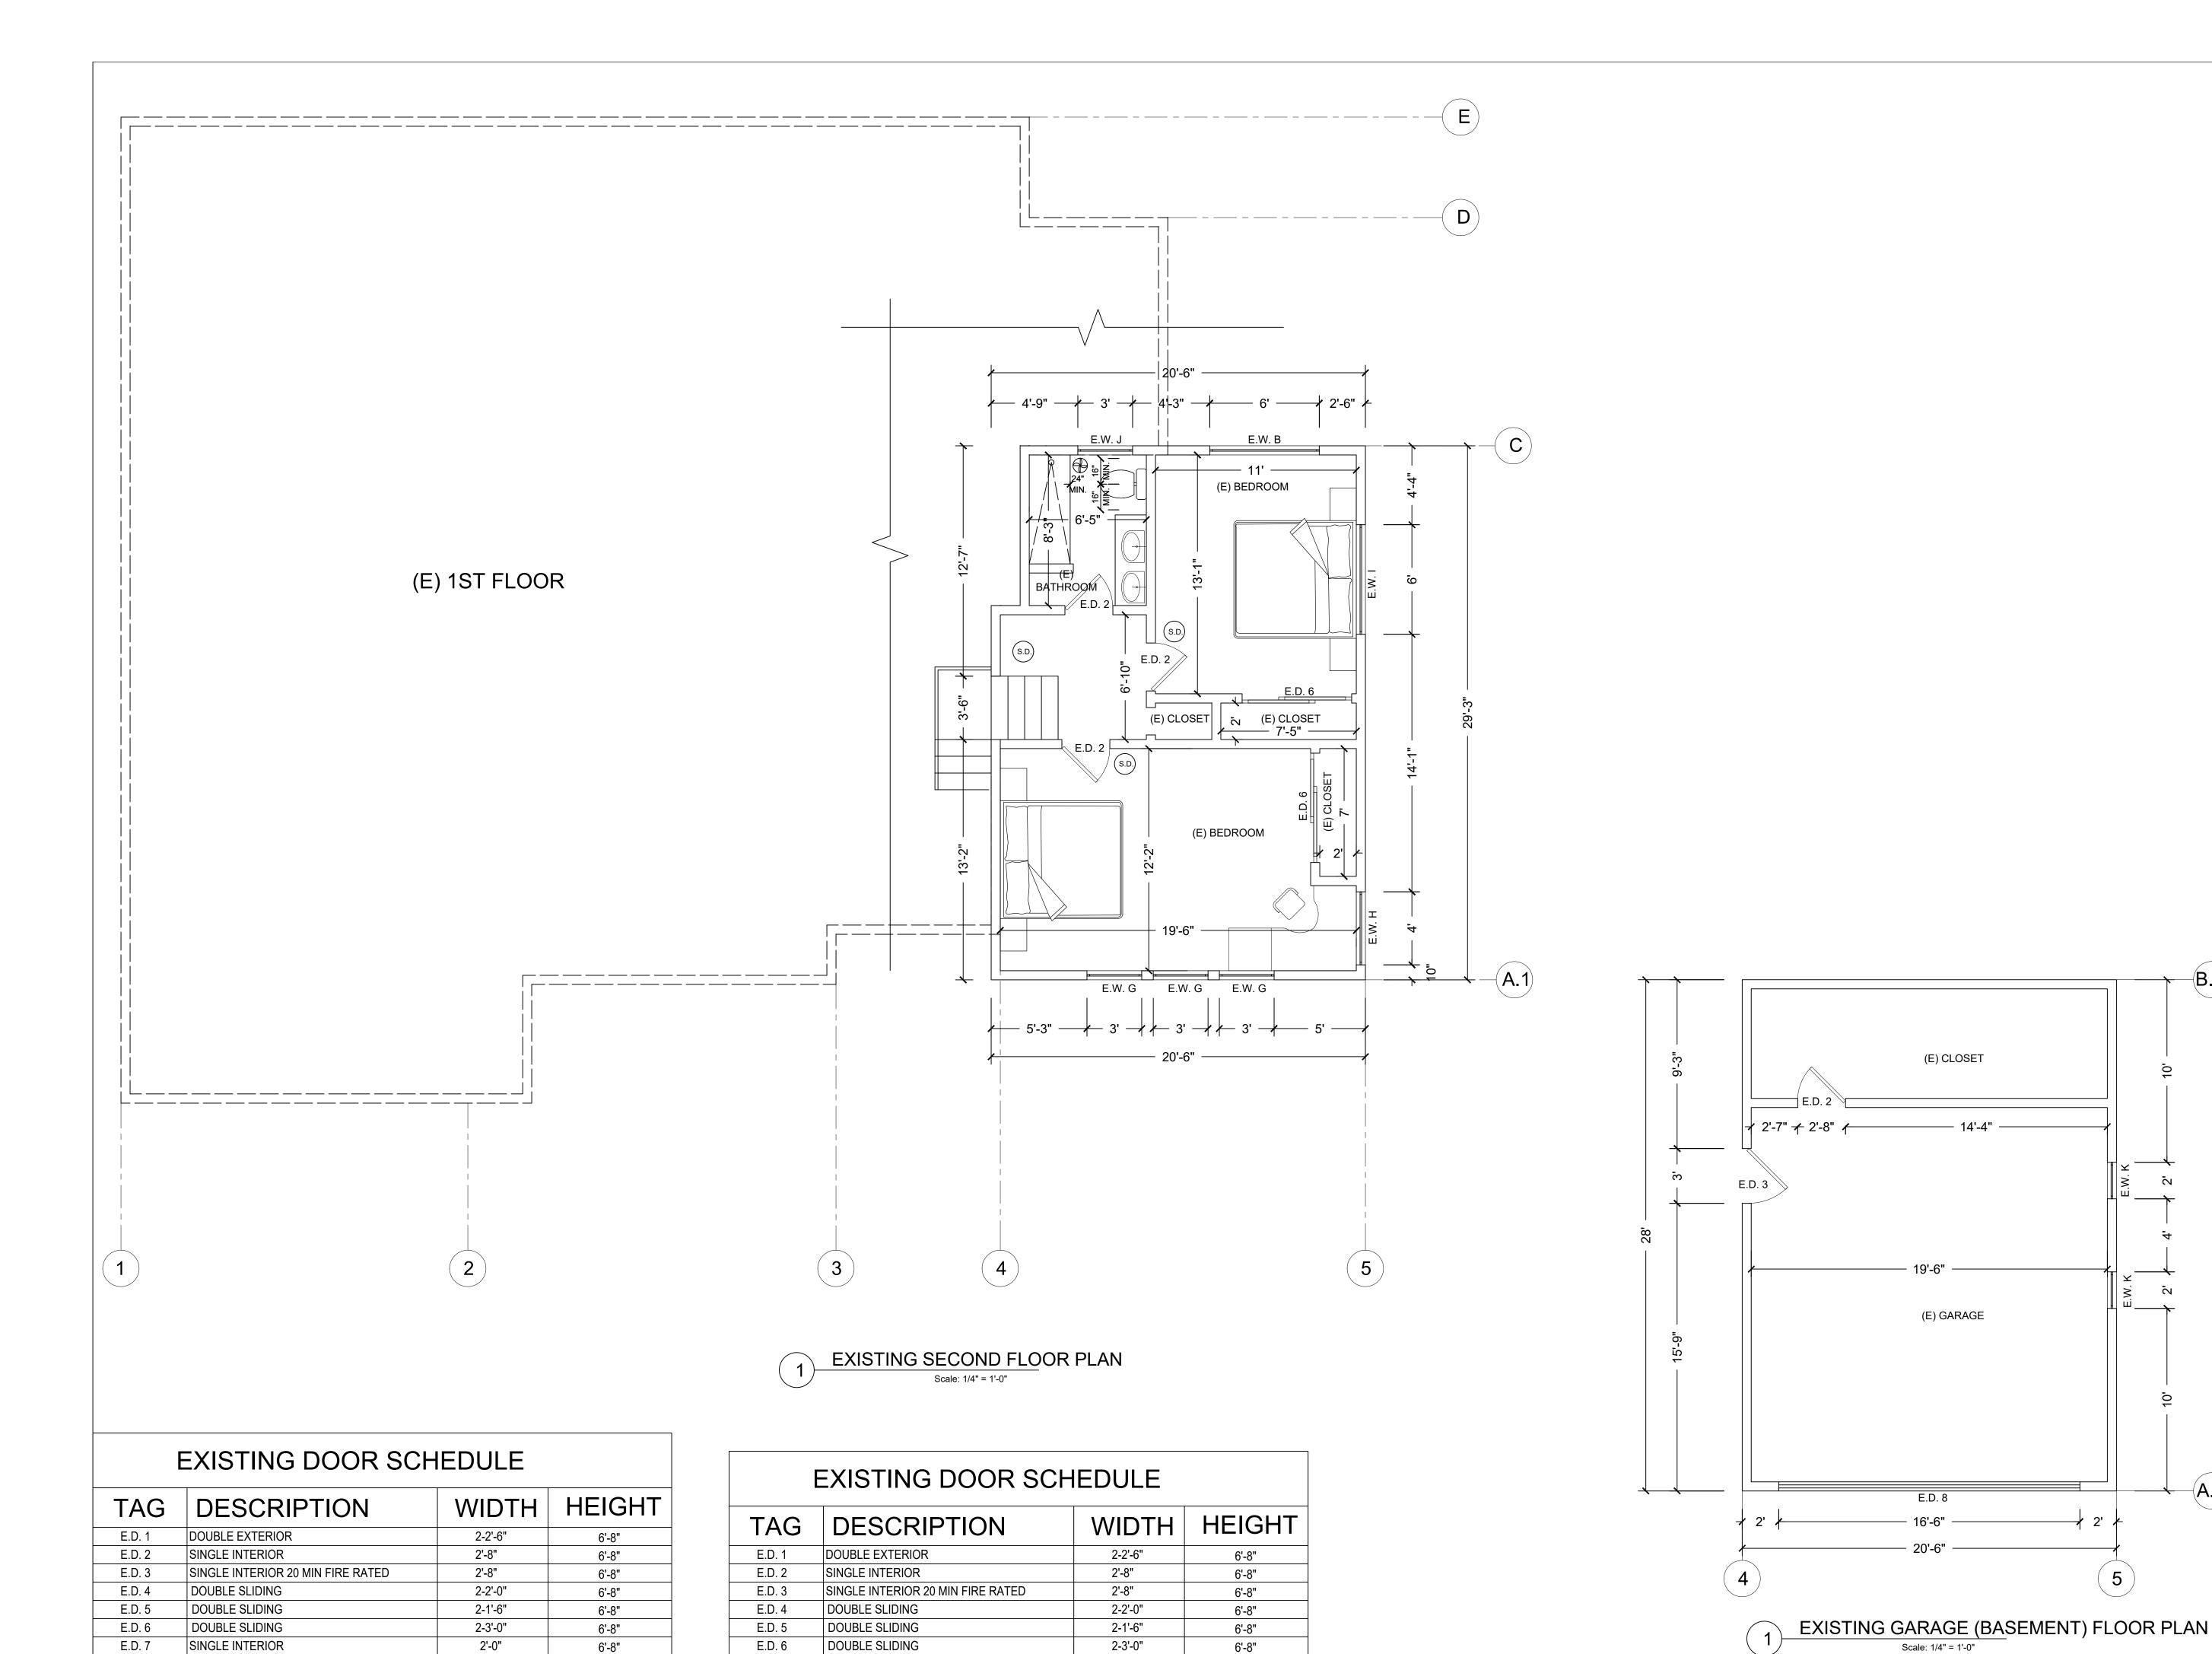

GARAGE GATE

SINGLE EXTERIOR

16'-0"

7'-0"

SINGLE INTERIOR

GARAGE GATE


2'-0"

16'-0"

6'-8"

7'-0"

PROJECT #: PLOT DATE: 11/5/24 DRAWN BY: CHECKED BY: 91 Khudyakova DR, 1018

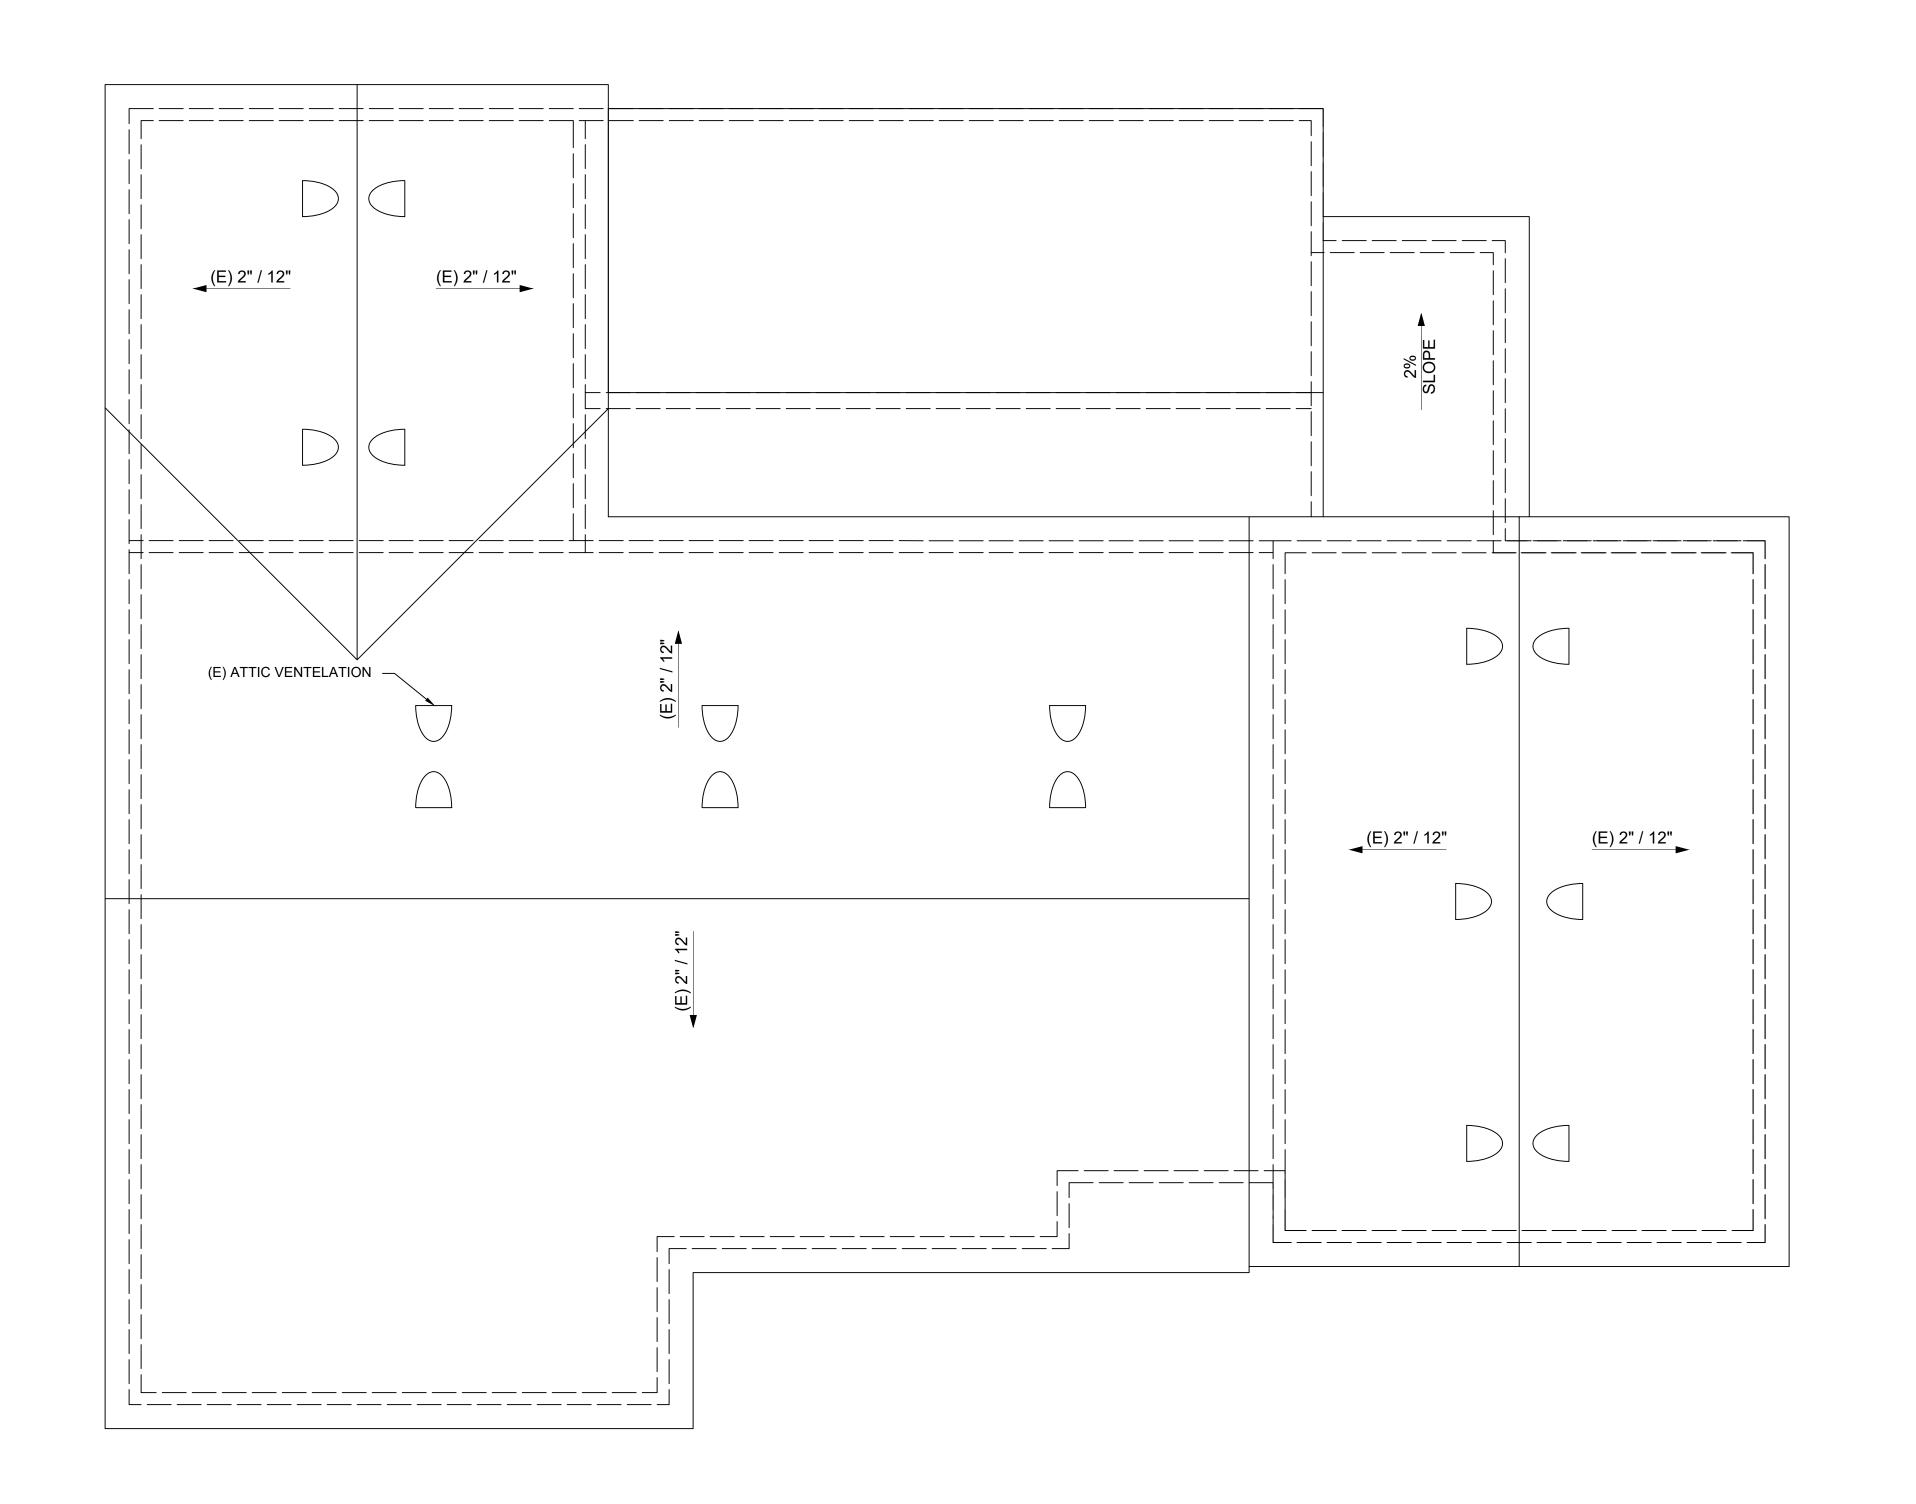

DRAWN BY: CHECKED BY: 91504 BURBANK Khudyakova CANYON DR, Kamilla 1018


PROJECT #:


PLOT DATE:


24-10


11/5/24

1 EXISTING ROOF PLAN
Scale: 1/4" = 1'-0"

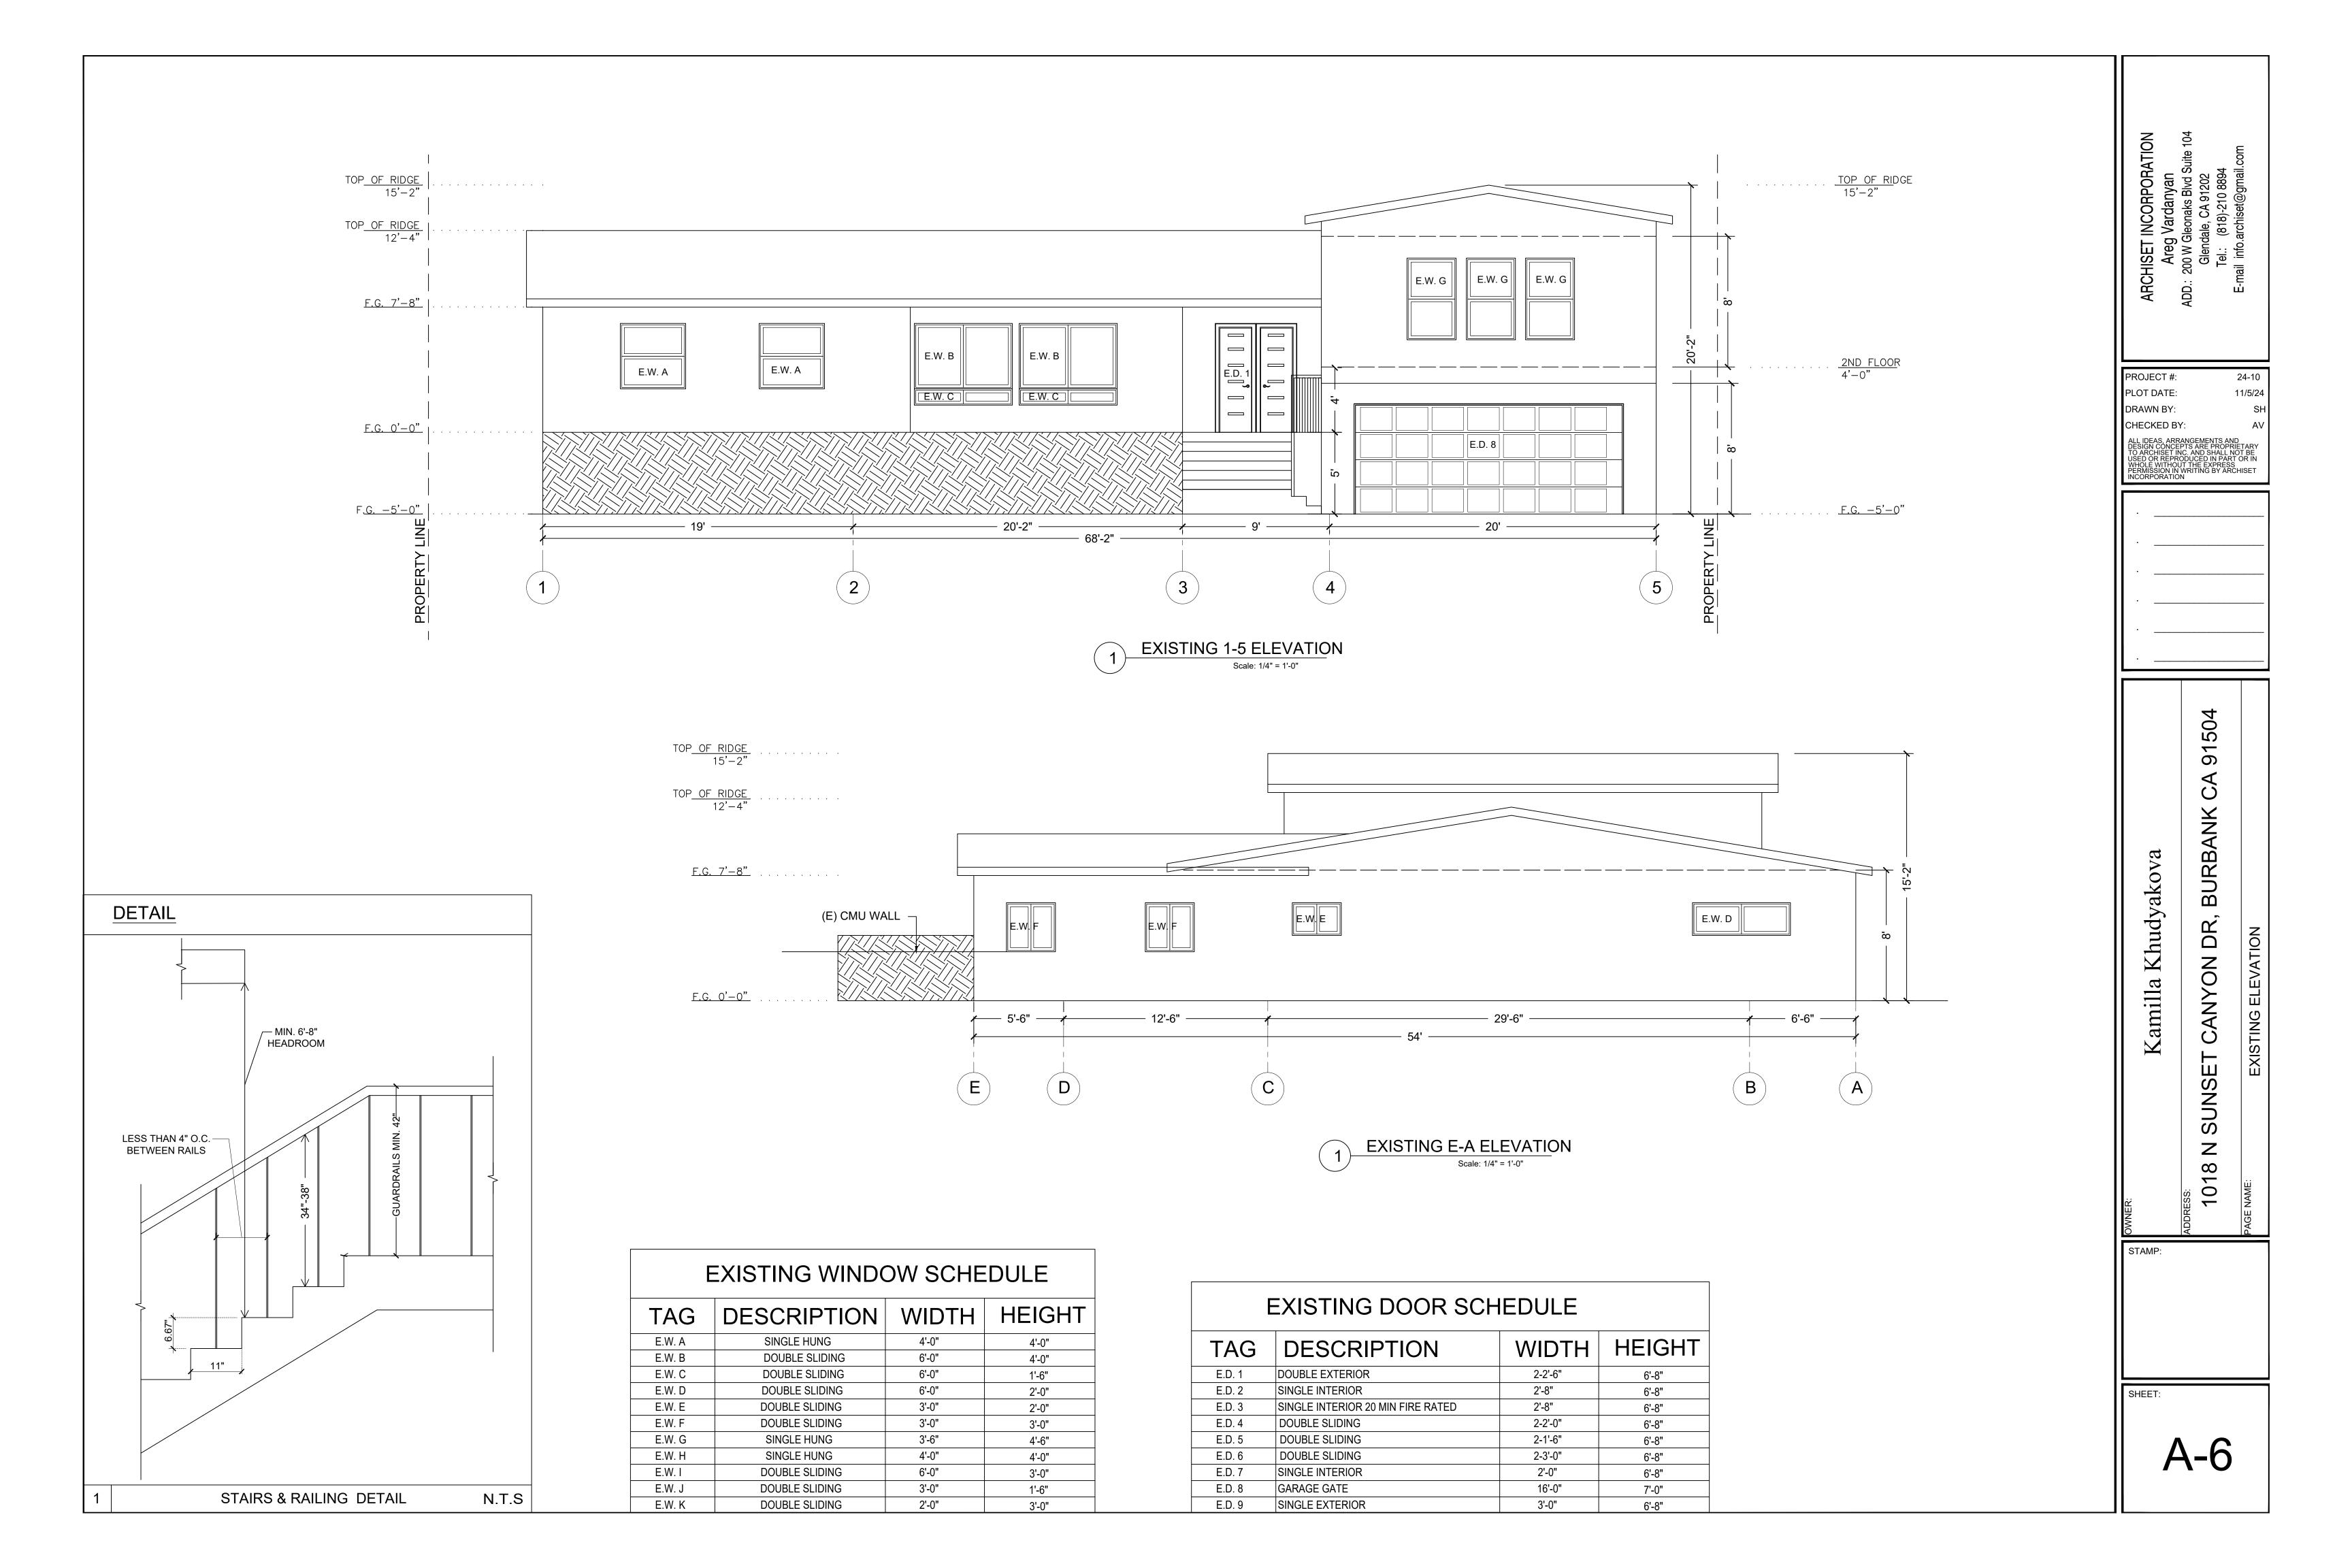

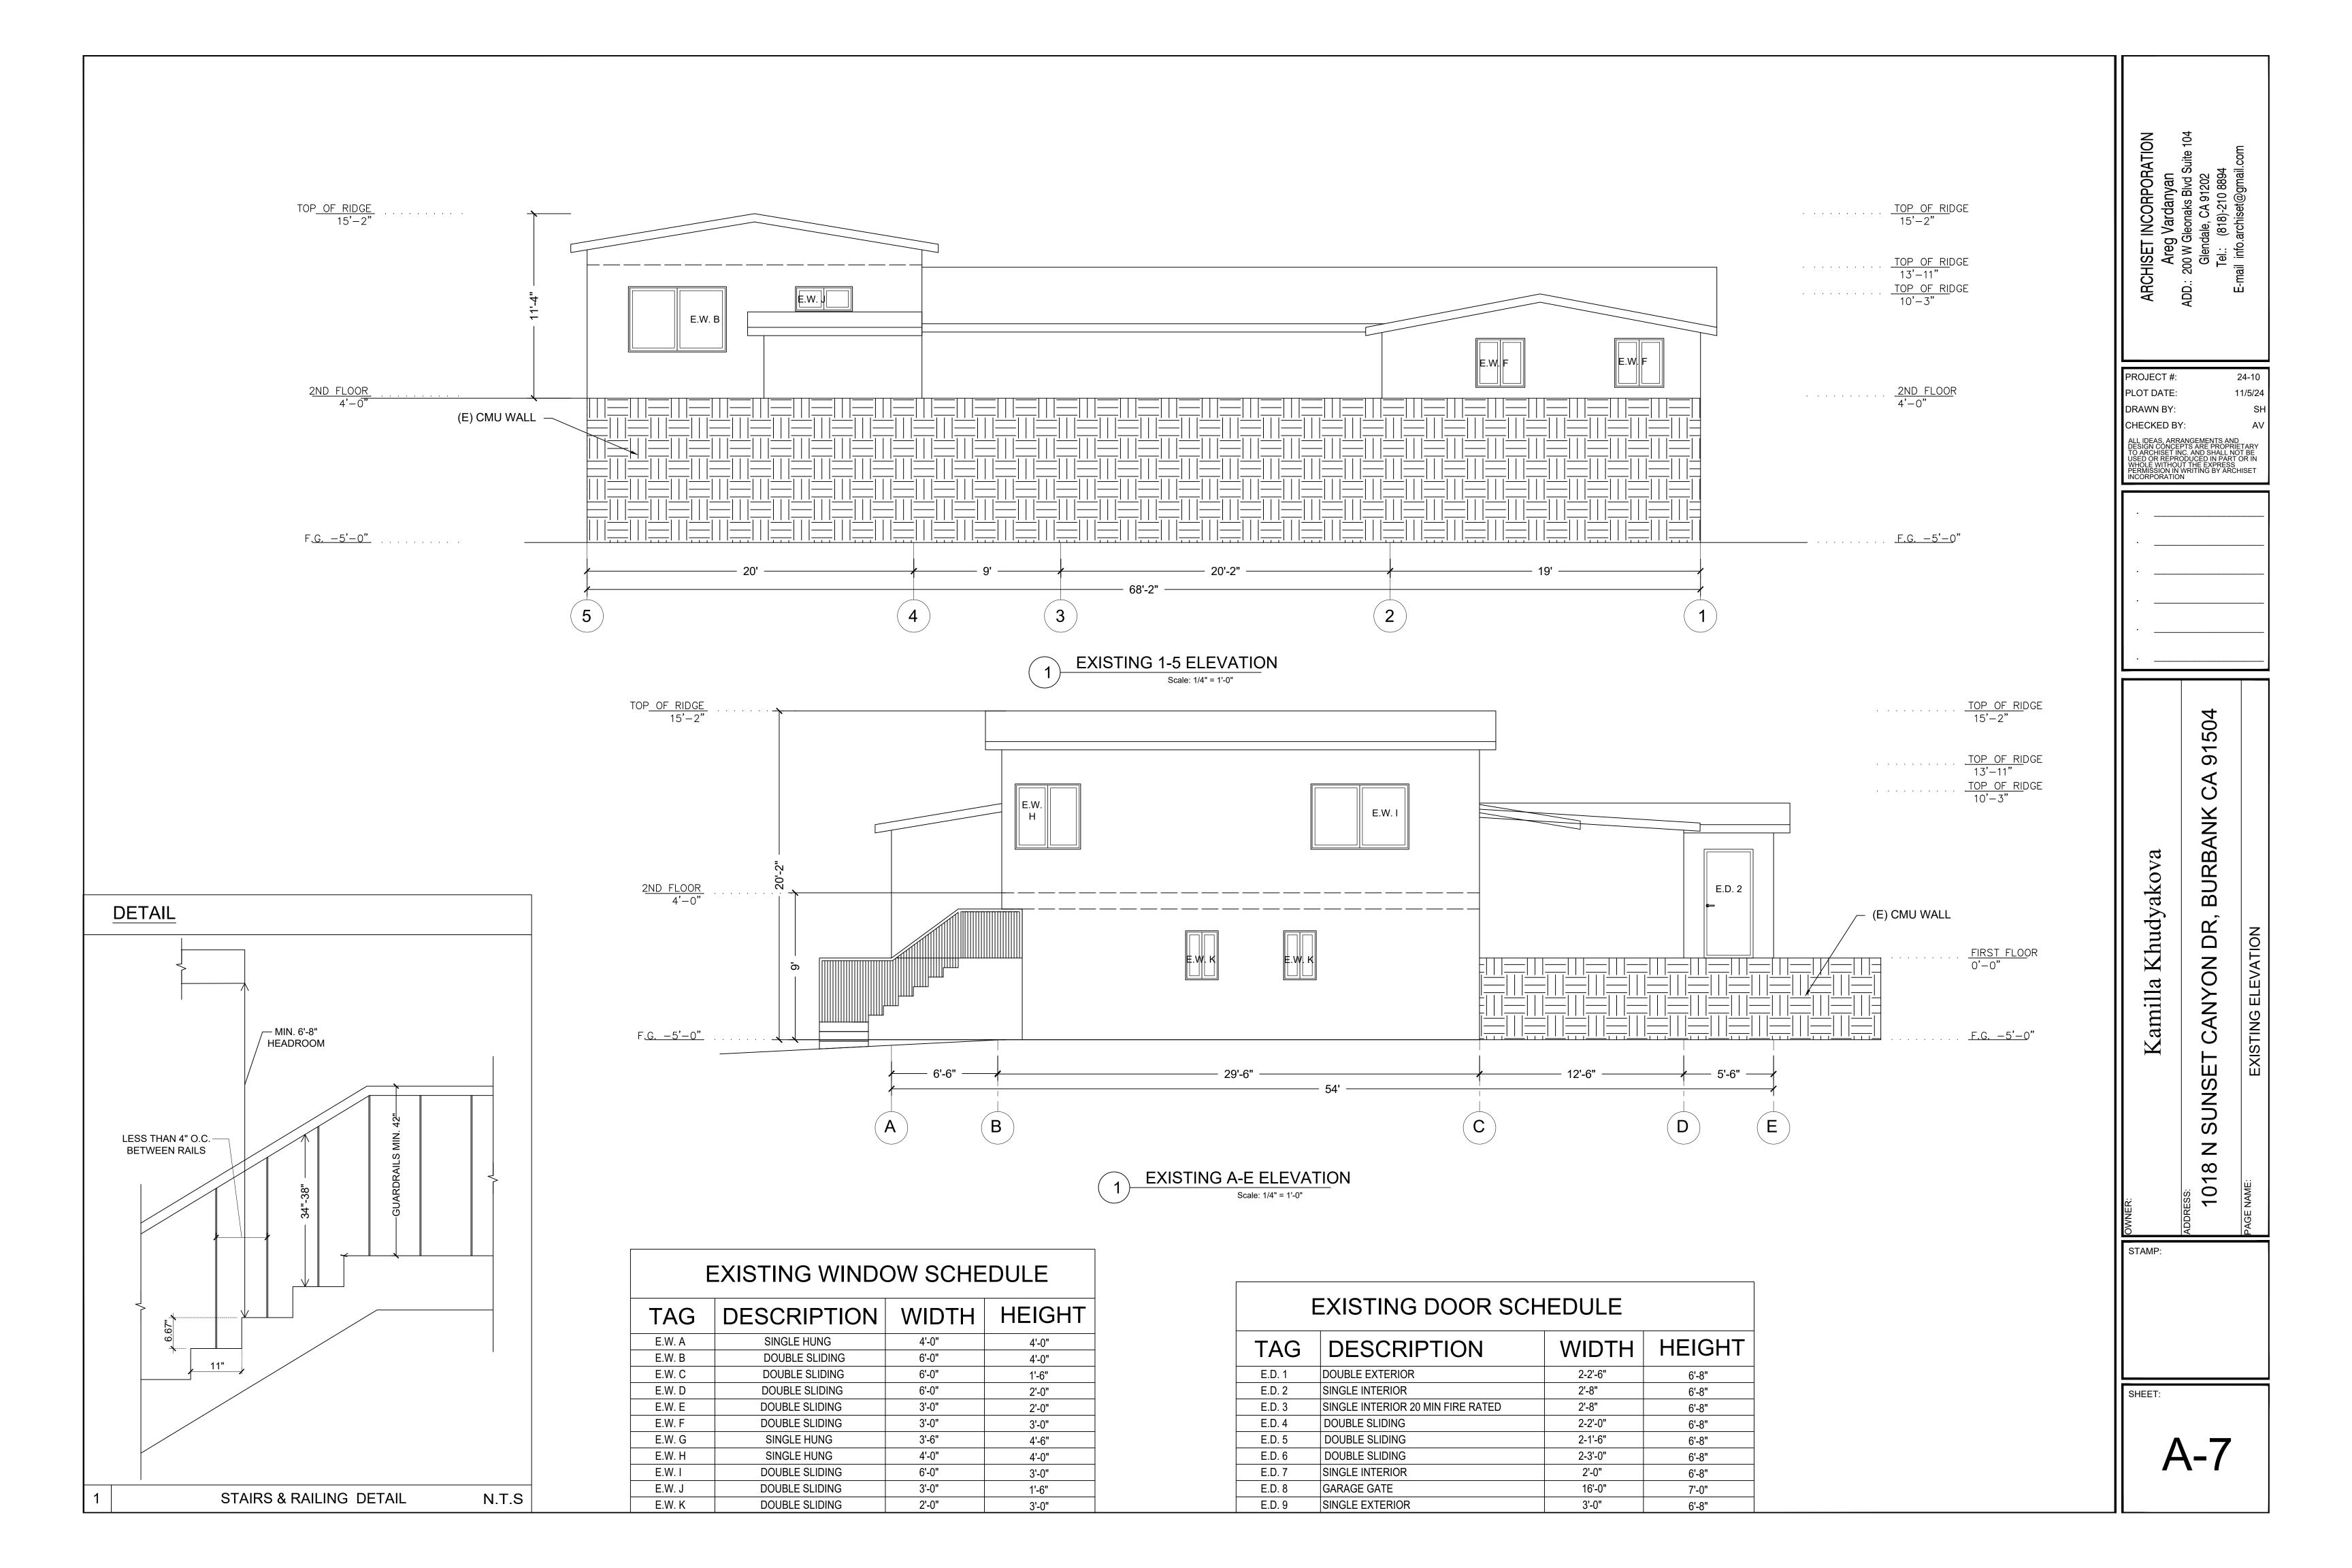

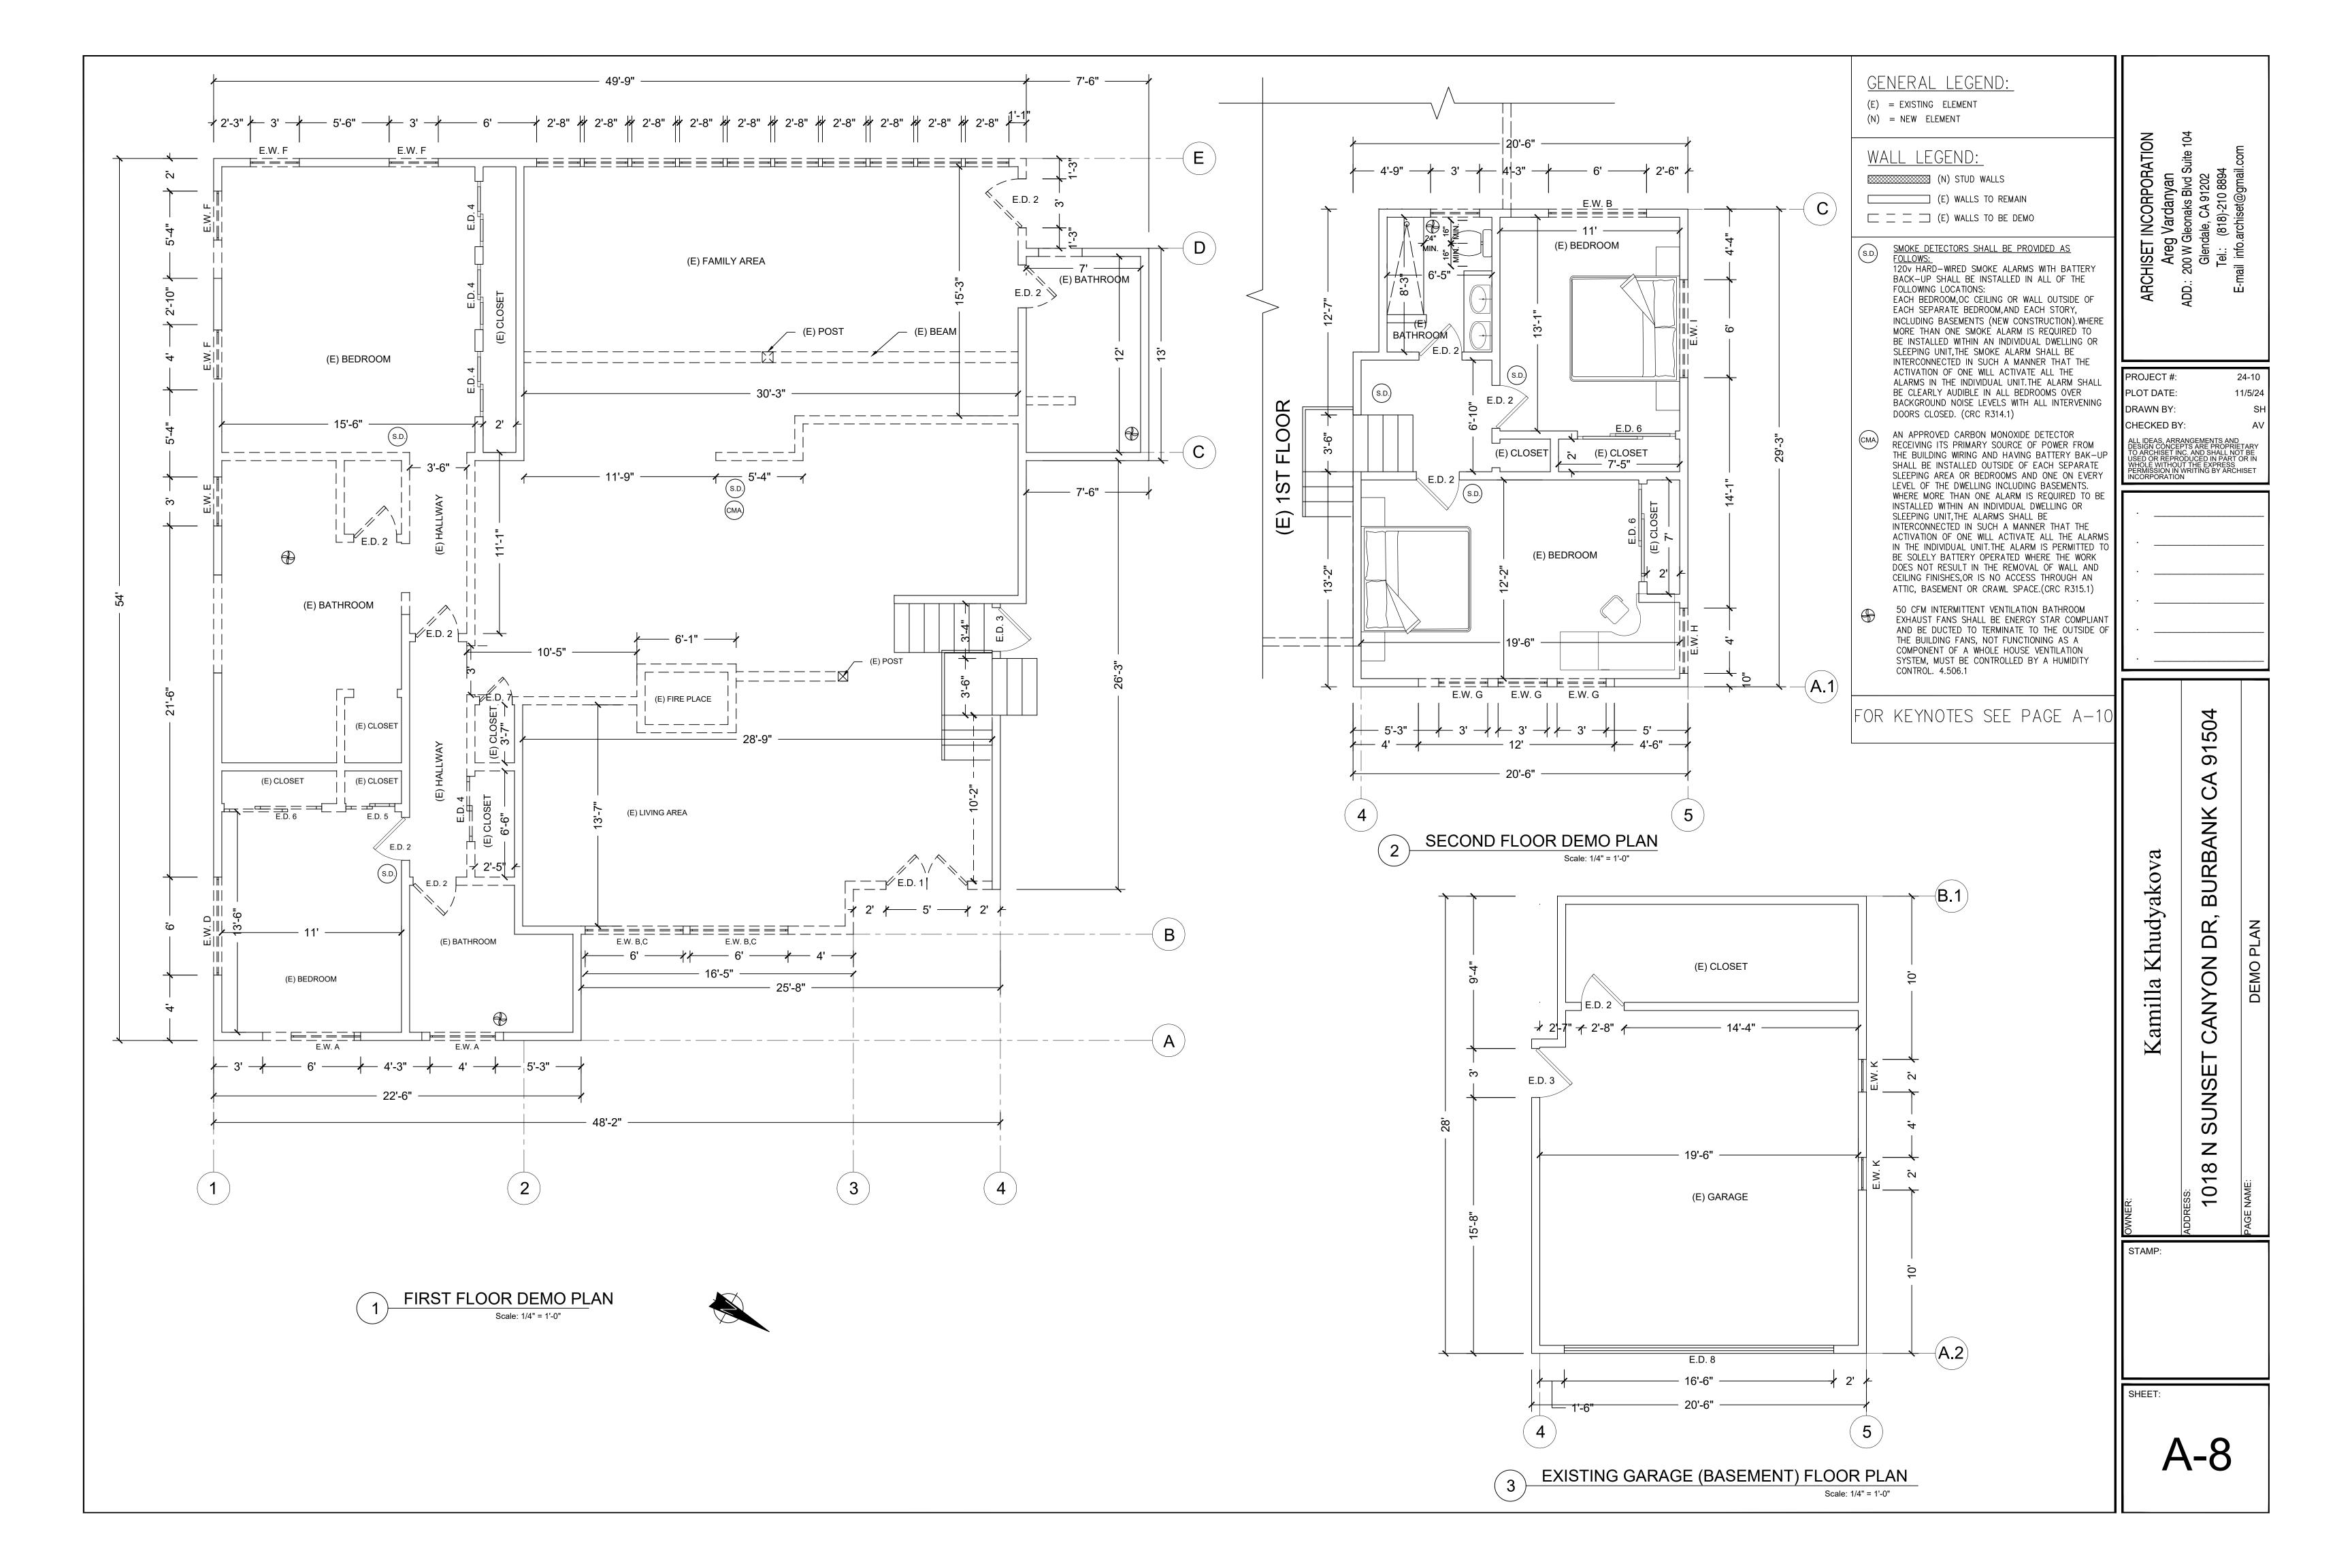

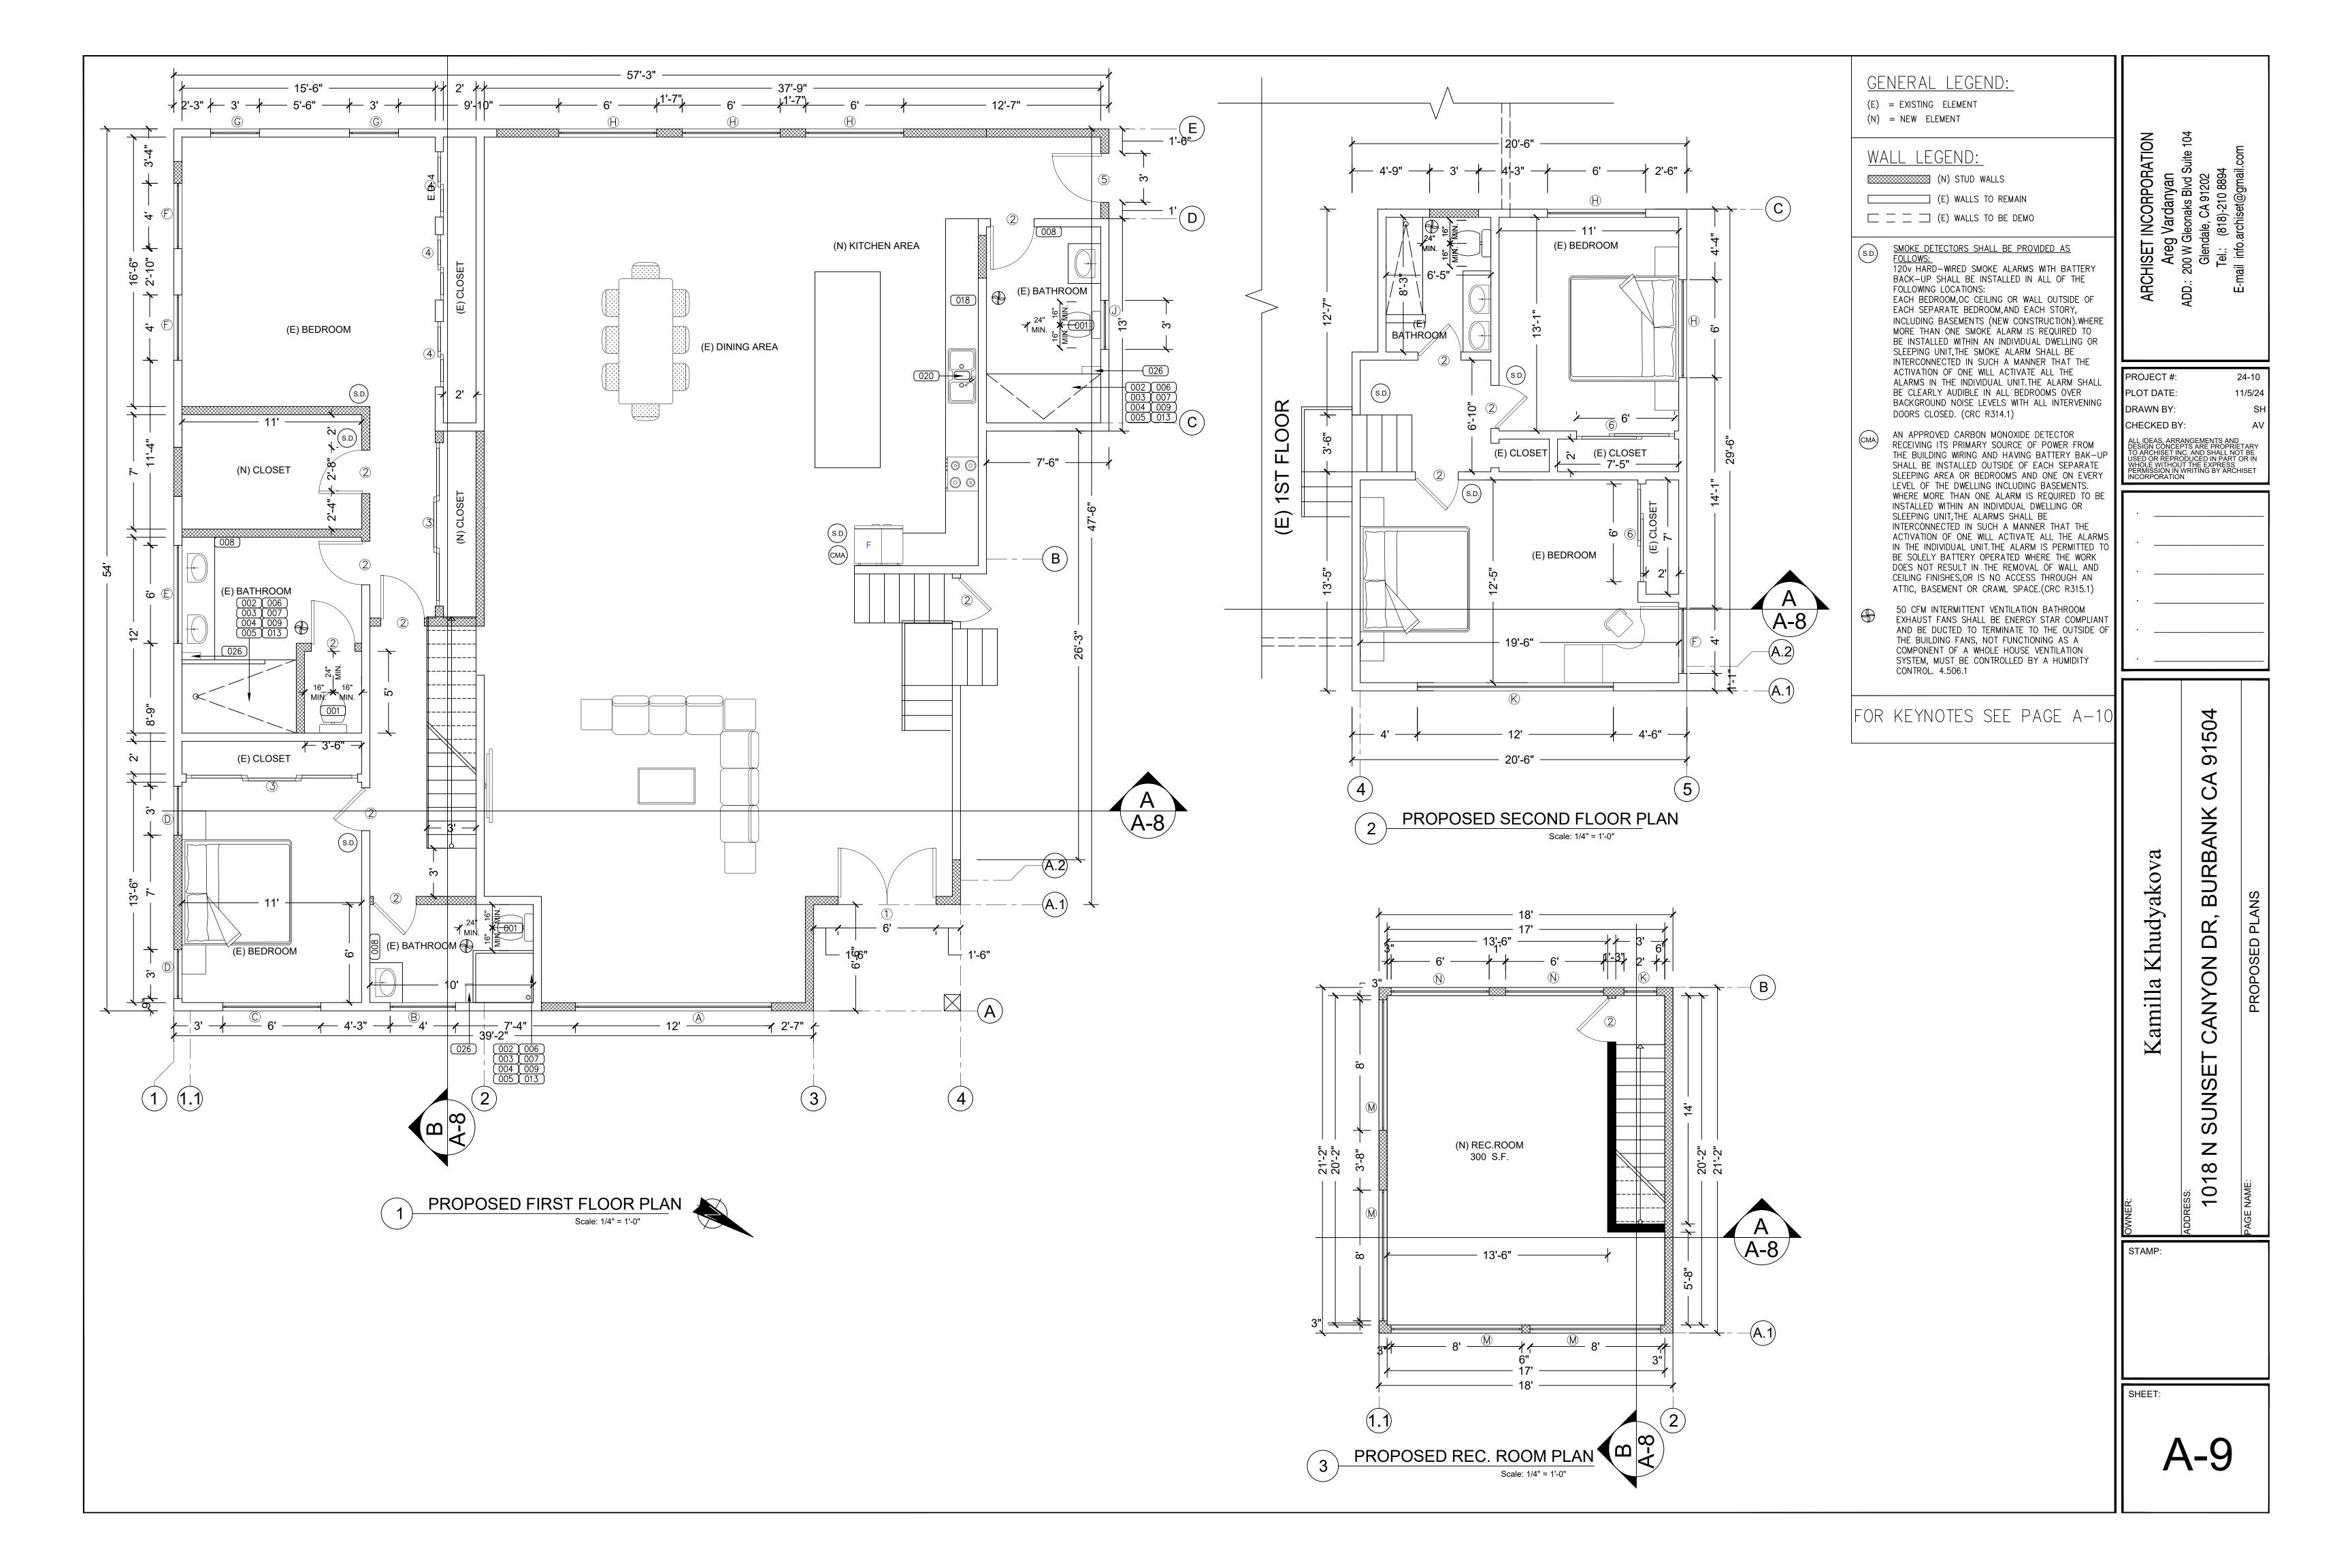

NOTE: SMOKE ALARM REQUIREMENTS 1. AN APPROVED SMOKE ALARM SHALL BE INSTALLED FOR NEW CONSTRUCTION AND ALTERATION, REPAIR OR ADDITIONS REQUIRING PERMIT EXCEEDING \$1000. (CRC R 314.8.2) 2. BATTERY OPERATED SMOKE ALARMS PERMITTED IN EXISTING BUILDINGS WHERE NO CONSTRUCTION IS TAKING PLACE OR IN BUILDING UNDERGOING ALTERATION OR REPAIR THAT DO NOT RESULT IN THE REMOVAL OF INTERIOR WALLS OR CEILING FINISHES, UNLESS THERE IS AN ATTIC, CRAWL SPACE OR BASEMENT WHICH COULD PROVIDE ACCESS FOR WIRING. (CRC R314.6 EXCEPTIONS 1,3, CBC 907.2.11.9) 3. SMOKE ALARMS SHALL BE INTERCONNECTED SUCH THAT THE ACTIVATION OF ONE ALARM WILL ACTIVATE ALL ALARMS IN THE INDIVIDUAL DWELLING UNIT. (CRC R314.4, CBC 907.10.5) 4. SMOKE DETECTORS SHALL BE "HARD WIRED" AND SHALL BE EQUIPPED WITH BATTERY BACKUP. (CRC R314.6, CBC 907.12.6, CBC 907.2.11.9) 5. SMOKE ALARMS SHALL COMPLY WITH SPÉCIFIC LOCATION REQUIREMENTS PER NFPA 72 SECTION 29.8.3.4 AN APPROVED CARBON MONOXIDE ALARM SHALL BE INSTALLED FOR EXISTING NEW CONSTRUCTION WHEN THE DWELLING UNIT CONTAINS A FUEL-FIRED APPLIANCE, FIREPLACE, AND/OR AN ATTACHED GARAGE WITH AN OPENING THAT COMMUNICATES WITH THE DWELLING. (CRC 315.2.1, CBC 915.1.1, CBC 915.1.5) CO ALARMS SHALL BE "HARD WIRED" AND SHALL BE EQUIPPED WITH BATTERY BACKUP. (CRC R315.5, CBC 915.4.1 CO ALARMS SHALL BE LISTED FOR COMPLIANCE WITH UL 2034, UL 217, UL 2075, AND MAINTAINED PER NFPA 720. (CRC R315.1.1, R315.7.2, CBC 915.4.2, CBC 915.4.4, CO ALARMS SHALL BE INSTALLED OUTSIDE OF EACH SLEEPING AREA IN THE IMMEDIATE VICINITY OF THE BEDROOMS AND ON EVERY LEVEL OF A DWELLING UNIT INCLUDING BASEMENT. (CRC R315.3, CBC 915.2) CO ALARMS SHALL BE INTERCONNECTED SUCH THAT THE ACTIVATION OF ONE ALARM WILL ACTIVATE ALL ALARMS IN THE INDIVIDUAL DWELLING UNIT. (CRC R315.5, CBC 915.4.5 IN EXISTING DWELLING UNIT, A CO ALARM IS PERMITTED TO BE BATTERY OPERATED WHERE REPAIR OR RESULT IN THE REMOVAL OF WALL OR CEILING FINISHES. (CRC R315.5 EXCEPTION 4, <u>C 915.4.1 EXCEPTION 3)</u> EXTERIOR WALLS: CONSTRUCTED OF ONE-HOUR-RATED FIRE-RESISTIVE CONSTRUCTION ON THE EXTERIOR SIDE OR CONSTRUCTED WITH APPROVED NONCOMBUSTIBLE MATERIALS. SUCH MATERIAL SHALL EXTEND. EXTERIOR WINDOWS, WINDOW WALLS AND GLAZED DOORS, WINDOWS WITHIN EXTERIOR DOORS,AND SKYLIGHTS SHALL BE TEMPERED GLASS, MULTI-LAYERED GLASS PANELS, GLASS BLOCK, OR HAVE A FIRE-PROTECTION RATING OF NOT LESS THAN 20 MINUTES. R-6 DUCT INSULATION REQUIRED SPACE HEATING MINIMUM AFUE: 80% CENTRAL — AIR CONDITIONING — SINGLE PAKAGE OR SPLIT SYSTEM. MINIMUM SEER: 14 REQUIRED: REFRIGERANT CHARGE MEASUREMENT/ DUCT SEALING THE NFRC TEMPROARY LABEL DISPLAYED ON WINDOWS AND SKYLIGHTS(INCL.TUBULAR)MUST REMAIN ON THE UNIT UNTIL FINAL INSPECTION HAS BEEN COMPLETED. HERS VERIFICATION REQUIREMENT FIRM OR INDIVIDUAL RESPONSIBLE FOR THE VERIFICATION LICENSE NO: ENERGY CALCULATION SEE ON PAGE T-24. PROVIDE CONNECTION DETAILS OF GUARDRAIL AND-OR HANDRAIL ON OPEN SIDE OF BALCONIES, DECKS, AND STAIRS ADEQUATE TO SUPPORT A SINGLE CONCENTRATED 200 LBS. LOAD APPLIED IN ANY DIRECTION AT ANY POINT ALONG THE TOP. (CRC T-R301.5, CBC T-1607.1) WHERE BALCONY OR OTHER ELEVATED WALKING SURFACES ARE EXPOSED TO WATER FROM DIRECT OR SNOW, OR IRRIGATION, AND THE STRUCTURAL FRAMING IS PROTECTED BY AN IMPERVIOUS MOISTURE BARRIER, THE CONSTRUCTION DOCUMENTS SHALL INCLUDE: (CRC R106.1.6, CBC 107.2.5) 1. DETAILS FOR ALL ELEMENTS OF THE IMPERVIOUS MOISTURE BARRIER SYSTEM. 2. MANUFACTURER'S INSTALLATION INSTRUCTIONS. 3. MANUFACTURER AND ICC/UL/FM NUMBER. 4. BALCONY SLOPE OF ALL AREAS ON THE PLAN. 5. NOTE ON PLAN THAT INSTALLATION SHALL BE IN ACCORDANCE WITH MANUFACTURER'S SPECIFICATIONS. WHERE BALCONY OR OTHER ELEVATED WALKING SURFACES ARE EXPOSED TO WATER FROM DIRECT OR SNOW, OR IRRIGATION, AND THE STRUCTURAL FRAMING IS PROTECTED BY AN IMPERVIOUS MOISTURE ELEMENTS OF THE IMPERVIOUS MOISTURE BARRIER SYSTEM SHALL NOT BE CONCEALED UNTIL INSPECTED AND APPROVED. (CRC R109.1.5.3, CBC 110.3.6) WOOD STRUCTURAL MEMBERS THAT SUPPORT MOISTURE-PERMEABLE FLOORS OR ROOFS THAT ARE WEATHER, SUCH AS CONCRETE OR MASONRY SLABS, SHALL BE OF NATURALLY DURABLE OR IPRESERVATIVE—TREATED WOOD UNLESS SEPARATED FROM SUCH FLOORS OR ROOFS BY AN IMPERVIOUS MOISTURE BARRIER. THE MOISTURE BARRIER SYSTEM PROTECTING THE STRUCTURE SUPPORTING FLOORS SHALL PROVIDE POSITIVE WATER THAT INFILTRATES THE MOISTURE-PERMEABLE FLOOR TOPPING. (CRC R317.1; CBC 2304.12.2.5) ENCLOSED FRAMING IN EXTERIOR BALCONIES AND ELEVATED WALKING SURFACES THAT ARE EXPOSED TO SNOW, OR DRAINAGE FROM IRRIGATION, SHALL BE PROVIDED WITH OPENINGS THAT PROVIDE A NET FREE VENTILATION AREA NOT LESS THAN 1/150 OF THE AREA OF EACH SEPARATE SPACE. (CRC R317.1.3; CBC 2304.12.2.6) PROVIDE THE FOLLOWING INFORMATION ON PLANS: 1. VENTILATION CALCULATIONS FOR BALCONY AND/OR ELEVATED WALKING SURFACE.

. VENTILATION DETAIL SHOWING HOW NET FREE ĆROSS VENTILATION IS TO BE ACHIEVED. PROVIDE

INSTALLATION SHALL BE IN ACCORDANCE WITH MANUFACTURER'S SPECIFICATIONS.

FLOOR PLAN KEYNOTES: SMOKE DETECTORS SHALL BE PROVIDED AS FOLLOWS: 120v HARD-WIRED SMOKE ALARMS WITH BATTERY BACK-UP SHALL BE INSTALLED IN ALL OF THE FOLLOWING LOCATIONS: EACH BEDROOM,OC CEILING OR WALL OUTSIDE OF EACH SEPARATE BEDROOM,AND EACH STORY,INCLUDING BASEMENTS (NEW CONSTRUCTION). WHERE MORE THAN ONE SMOKE ALARM IS REQUIRED TO BE INSTALLED WITHIN AN INDIVIDUAL DWELLING OR SLEEPING UNIT, THE SMOKE ALARM SHALL BE INTERCONNECTED IN SUCH A MANNER THAT THE ACTIVATION OF ONE WILL ACTIVATE ALL THE ALARMS IN THE INDIVIDUAL UNIT.THE ALARM SHALL BE CLEARLY AUDIBLE IN ALL BEDROOMS OVER BACKGROUND NOISE LEVELS WITH ALL INTERVENING DOORS CLOSED. (CRC R314.1) AN APPROVED CARBON MONOXIDE DETECTOR RECEIVING ITS PRIMARY SOURCE OF POWER FROM THE BUILDING WIRING AND HAVING BATTERY BAK-UP SHALL BE INSTALLED OUTSIDE OF EACH SEPARATE SLEEPING AREA OR BEDROOMS AND ONE ON EVERY LEVEL OF THE DWELLING INCLUDING BASEMENTS. WHERE MORE THAN ONE ALARM IS REQUIRED TO BE INSTALLED WITHIN AN INDIVIDUAL DWELLING OR SLEEPING UNIT, THE ALARMS SHALL BE INTERCONNECTED IN SUCH A MANNER THAT THE ACTIVATION OF ONE WILL ACTIVATE ALL THE ALARMS IN THE INDIVIDUAL UNIT.THE ALARM IS PERMITTED TO BE SOLELY BATTERY OPERATED WHERE THE WORK DOES NOT RESULT IN THE REMOVAL OF WALL AND CEILING FINISHES, OR IS NO ACCESS THROUGH AN ATTIC, BASEMENT OR CRAWL SPACE. (CRC R315.1) 50 CFM INTERMITTENT VENTILATION BATHROOM EXHAUST FANS SHALL BE ENERGY STAR COMPLIANT AND BE DUCTED TO TERMINATE TO THE OUTSIDE OF THE BUILDING FANS, NOT FUNCTIONING AS A COMPONENT OF A WHOLE HOUSE VENTILATION SYSTEM, MUST BE CONTROLLED BY A HUMIDITY CONTROL. 4.506.1 ALL WATER CLOSET SHALL USE NO MORE THAN 1.28 GALLONS PER FLUSH. WAINSCOT UP TO CEILING, (SEE FLOOR PLAN 002 HOT-MOP SHOWER PAN WITH CERAMIC TILE FOR SIZE OF SHOWER). PROVIDE SHATTERROOF GLASS ENCLOSURE. PROVIDE SOAP DISH AT TUB AND SHOWER, 003 ALL SHOWERS AND TUB-SHOWERS SHALL HAVE EITHER A PRESSURE BALANCE OR THERMOSTATIC MIXING VALVE. (004) PROVIDE 72" HIGH NON-ABSORBENT WALL FINISH ADJACENT TO SHOWER. 005 | MINIMUM DIMENSION OF SHOWER TO BE 1024 SQ. INCH WITH 30" DIAMETER CLEAR. 006 PROVIDE TEMPERED GLASS ON DOORS AND ENCLOSURE FOR HOT TUB, BATHTUB, SHOWERS (ALSO GLAZING IN WALL ENCLOSING THESE COMPARTMENTS WITHIN 5'-0" OF STANDING SURFACE). 007 | 2X6 STUDS AT 16" O.C.PLUMBING WALL. (008) | G.F.I. OUTLET (009) PROVIDE SOUND INSULATION AT ALL BATHROOM & LAUNDRY ROOM WALLS. 010 GAS TANKLESS WATER HEATER (TAKAGI T-H3-OS-N) O11 | GLAZING IN LATEING. GLAZING IN EXTERIOR DOORS OR 40 INCHES OF ANY LOCKING MECHANISM SHALL BE OF FULLY TEMPERED GLASS. OR RATED BURGLARY A. MINIMUM OF 22"x30" ATTIC ACCESS AT 30" MIN. CLEAR HEADROOM. 013 | R-4 INSULATION SHALL BE INSTALLED ON THE FIRST 5 FEET OF HOT AND COLD WATER PIPES. 014 | (E)WATER HEATER 015 (E) HVAC UNIT IN THE ROOF A MINIMUM 4" MOISTURE EXHAUST DUCT MUST BE PROVIDED O16 | A MINIMUM 4 MUISTONE EARLASS, DOS. MITH TWO 90% ELBOWS. A FLEXIBLE DUCT CANNOT EXTEND MORE THAN 6'-0" AND CANNOT BE CONCEALED. NEW WASHER AND DRYER 018 | NEW COUNTER W/ CABINETS ABV. 019 NEW REFRIGERATOR BY OWNER 020 NEW SINK BY OWNER NEW STOVE BY OWNER 022 | NEW DISHWASHER BY OWNER 023 | NEW FULL HEIGHT CABINETS (E)ELECTRIC METER WASHER/DRYER SPACE. ROUGH-IN PLUMBING FOR HOT/COLD WATER & WASTE. VENT DRYER TO OUTSIDE AIR, PROVIDE 120V & 220V ELEC. OUTLET AND FUEL GAS OUTLET. 12"x12" MINIMUM PLUMBING ACCESS FOR TUBS. 1" MAX. DROP. THE LANDING OR FINISHED FLOORS SHALL NOT BE MORE THAN 1 1/2" LOWER THAN THE TOP OF THRESHOLD EXCEPT THE LANDING OR FLOOR ON THE EXTERIOR SIDE SHALL NOT BE MORE THAN 73" BELOW THE TOP OF THRESHOLD PROVIDED THE DOOR DOES NOT SWING OVER THE LANDING OF FLOOR GENERAL LEGEND: WALL LEGEND: (N) STUD WALLS (E) = EXISTING ELEMENT(N) = NEW ELEMENT(E) WALLS TO REMAIN _ _ (E) WALLS TO BE DEMO

ALL DOORS AND WINDOWS SHALL MEET CITY OF BURBANK SECURITY ORDINANCE										
	WINDOW SCHEDULE									
WINDOW	OPENING SIZE W x H	MATERIAL	LOCATION	TYPE	DUAL	TEMPERED GLASS	EGRESS	FRAME	U-FACTOR SHGC	
А	12'-0"-x 8'-0"	VINYL	LIVING ROOM	А	•	•		NAIL-IN	U-FACTOR 0.3 SHGC 0.23	
В	4'-0"-x 8'-0"	VINYL	BATHROOM	А	•	BATH.		NAIL-IN	U-FACTOR 0.3 SHGC 0.23	
С	6'-0"-x 8'-0"	VINYL	BEDROOM	А	•			NAIL-IN	U-FACTOR 0.3 SHGC 0.23	
D	3'-0"-x 5'-0"	VINYL	BEDROOM	А	•			NAIL-IN	U-FACTOR 0.3 SHGC 0.23	
E	6'-0"-x 3'-0"	VINYL	BATHROOM	А	•	BATH.		NAIL-IN	U-FACTOR 0.3 SHGC 0.23	
F	4'-0"-x 4'-0"	VINYL	BEDROOM	А	•			NAIL-IN	U-FACTOR 0.3 SHGC 0.23	
G	3'-0"-x 5'-0"	VINYL	BEDROOM	А	•			NAIL-IN	U-FACTOR 0.3 SHGC 0.23	
Н	6'-0"-x 4'-0"	VINYL	DINING AREA,BEDROOM	А	•			NAIL-IN	U-FACTOR 0.3 SHGC 0.23	
J	6'-0"-x 4'-0"	VINYL	BATHROOM	А	•	BATH.		NAIL-IN	U-FACTOR 0.3 SHGC 0.23	
K	6'-0"-x 4'-0"	VINYL	BEDROOM	А	•			NAIL-IN	U-FACTOR 0.3 SHGC 0.23	
L	2'-0"-x 3'-0"	VINYL	GARAGE	А	•			NAIL-IN	U-FACTOR 0.3 SHGC 0.23	
М	8'-0"-x 5'-0"	VINYL	REC. ROOM	Α	•			NAIL-IN	U-FACTOR 0.3 SHGC 0.23	
N	6'-0"-x 5'-0"	VINYL	REC. ROOM	А	•			NAIL-IN	U-FACTOR 0.3 SHGC 0.23	
K	2'-0"-x 5'-0"	VINYL	REC. ROOM	А	•			NAIL-IN	U-FACTOR 0.3 SHGC 0.23	

DOOR SCHEDULE								
DOOR	DOOR SIZE (W x H)	MATERIAL	THICKNESS	LOCATION	TYPE	DUAL GLAZED	TEMPERED GLASS	REMARKS
1	6'-0" x 9'-0"	WOOD	1 3/4"	EXTERIOR		•	•	DOUBLE HUNG
2	2'-8" x 6'-8"	WOOD	1 3/4"	INTERIOR				SINGLE HUNG
3	3 3'-6" x 6'-8"			INTERIOR				TRIPLE SLIDING
4	2 2'-0" x 6'-8"			INTERIOR				DOUBLE SLIDING
5	3'-0" x 6'-8"			EXTERIOR				SINGLE HUNG
6	2 3'-6" x 6'-8"			INTERIOR				DOUBLE SLIDING
7	16'-0" x 7'-0"			GARAGE GATE				GARAGE GATE

BEDROOM EGRESS WINDOWS HAVE A MINIMUM CLEAR OPENING AREA OF 5.7 S.F WHEN ABOVE THE GRADE—FLOOR AND 5 S.F. ON THE GRADE—FLOOR, A MINIMUM NET HEIGHT OF 24", A MINIMUM NET WIDTH OF 20", AND A SILL HEIGHT NOT MORE THAN 44" ABOVE FINISH FLOOR. (CRC R310, CBC 1030)

ARCHISET INCORPORATION
Areg Vardanyan
ADD.: 200 W Gleonaks Blvd Suite 104
Glendale, CA 91202

PROJECT #: 24-10

PLOT DATE: 11/5/24

DRAWN BY: SH

CHECKED BY: AV

ALL IDEAS, ARRANGEMENTS AND
DESIGN CONCEPTS ARE PROPRIETARY
TO ARCHISET INC. AND SHALL NOT BE
USED OR REPRODUCED IN PART OR IN
WHOLE WITHOUT THE EXPRESS
PERMISSION IN WRITING BY ARCHISET
INCORPORATION

.
.

a Khudyakova ON DR, BURBANK CA 91504

Kamilla Khu SUNSET CANYON D


4


0


STAMP:

SHEET.

A-10

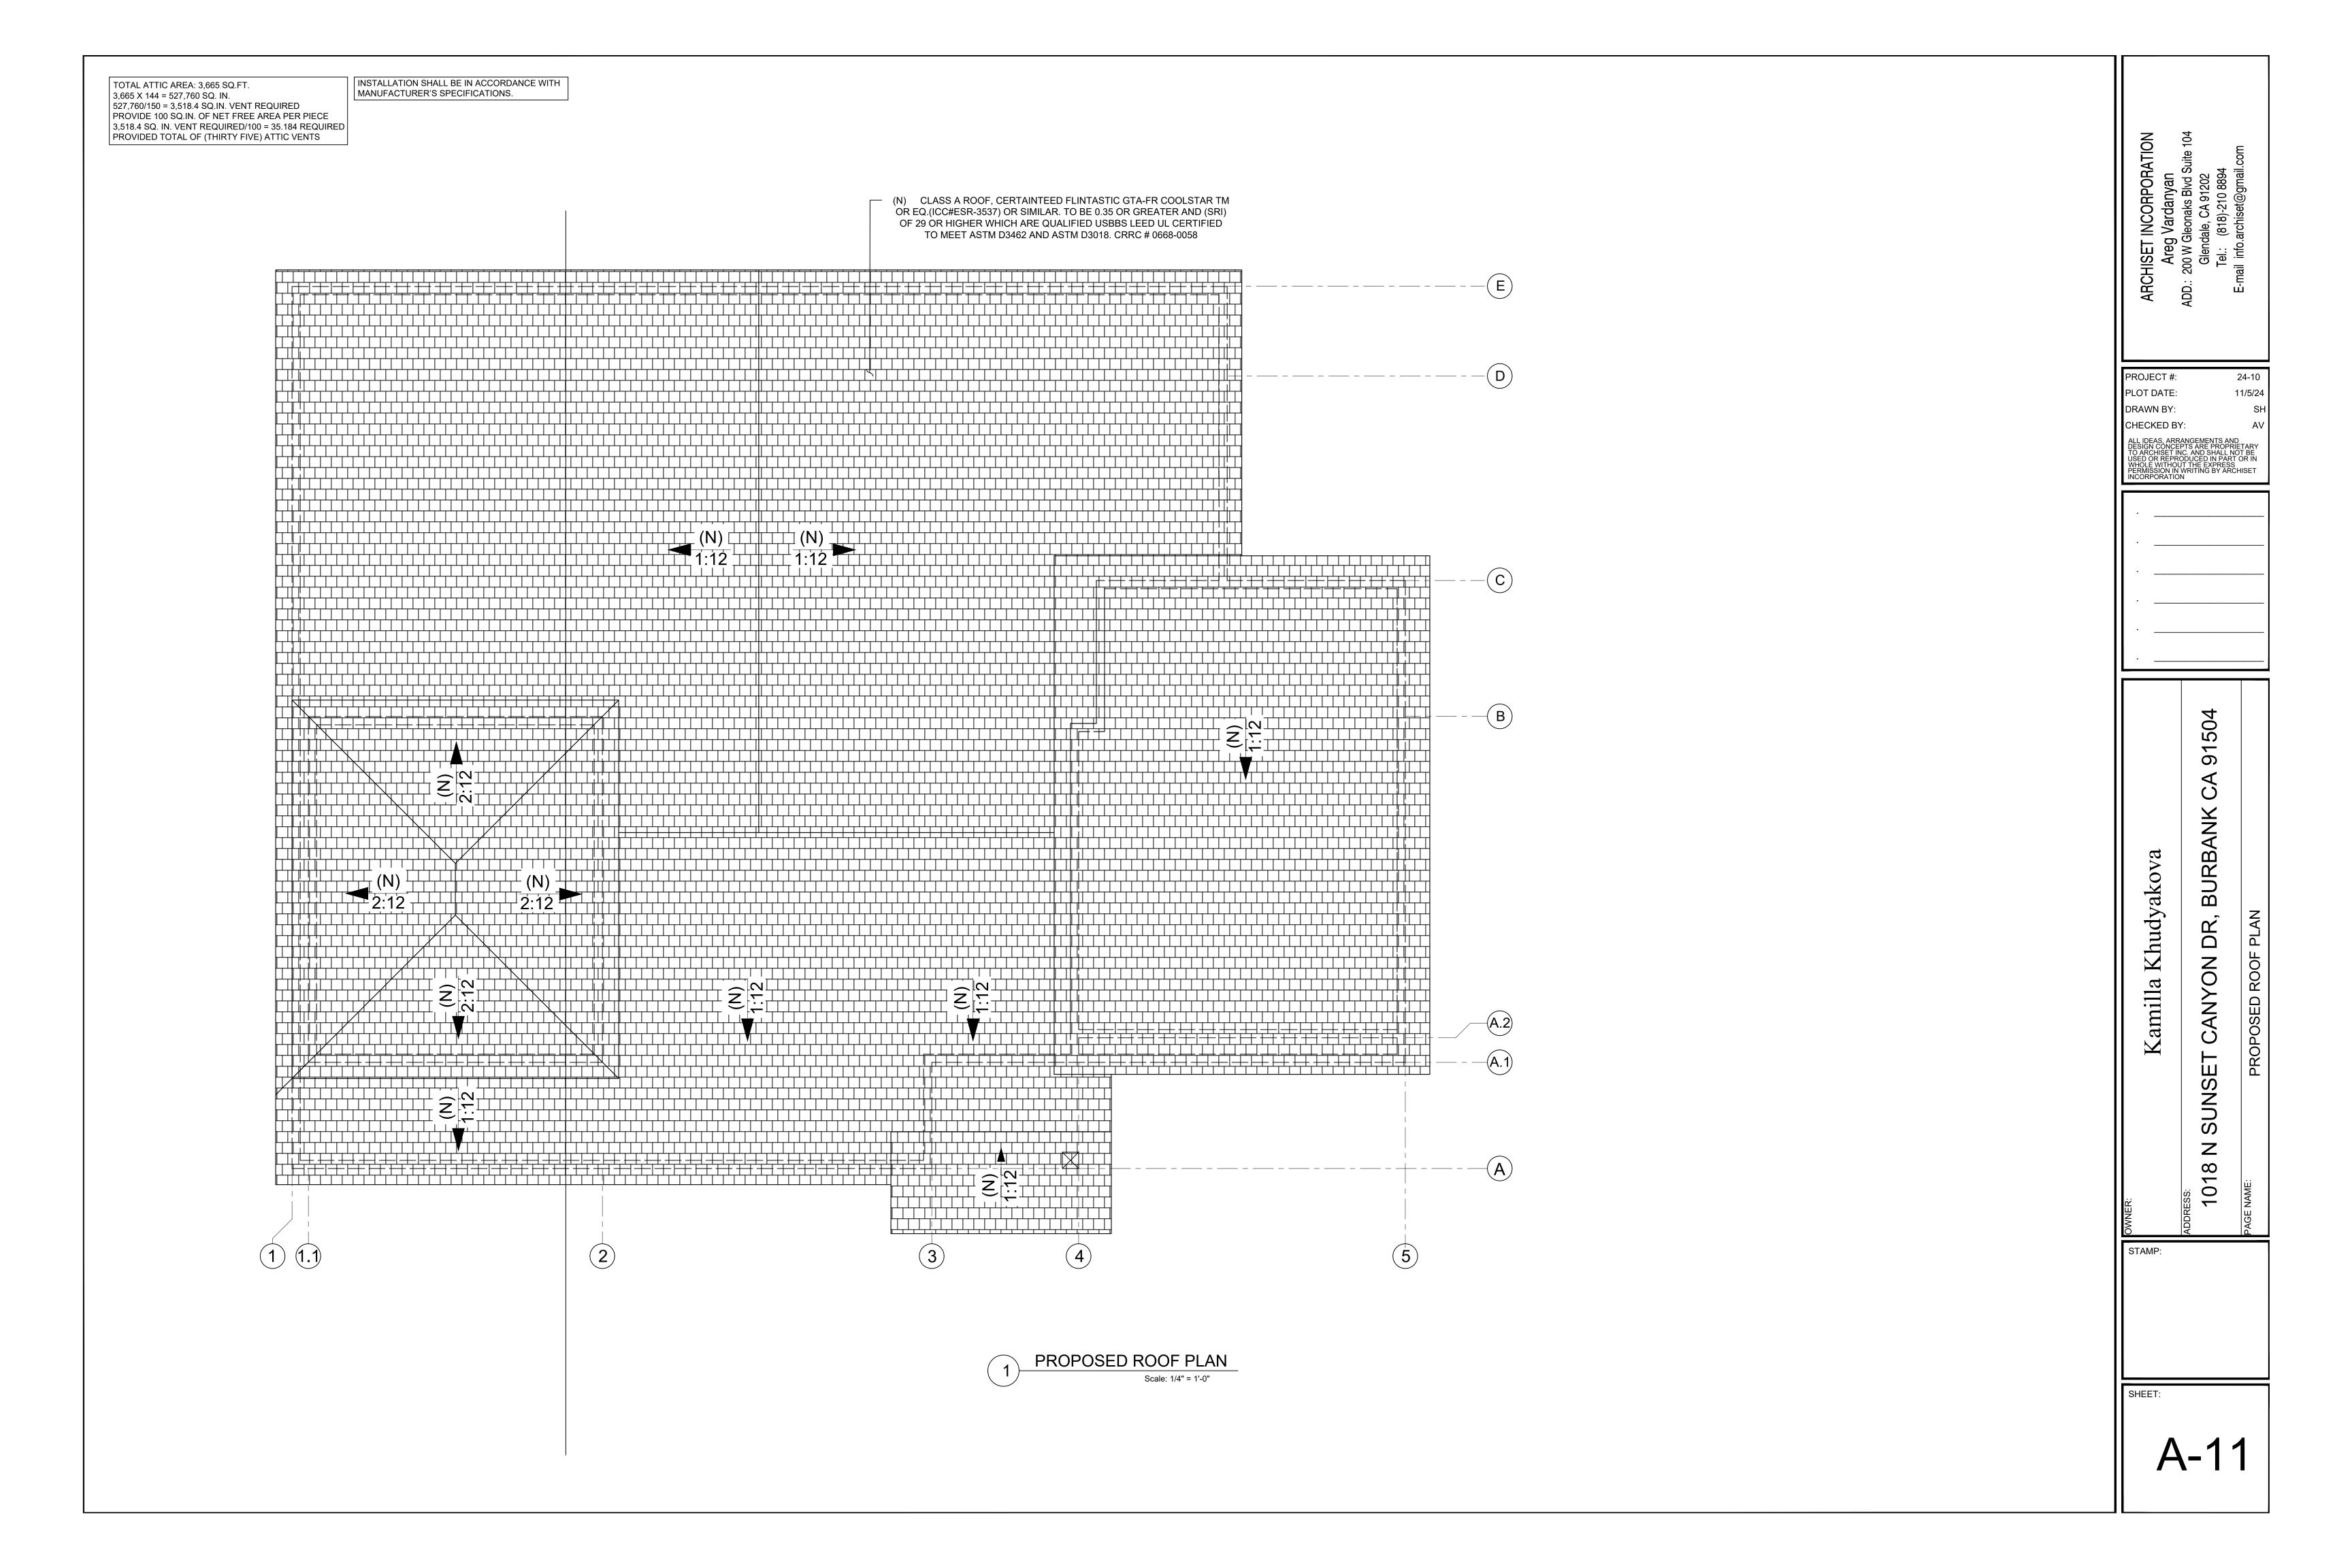

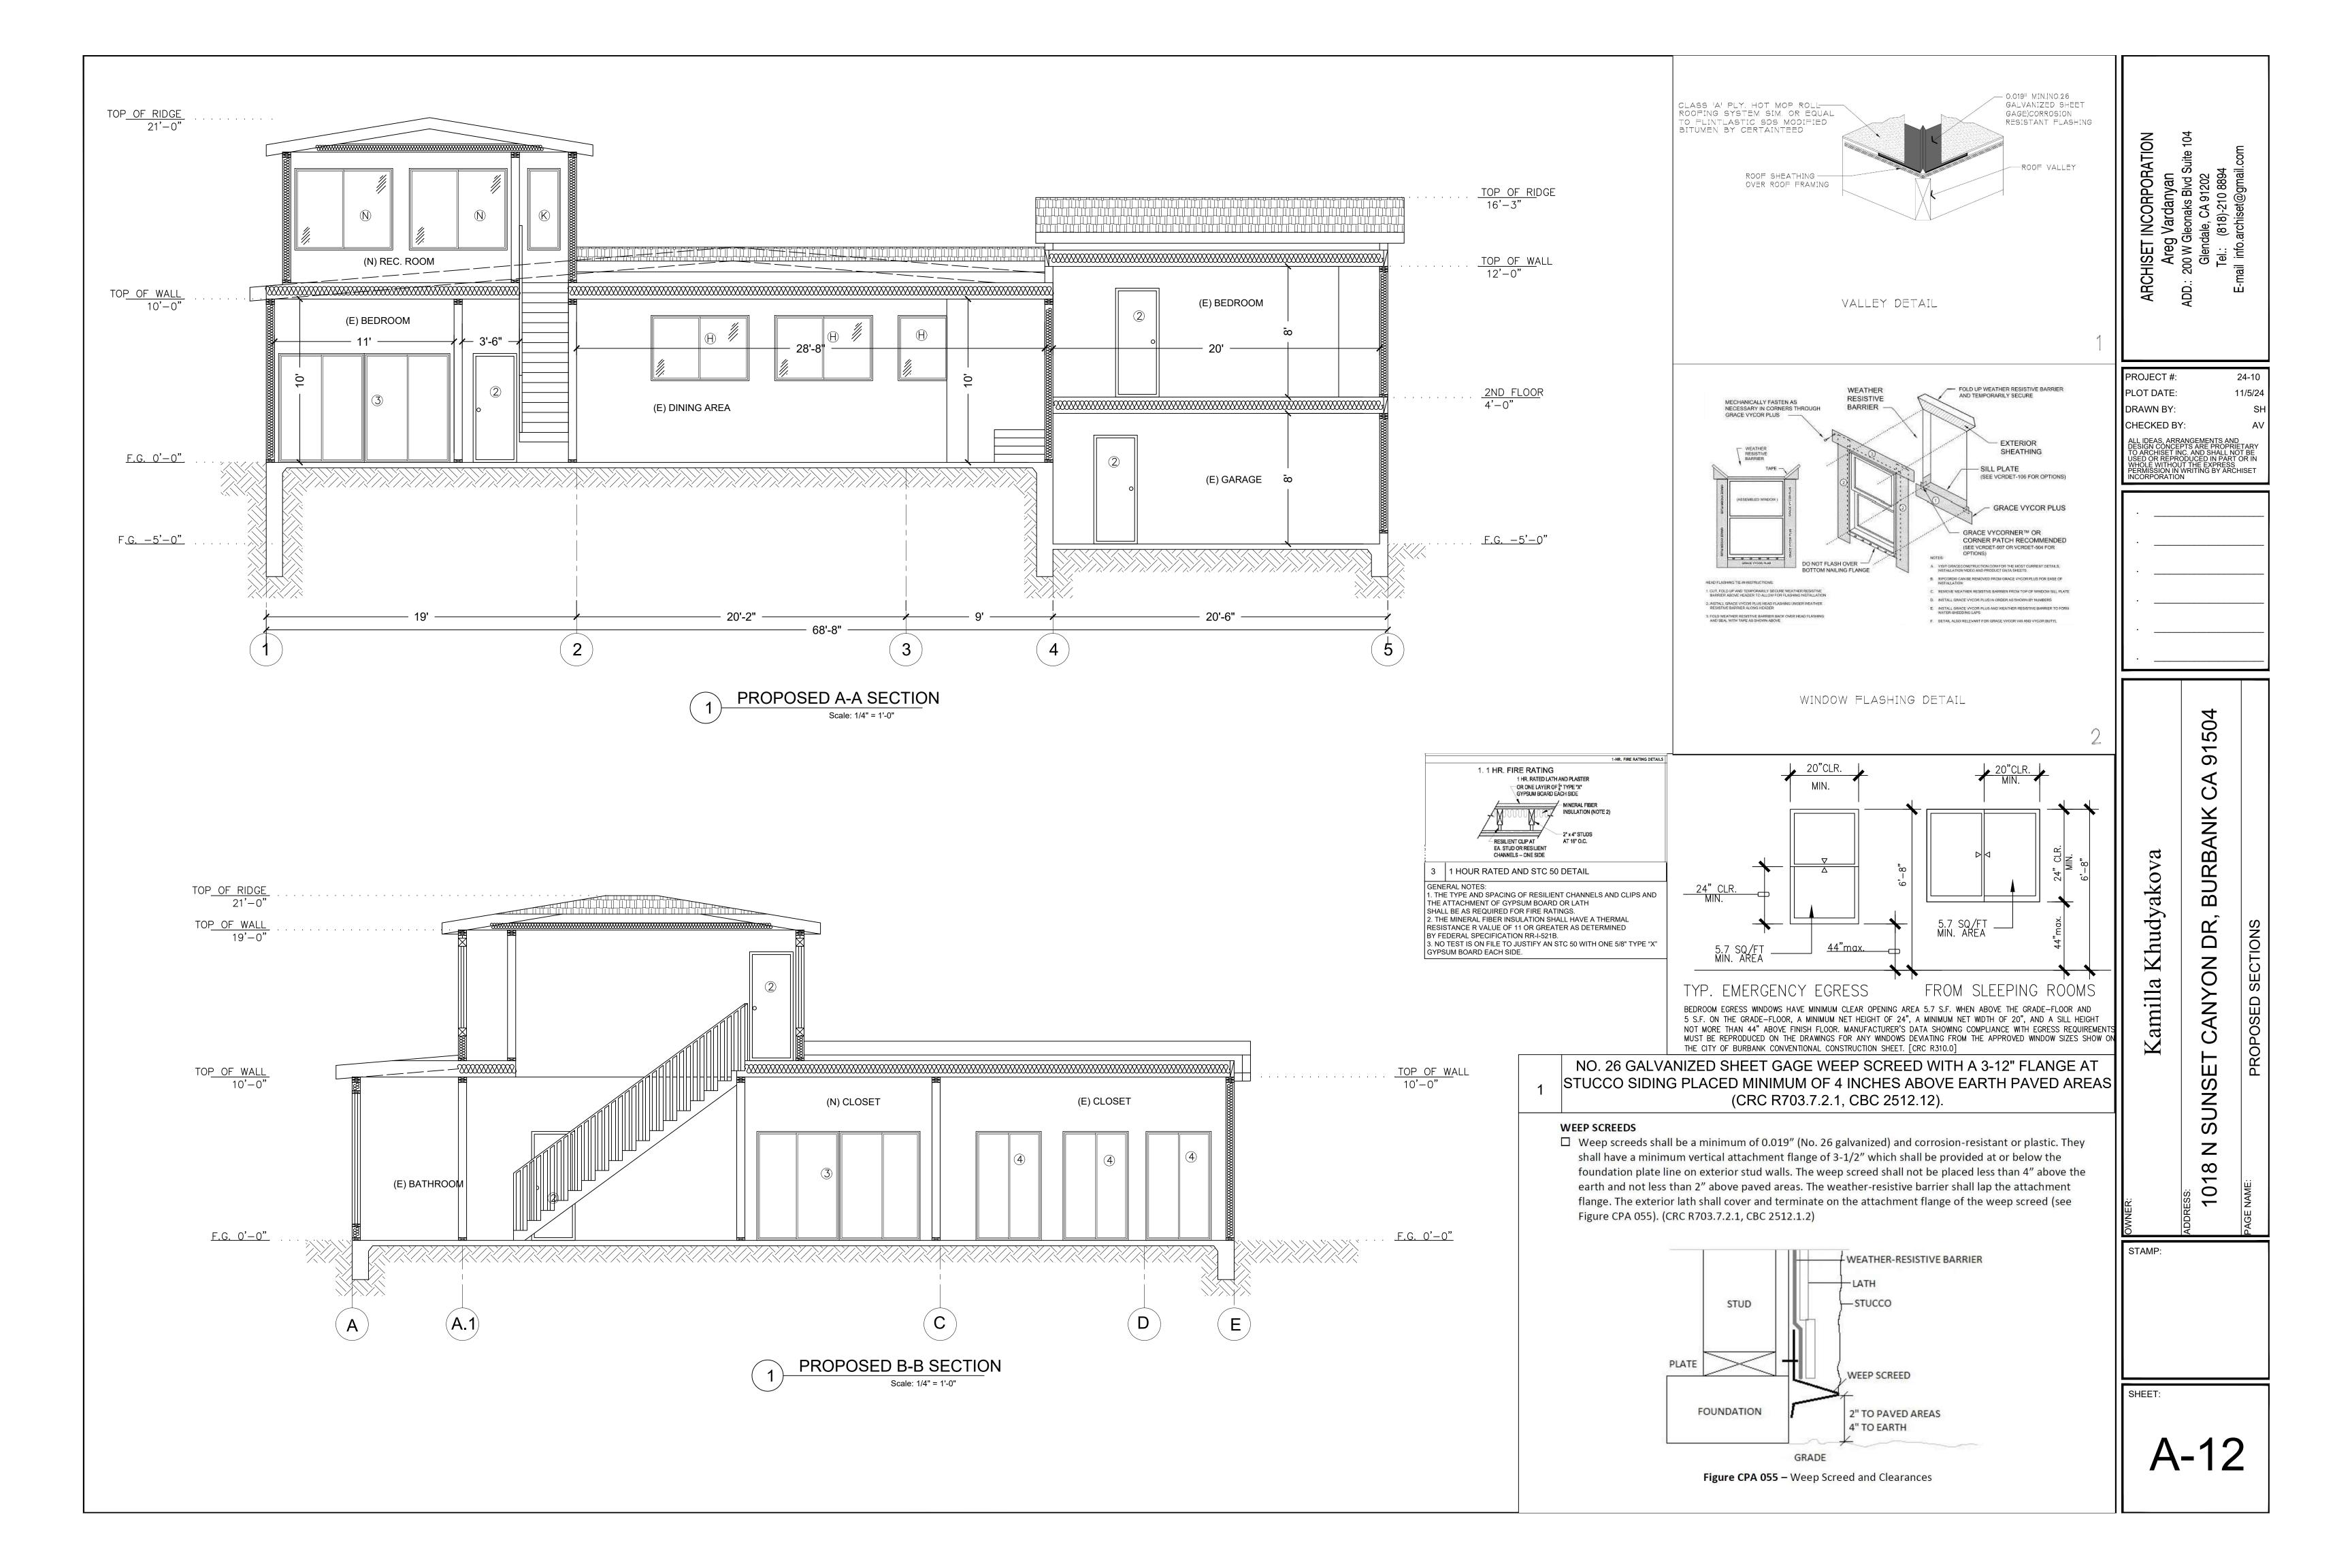


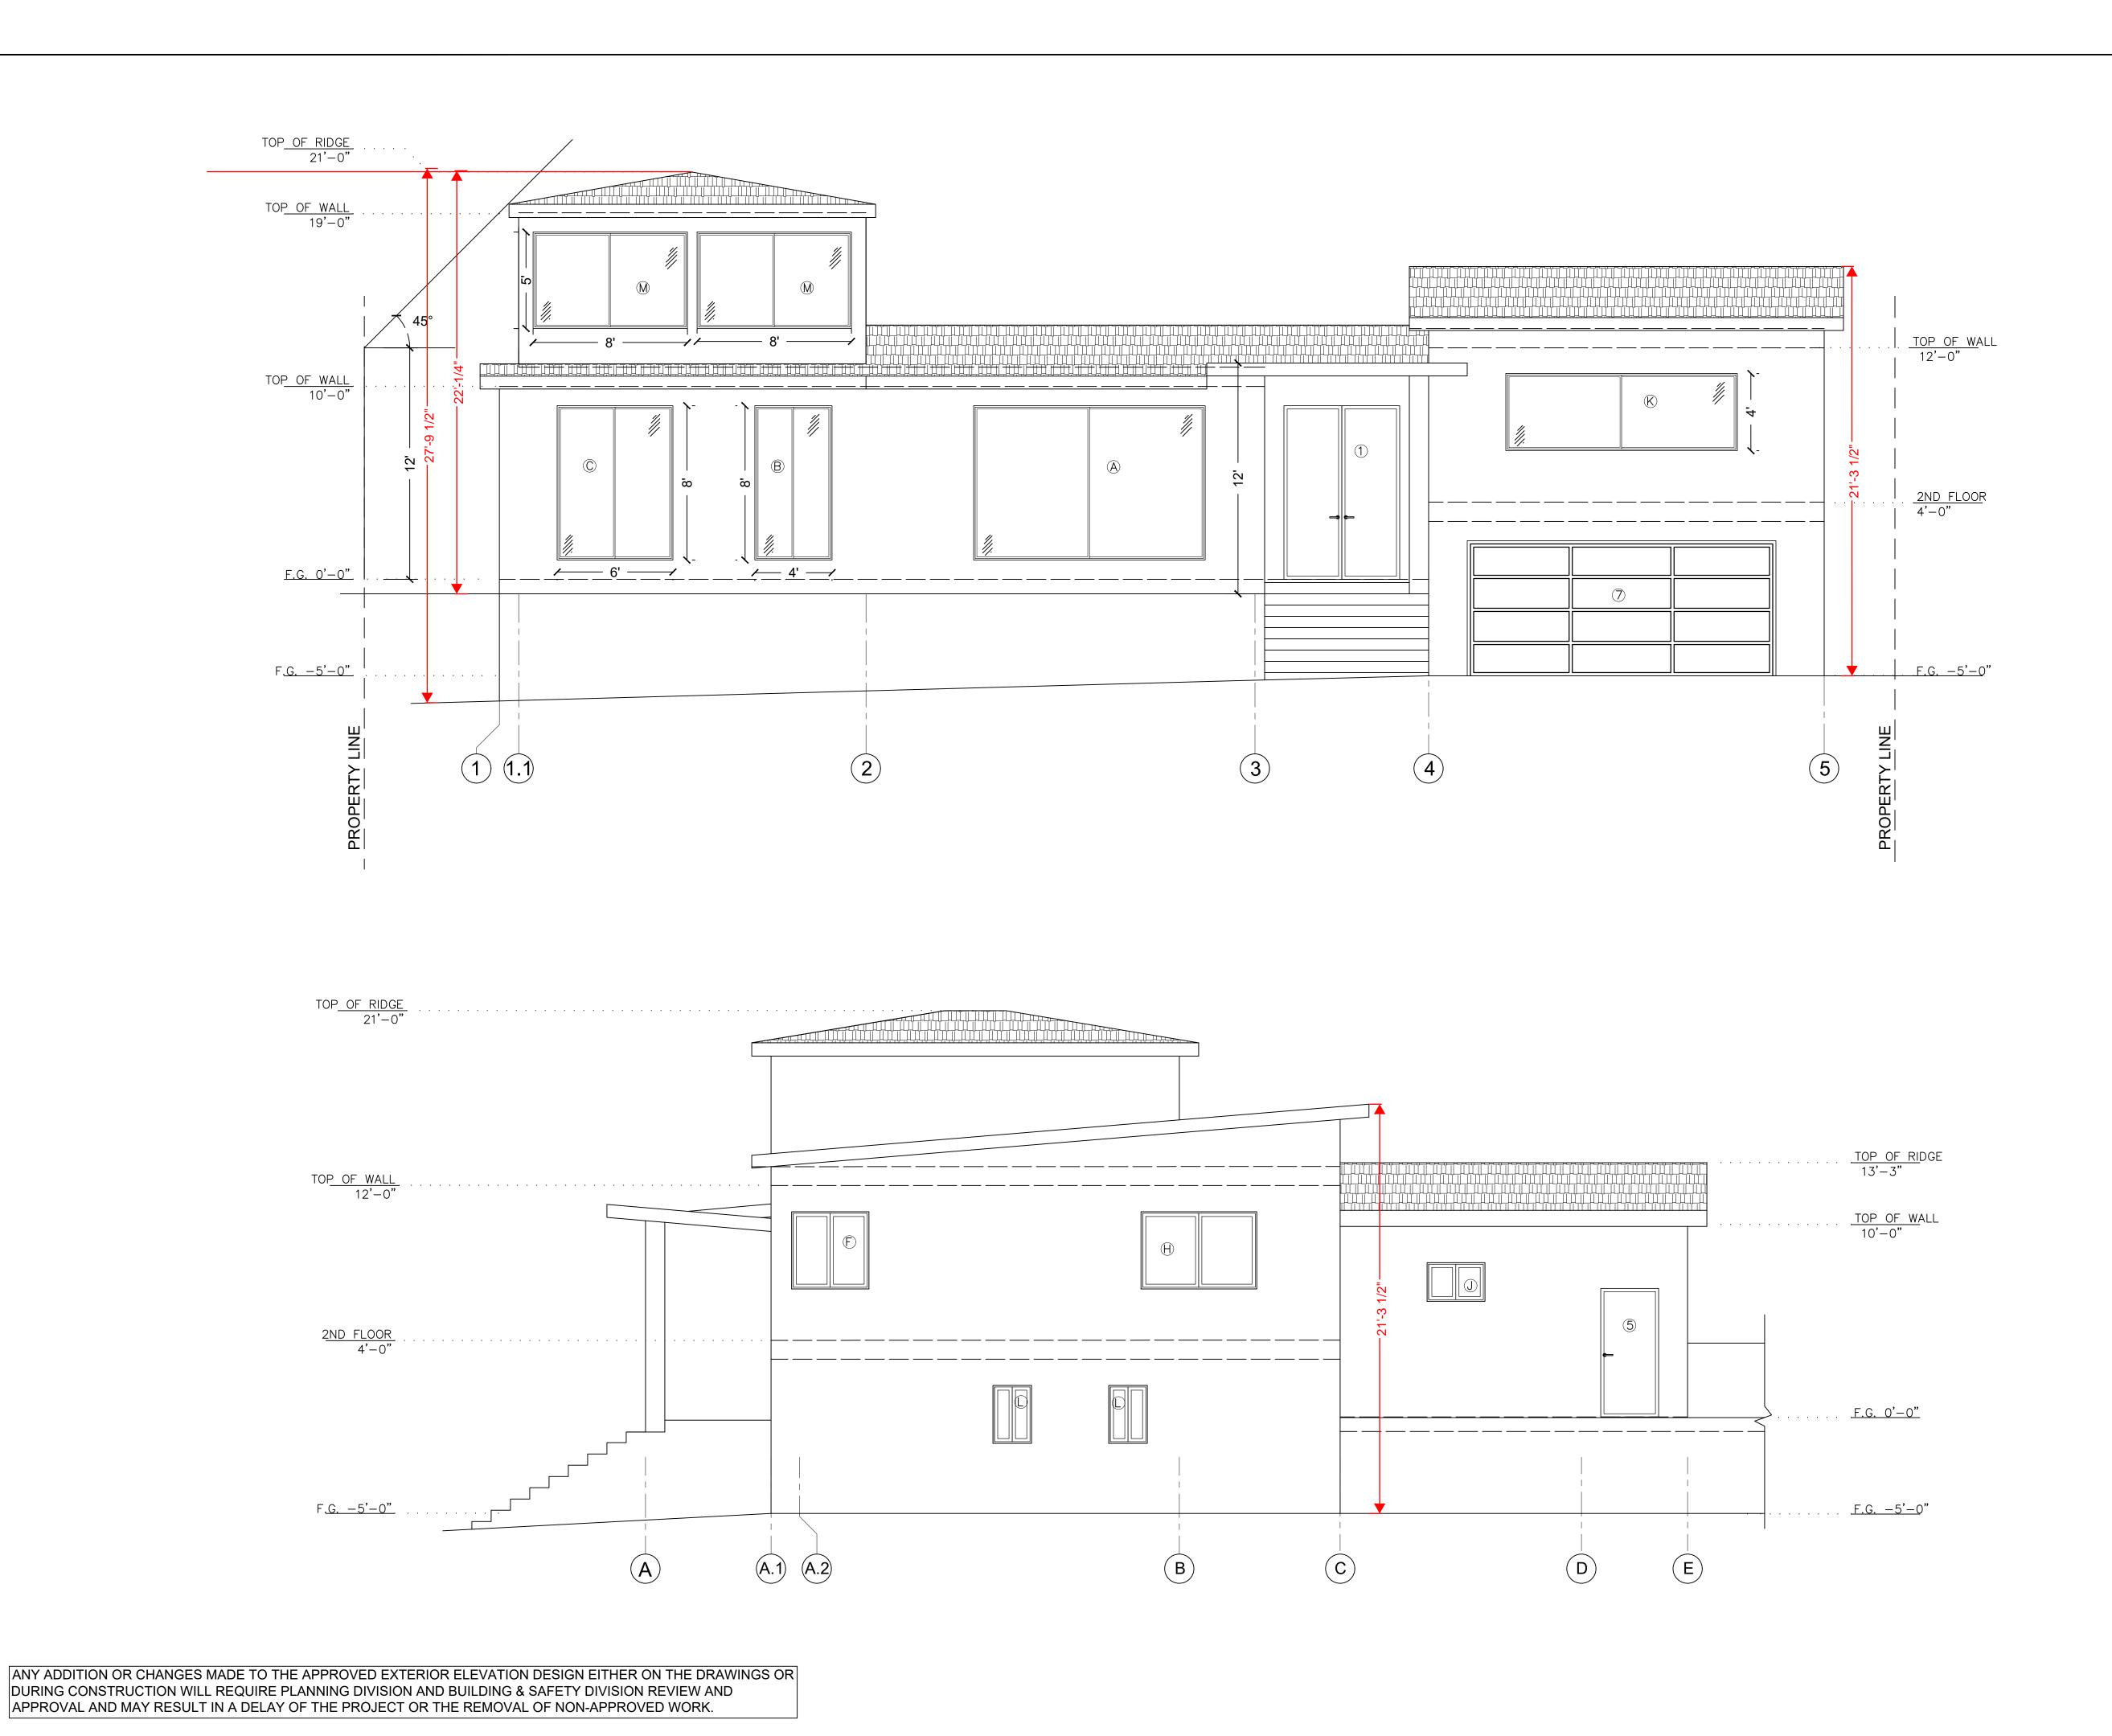


PROJECT #: 24-10 PLOT DATE: 11/5/24 DRAWN BY: CHECKED BY: 91504 BURBAN Khudyakova DR, Kamilla 0

SHEET

A-13

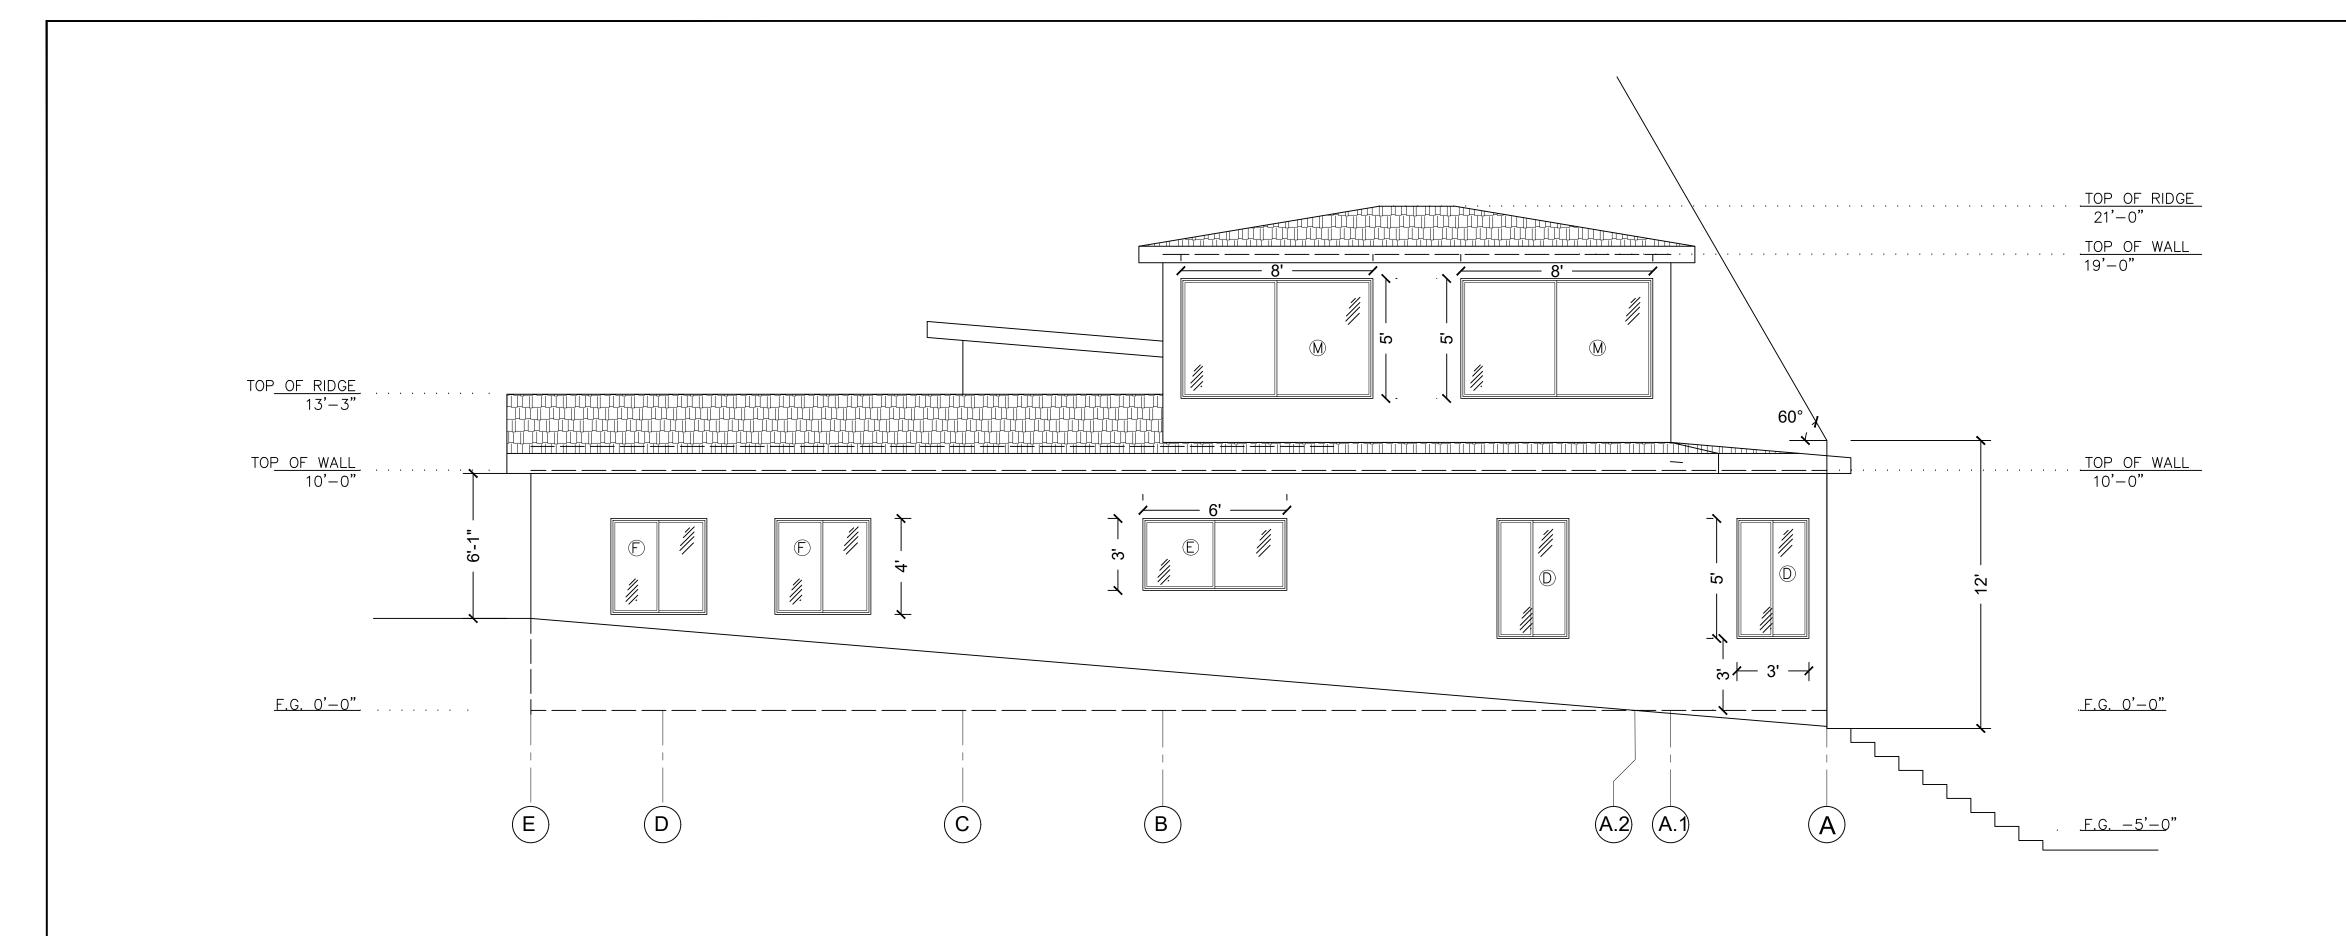

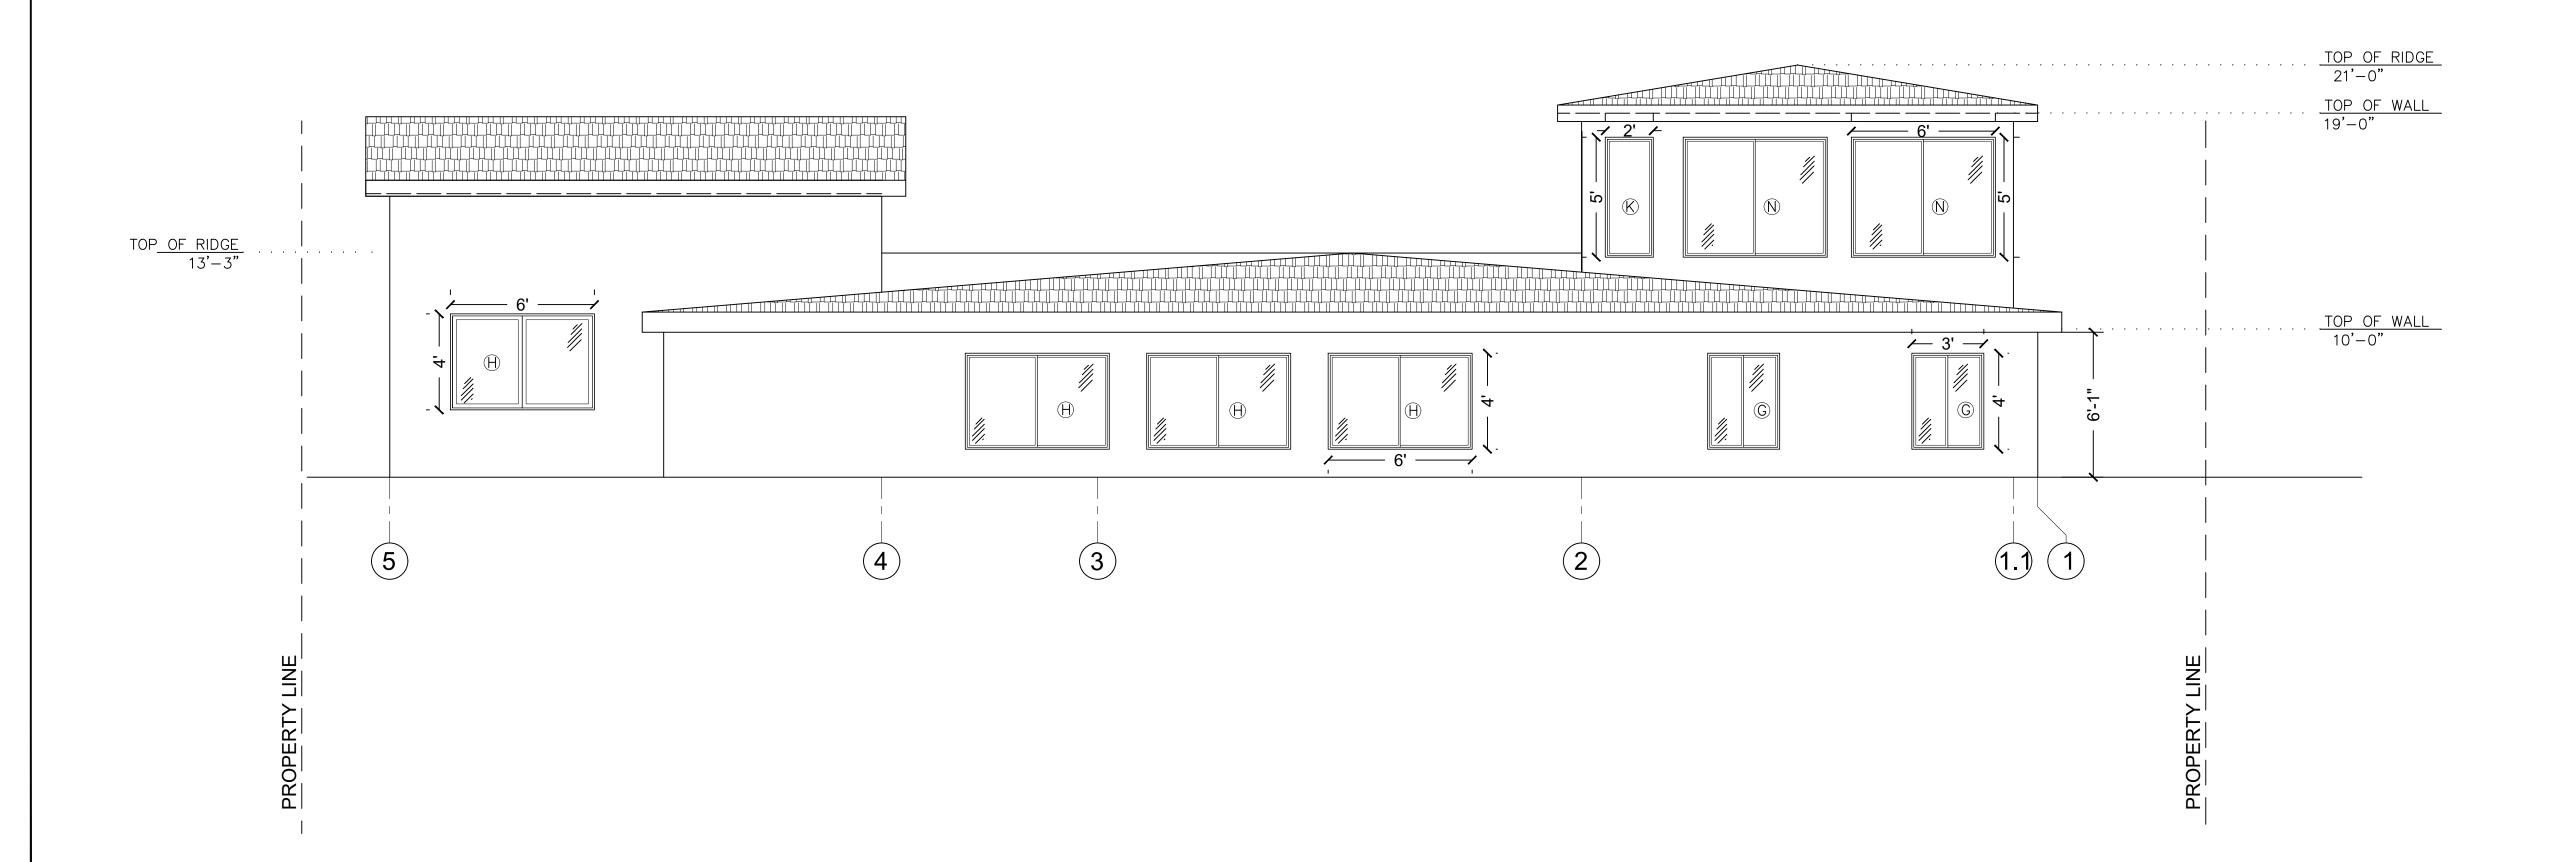

ANY ADDITION OR CHANGES MADE TO THE APPROVED EXTERIOR ELEVATION DESIGN EITHER ON THE DRAWINGS OR DURING CONSTRUCTION WILL REQUIRE PLANNING DIVISION AND BUILDING & SAFETY DIVISION REVIEW AND APPROVAL AND MAY RESULT IN A DELAY OF THE PROJECT OR THE REMOVAL OF NON-APPROVED WORK.

ARCHISET INCORPORATION
Areg Vardanyan
ADD.: 200 W Gleonaks Blvd Suite 104
Glendale, CA 91202

ESS:
1018 N SUNSET CANYON DR, BURBANK CA 91

A-14