BUILDING DESIGN

PARALLEL BUILDING

DESIGN STUDIO INC.

STUDIO

P.O.BOX 1602

PROJECT NAME:

PROJECT ADDRESS:

Scale: N/A

2230 N FREDERIC ST.

BURBANK CA. 91504

COVER SHEET

Glendale, CA 91209

Phone:(818)939-3201

Sevana@Parallelbd.com

Mr.ROGER RANJBAR

GENERAL NOTES

TAKE CAREFUL NOTE OF ALL REQUIREMENTS UNDER DIVISION 1 — GENERAL REQUIREMENTS THAT ARE MADE A PART OF THE CONTRACT, INCLUDING PROJECT REQUIREMENTS, GENERAL REQUIREMENTS, PROJECTION AND SPECIAL PRECAUTIONS, AND THE GENERAL CONDITIONS OF THE CONTRACT FOR CONSTRUCTION.

IT SHALL BE THE CONTRACTOR'S RESPONSIBILITY TO VERIFY ALL DIMENSIONS AND CONDITIONS AT THE JOB SITE AND TO CROSSCHECK DETAILS AND DIMENSIONS ON THE STRUCTURAL DRAWINGS WITH RELATED REQUIREMENTS ON THE ARCHITECTURAL, MECHANICAL AND ELECTRICAL DRAWINGS. FLOOR OPENINGS, SLEEVES AND OTHER ARCHITECTURAL, MECHANICAL AND ELECTRICAL REQUIREMENTS MUST BE COORDINATED BEFORE THE CONTRACTOR PROCEEDS WITH CONSTRUCTION.

. ALL WORK AND MATERIALS ARE TO COMPLY IN EVERY RESPECT WITH THE LATEST REQUIREMENTS OF ALL APPLICABLE CITY. COUNTY AND STATE CODES. LOCAL REGULATIONS AND THE DIRECTION OF THE BUILDING INSPECTOR FOR SUCH BUILDING LAWS. REGULATIONS AND DIRECTIONS ARE TO BE CONSIDERED AS PART OF THESE SPECIFICATIONS AND PLANS, EXCEPT WHERE EXCEEDED HEREIN.

4. ALL MATTERS OF COLOR, TEXTURE, DESIGN AND INTERPRETATION OF PLANS SHALL BE REFERRED BY THE CONTRACTOR TO THE DESIGNER, IN THE EVENT SUCH MATTERS ARE NOT ADEQUATELY COVERED IN PLANS.

DRAWINGS ARE NOT TO BE SCALED. DIMENSIONAL DISCREPANCIES ARE TO BE CALLED TO THE ATTENTION OF THE DESIGNER.

3. NUMERICAL DIMENSIONS SHALL TAKE PRIORITY OVER SCALED.

THE CONTRACTOR SHALL FURNISH WATER, SEWER. GAS AND ELECTRIC SERVICE TO MEET THE REQUIREMENTS OF THE CONTRACT DOCUMENTS, OR AS NECESSARY TO COMPLETE THE

3. THE CONTRACTOR SHALL VERIFY LOCATION OF AFFECTED EXISTING MECHANICAL DUCTS AND ELECTRICAL SYSTEMS.

). ALL SUBSTITUTIONS OF PRODUCTS SPECIFIED OR DEVIATIONS TO THE DRAWINGS OR SPECIFICATIONS MUST BE SUBMITTED TO THE DESIGNER FOR APPROVAL.

10. VERIFY EXACT LOCATION OF CEILING ACCESS PANELS WITH MECHANICAL CONTRACTOR. PROVIDE ACCESS PANELS WHERE REQUIRED.

11. PATCHING AND REPAIR SHALL BE PERFORMED TO CREATE A CONTINUOUS AND UNIFORM SURFACE WHERE REQUIRED.

12. CEILING HEIGHTS SHOWN ON REFLECTED CEILING PLANS ARE FROM FINISH FLOOR TO FINISH CEILING.

13. PROVIDE DRYWALL SCREED OR PLASTER GROUND ON ALL END WALL CONDITIONS AND MAINTAIN SEPARATION FROM NON-COMPATIBLE MATERIAL. INFORM DESIGNER IMMEDIATELY

14. EXCEPT AS OTHERWISE NOTED ON THE DRAWINGS, PARTITIONS SHALL BE 2X4 WOOD STUDS AT 16" O.C. WITH SILL AND PLATES AS SHOWN IN THE APPLICABLE DETAILS, OR AS

17. FIRE EXTINGUISHERS (WHEN REQUIRED) SHALL BE RECESSED IN LOCATIONS APPROVED BY THE CITY OF BURBANK FIRE DEPARTMENT. ONLY APPROVED TYPE FIRE EXTINGUISHERS

18. CONTRACTOR WARRANTS THAT ALL WORK AND MATERIALS SHALL CONFORM TO THE THE DESIGNER IN WRITING WITH THREE COPIES OF LITERATURE AND SPECIFICATIONS AND

19. IF THE CONTRACTOR ENCOUNTERS ASBESTOS OR OTHER TOXIC MATERIALS, THE WORK SHALL IMMEDIATELY CEASE AND THE OWNER AND DESIGNER SHALL BE INFORMED OF THE

O. LEVERS AND LOCKSETS (ALL HARWARE) SHALL MEET CITY OF BURBANK SECURIT REQUIREMENTS AND SELECTED BY OWNER AND HAVE DESIGNER APPROVAL PRIOR TO


21. PROVIDE APPROVED FIRE DAMPERS FOR ALL DUCTS PENETRATING FIRE RATED WALLS

24. ALL LIGHT FIXTURES SHALL BE LOCATED EXACTLY AS INDICATED ON CEILING PLANS


28. TEMPORARY TOILET FACILITIES TO BE PROVIDED BY G.C. PER CITY OF BURBANK MUNICIPAL CODE.


29. THERE SHALL BE NO TRENCHES OR EXCAVATION 5' OR MORE IN DEPTH INTO WHICH A PERSON IS REQUIRED TO DESCEND OR OBTAIN NECESSARY PERMIT FROM THE STATE OF CALIFORNIA, DIVISION OF INDUSTRIAL SAFETY PRIOR TO THE ISSUANCE OF A BUILDING OR GRADING PERMIT.


30. THE CONSTRUCTION OR DEMOLITION OF ANY BUILDING STRUCTURE, SCAFFOLDING OR FASWARK MORE THAN 3 STORIES OR 36' IN HEIGHT REQUIRES A PERMIT FROM THE STATE OF CALIFORNIA DIVISION OF INDUSTRIAL SAFETY PRIOR TO THE ISSUANCE OF A BUILDING PERMIT.

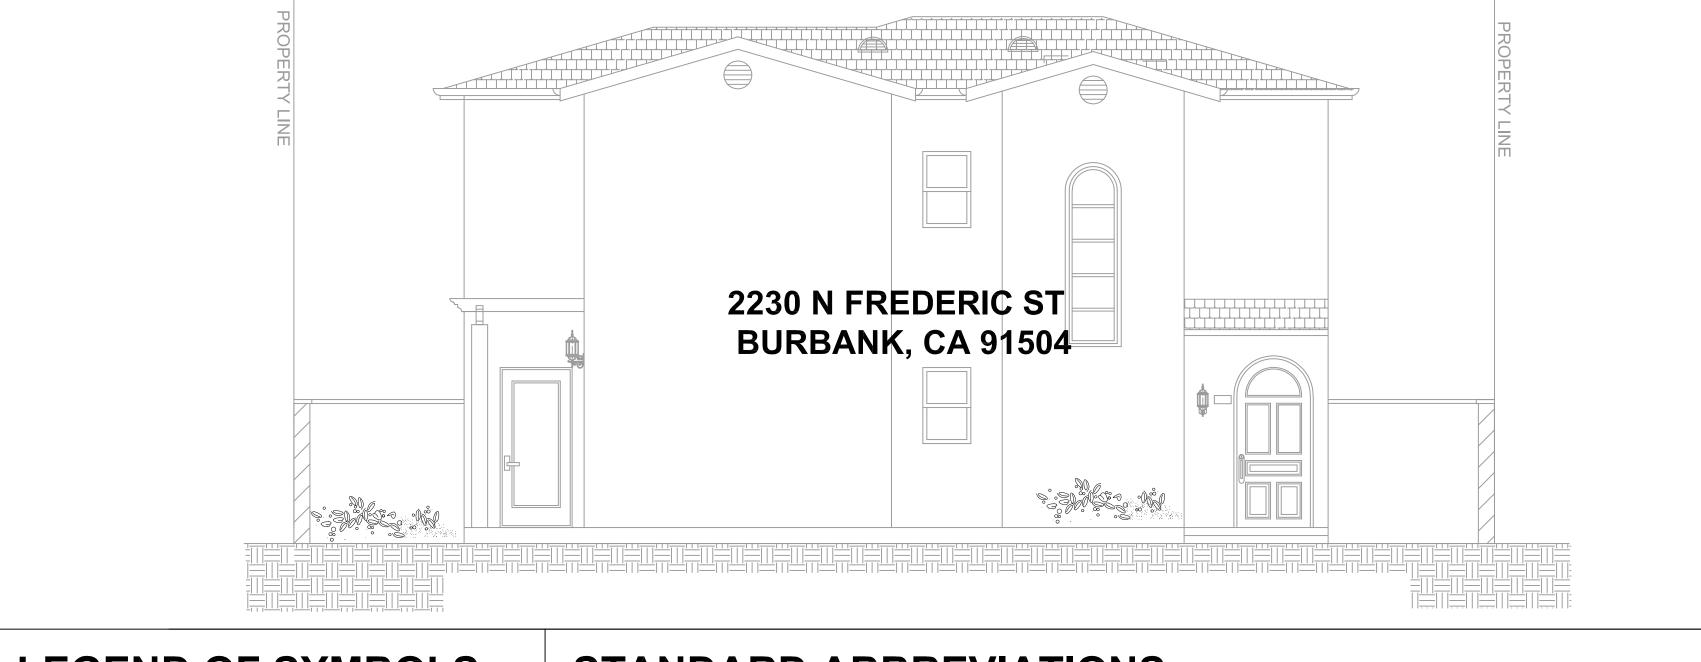


LEGEND OF SYMBOLS STANDARD ABBREVIATIONS EXTR. EXTRUDED P. LAM. PLASTIC LAMINATE F.D. FLOOR DRAIN PAPER BACKED LATH ANCHOR BOLT A.B. NORTH ARROW P.T. PART'N. PRESSURE TREATED PARTITION A.D. FDN. FOUNDATION AREA DRAIN ADDN'L. ADDITIONAL FIN. FINISH PLAST. PLASTER ADJ. **ADJACENT** FLOOR PLYWOOD PLY. **PLYWOOD** A.F.F. ABOVE FINISH FLOOR FLASHING FLASH'G. PAIR SECTION ALUM. ALUMINUM FACE OF CONCRETE PARAPET PRPT. APPROX. F.O.F. APPROXIMATELY FACE OF FINISH GYPSUM WALLBOARD PTD. PAINTED ARCH. ARCHITECT F.O.M. FACE OF MASONRY R.O. ROUGH OPENING A.S. ASPHALTIC CONCRETE F.O.S FACE OF STUD RADIUS ASSY. ASSEMBLY FRM'G. FRAMING R.C.P REFLECTED CEILING PLAN GRID LINE CONCRETE B.O. BOTTOM OF FOOT / FEET ROOF DRAIN BD. FTG. BOARD FOOTING BIT. BITUMEN(OUS) REF. REFERENCE GAUGE BLDG. GALV. REINF. REINFORCEMENT BUILDING GALVANIZED MATCH LINE REQ'D. RF'G. REQUIRED BLKG. BLOCKING GYP. GYPSUM BM. HOSE BIBB ROOFING CAB. CABINET RM. ROOM HOLLOW CORE BATT INSULATION S.B. SANDBLASTED ELEVATION C.B. CATCH BASIN HOLLOW METAL S.D. STORM DRAIN CERAMIC TILE HDR. HEADER S.C. SOLID CORE CEM. CEMENT HORIZ. HORIZONTAL → DIRECTION OF SLOPE S.S. CENTER LINE STAINLESS STEEL HEIGHT ACOUSTICAL TILE SCHED SCHEDULE CLG. CEILING INSIDE DIAMETER SHT. CLR. CLEAR SHEET INFORMATION INSULATION SIM. COL. SIMILAR COLUMN INSUL. WOOD BLOCKING DRAWING NUMBER SPEC. **SPECIFICATION** COMPOSITION INSIDE OF FINISH WALL SPECIFIED CONC. CONCRETE SQUARE CONSTR. CONSTRUCTION CONT. WOOD BLOCKING STD. STANDARD CONT. CONTINUOUS M.O. MASONRY OPENING STRUCT. STRUCTURAI CONTR. CONTRACTOR MAX. MAXIMUM INTERIOR ELEVATION SUSP. SUSPENDED CARPET MEMBER CTR. CENTER MECH. MECHANICAL TEMPERED CARPET SECTION T.O. DBL. DOUBLE MEMBRANE TOP OF MEMB. T.C.S. TERNE COATED STEEL D.F. DOUGLAS FIR MFR. MANUFACTURER (A)110 ROOM NUMBER -DETAIL NUMBER T.C.Z. TERNE COATED ZINC DIA. DIAMETER MIN. MINIMUM DIM. DIMENSION MISC. MISCELLANEOUS TEMP. DN. DR. THK. DOWN MTD. MOUNTED SHEET ON WHICH TYP. TYPICAL DOOR (120) STOREFRONT DETAIL OCCURS U.B.C. UNIFORM BUILDING CODE DOWNSPOU' NOT IN CONTRACT NOT TO SCALE U.O.N. UNLESS OTHERWISE NOTED N.T.S. DETAIL (AA)ROOM FINISH NOTE DWG. VERT. DRAWING NAT.. NATURAL DOOR VERTICAL GRAIN DOUGLAS FIR EACH NOM. NOMINAL (102)DOOR NUMBER WATER CLOSET ELEC. ELECTRICAI W/O WITHOUT ELEVATION ON CENTER WINDOW ENCL. OUTSIDE DIAMETER ENCLOSURE (102) ROOM NUMBER WITHIN EQ. 0.H. OVER HEAD EQUAL **EXISTING** WATER PROOF EXIST. OPEN'G. OPENING CENTERLINE **EXPANSION OPPOSITE** W.R. WATER RESISTANT EXP. OUTSIDE FACE OF FINISH WALL EXT. **EXTERIOR** O.S.F.W.

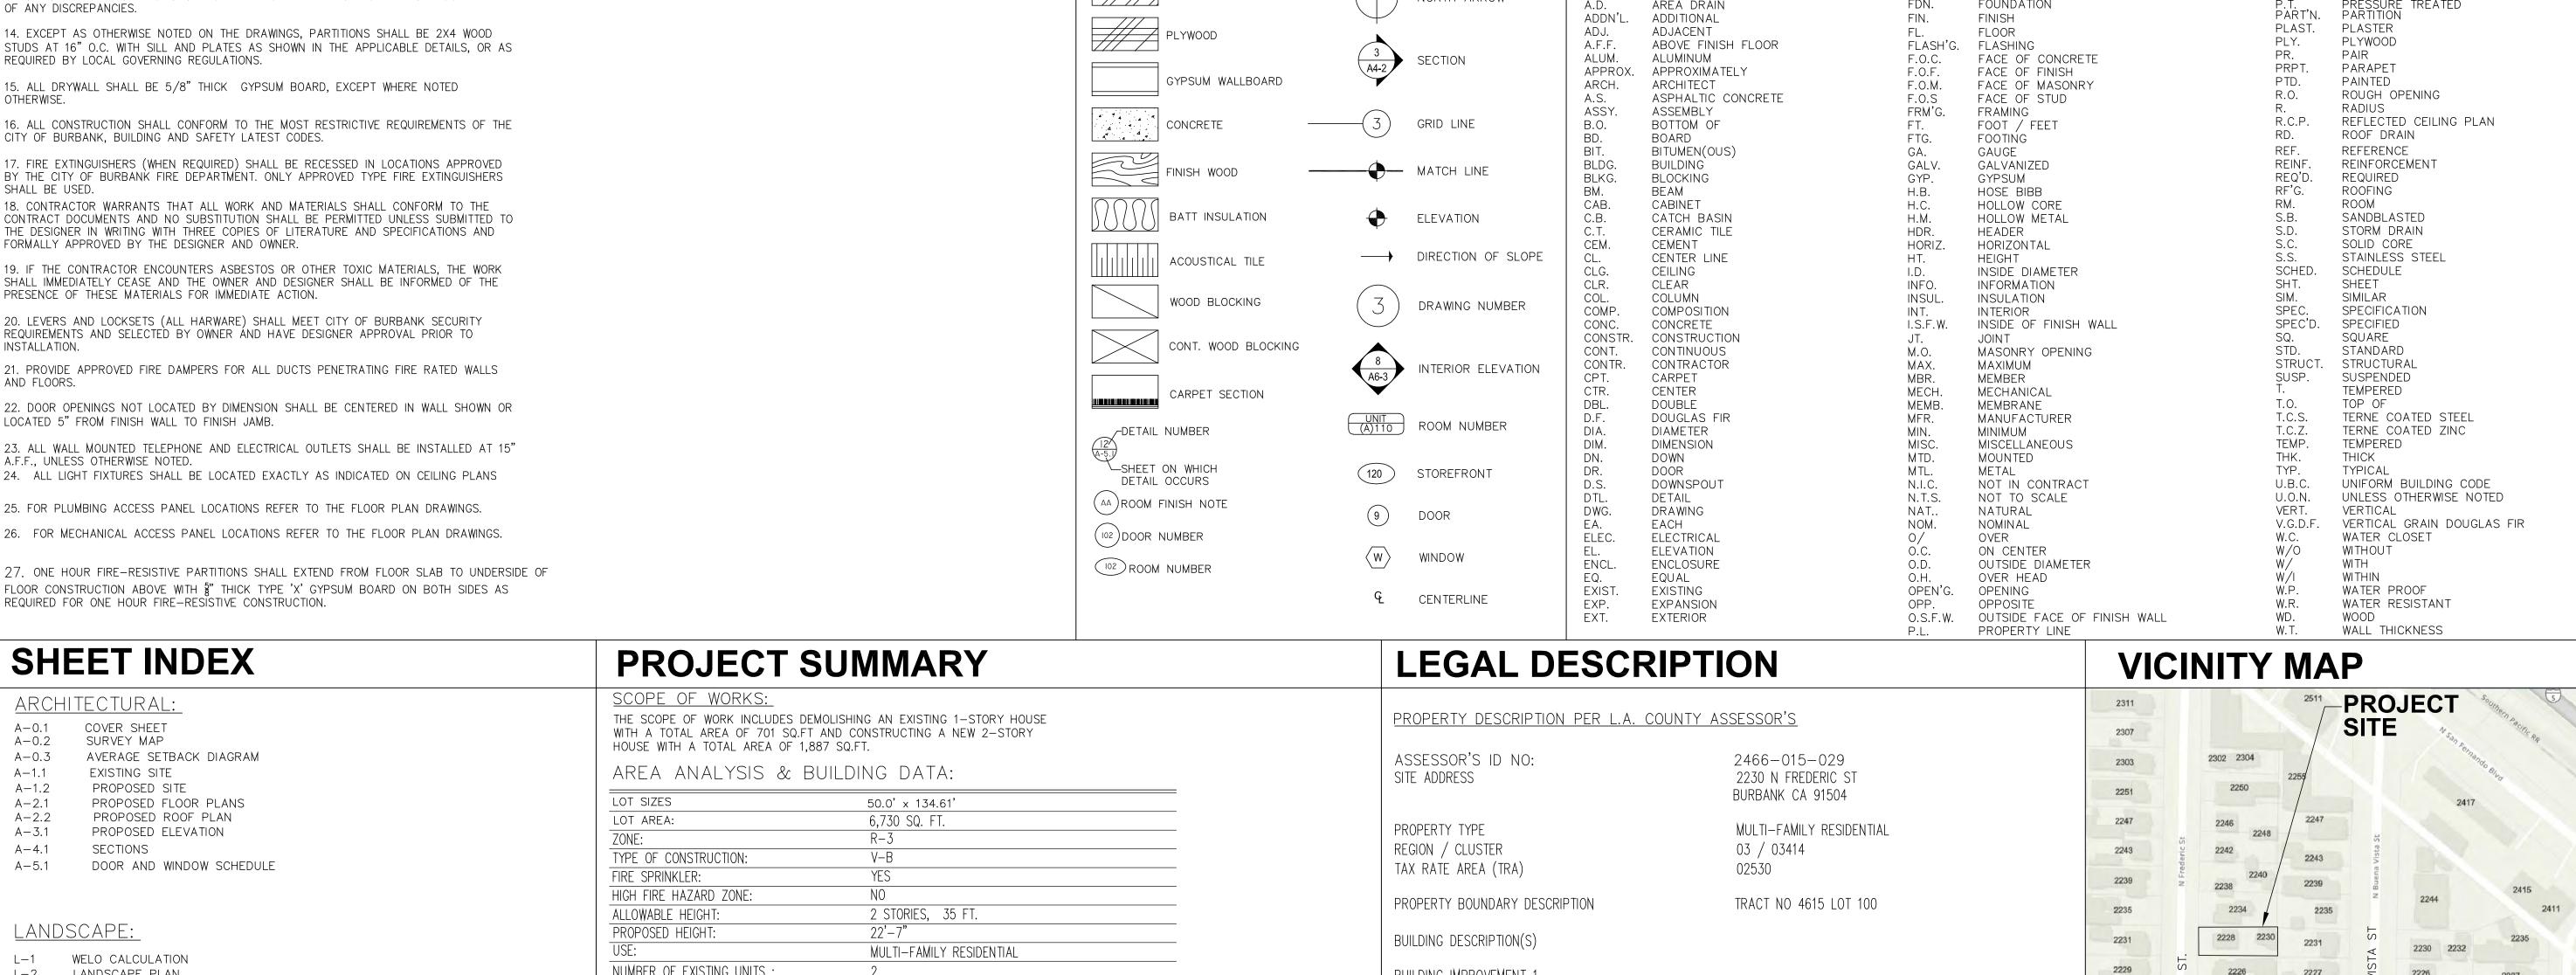

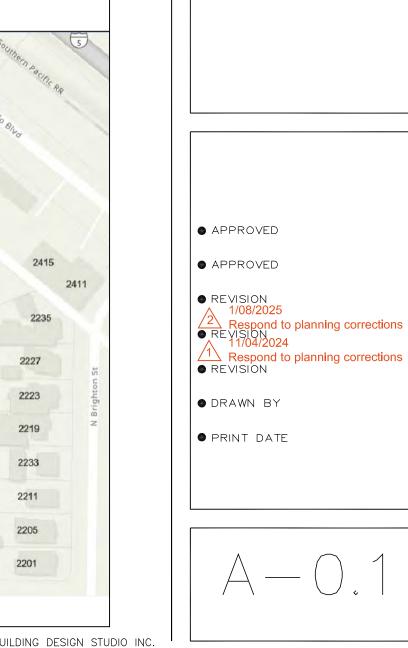

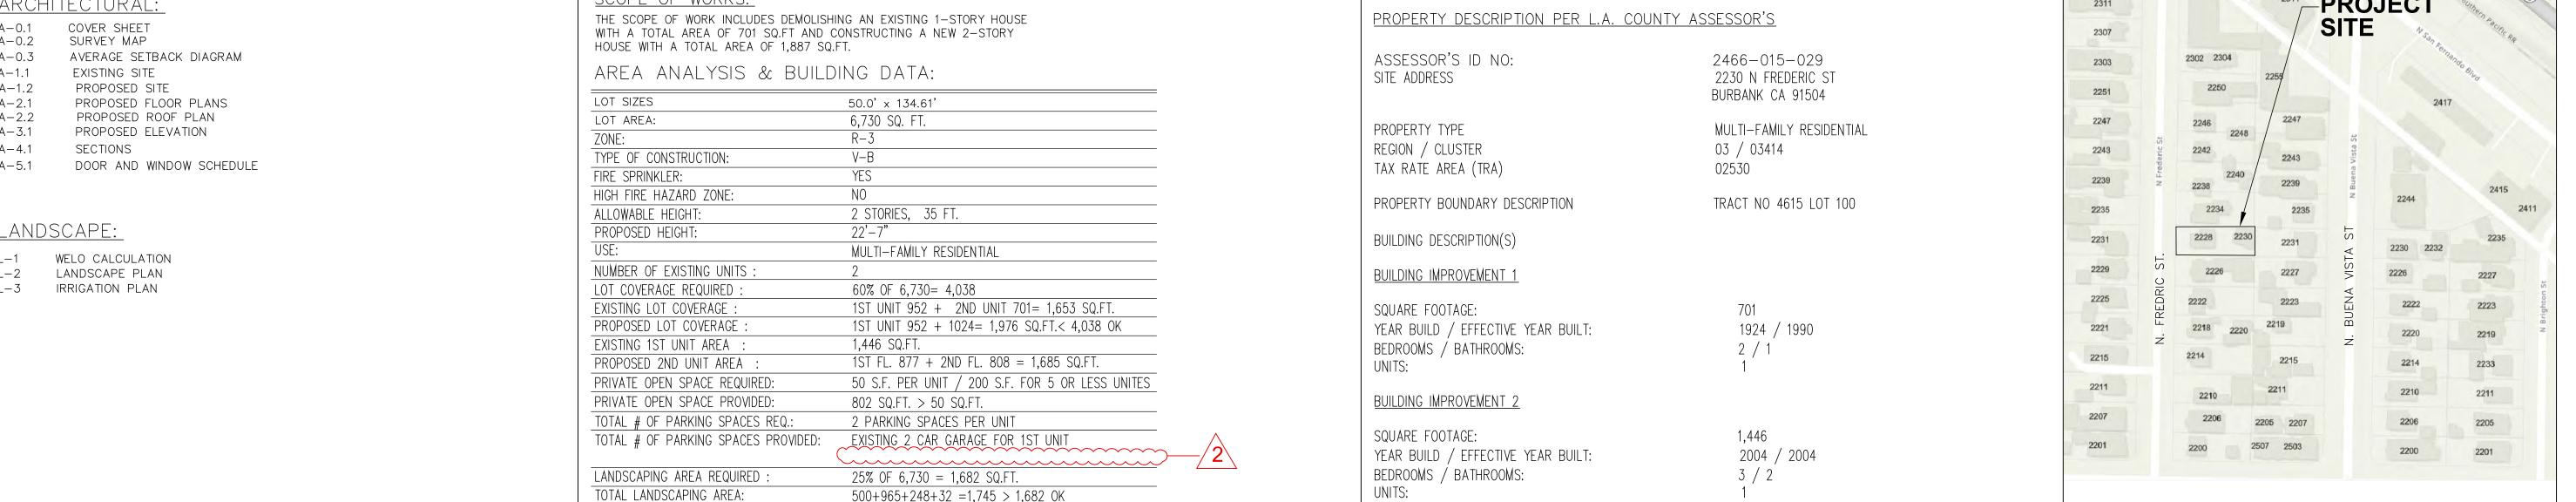

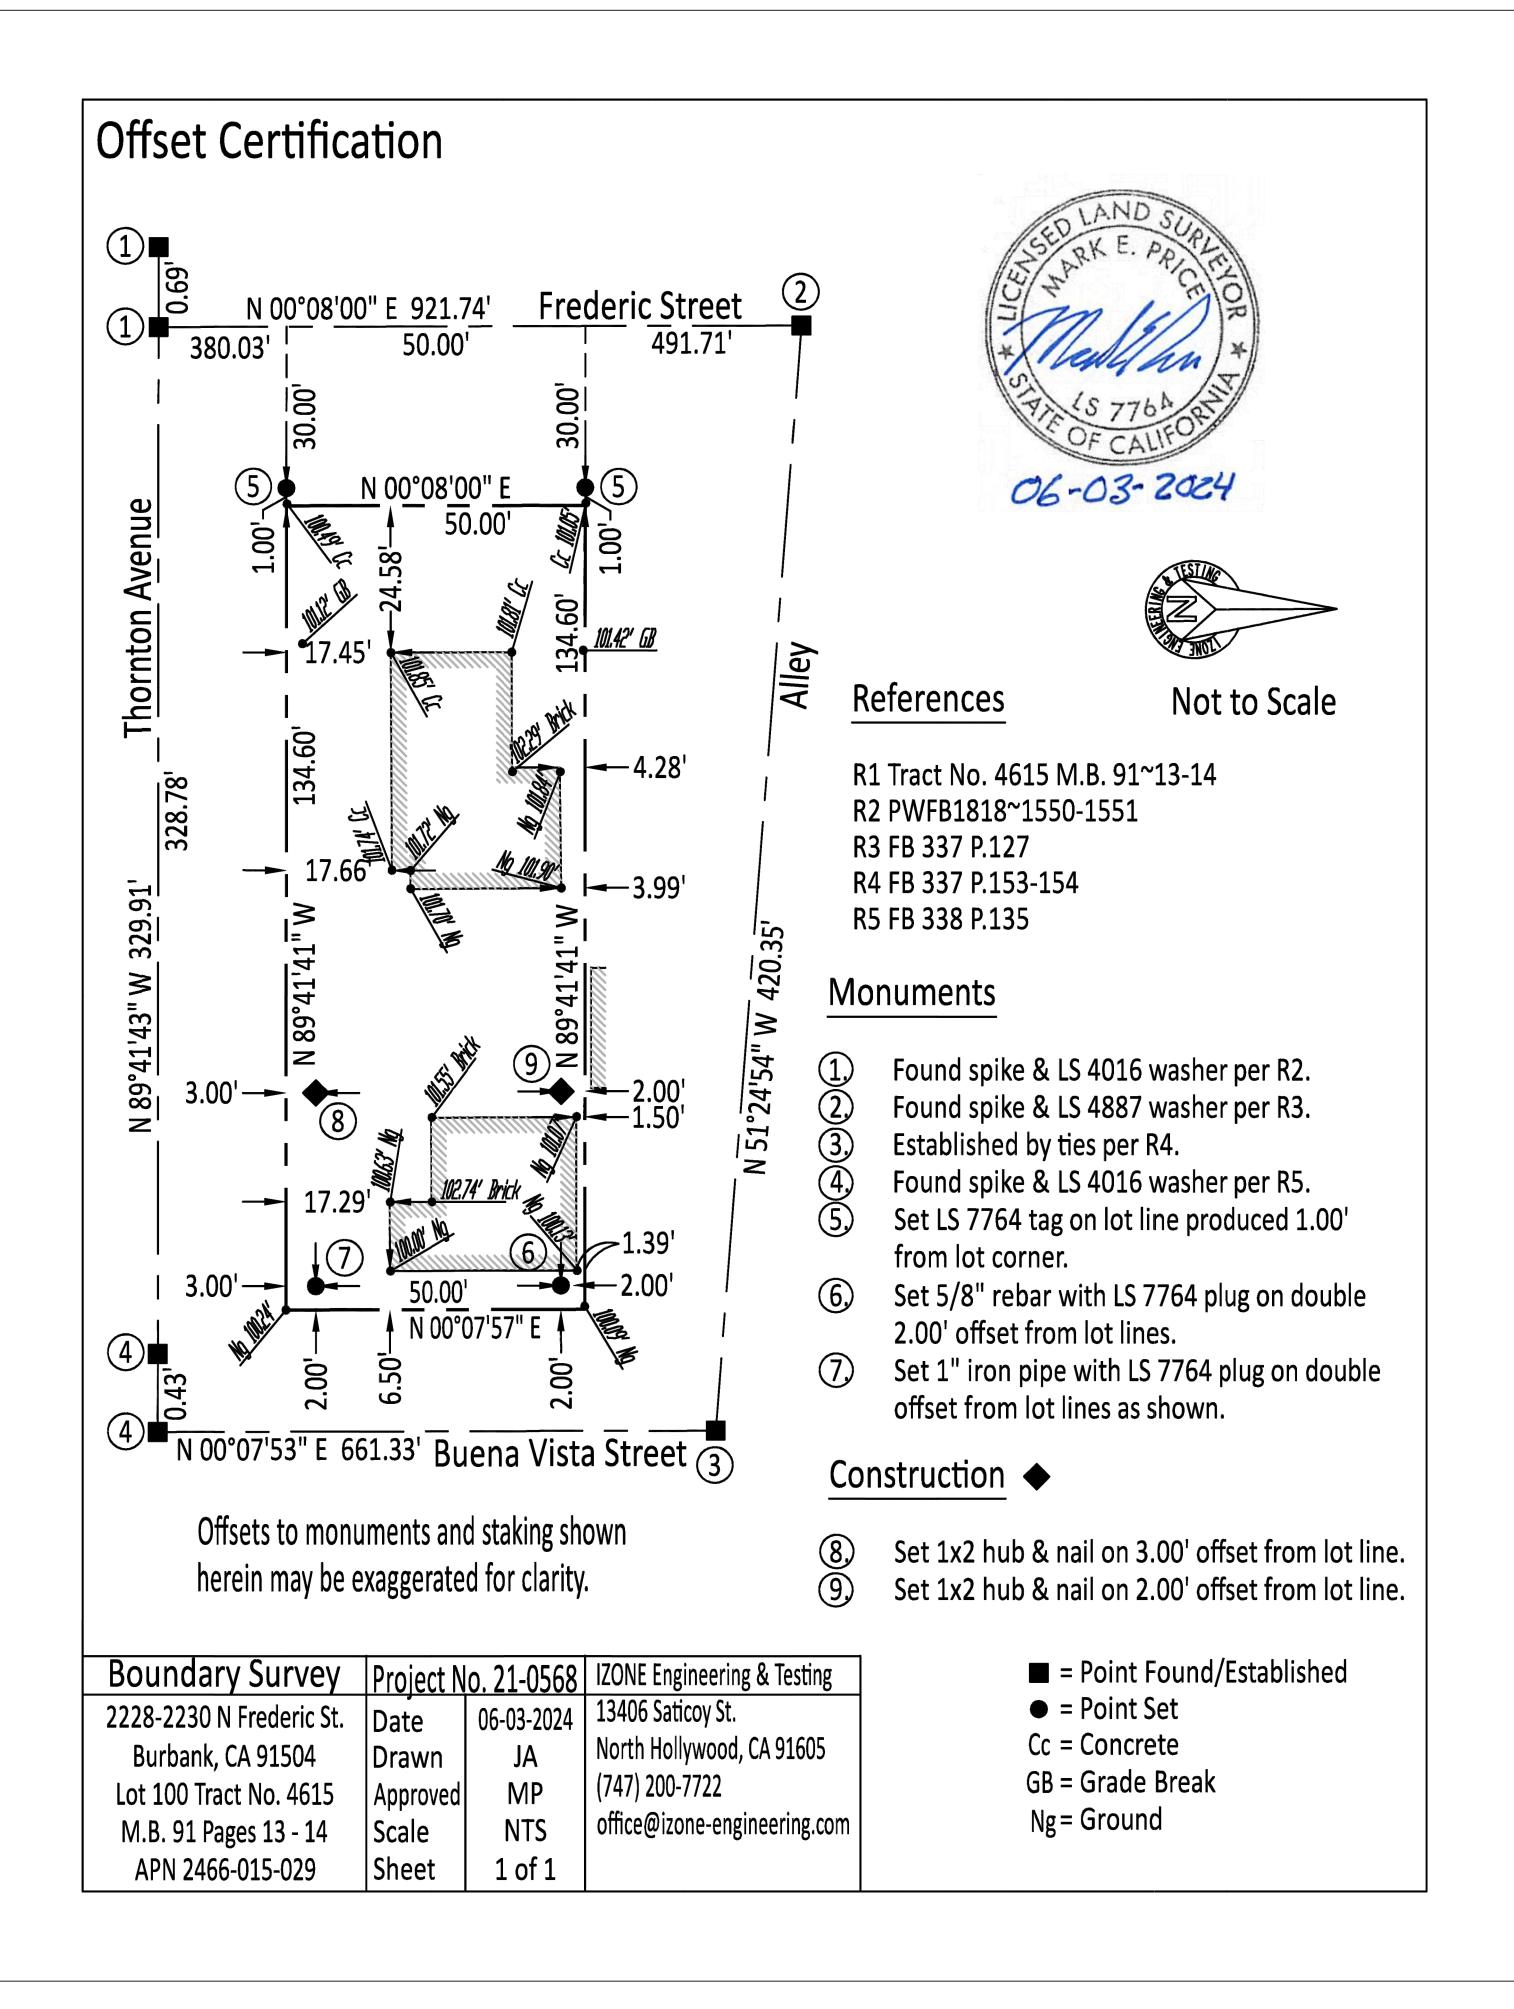

BUILDING DESIGN STUDIO

PARALLEL BUILDING DESIGN STUDIO INC.

P.O.BOX 1602 Glendale, CA 91209 Phone:(818)939-3201 Sevana@Parallelbd.com

WNER:

Mr.ROGER RANJBAR

PROJECT NAME:

PROJECT ADDRESS:

2230 N FREDERIC ST. BURBANK CA. 91504

SURVAY

Scale:

• APPROVED

• APPROVED

• REVISION

• REVISION

REVISIONDRAWN BY

PRINT DATE

PRINT DATE

PARALLEL BUILDING DESIGN STUDIO INC.

A-0.2

AVERAGE SETBACK:

PLAN BREAK OFFSET:


EAST 3' SOUTH 6'

EAST

SOUTH

NORTH 5'+9'-5"=14'-5"

SOUTH

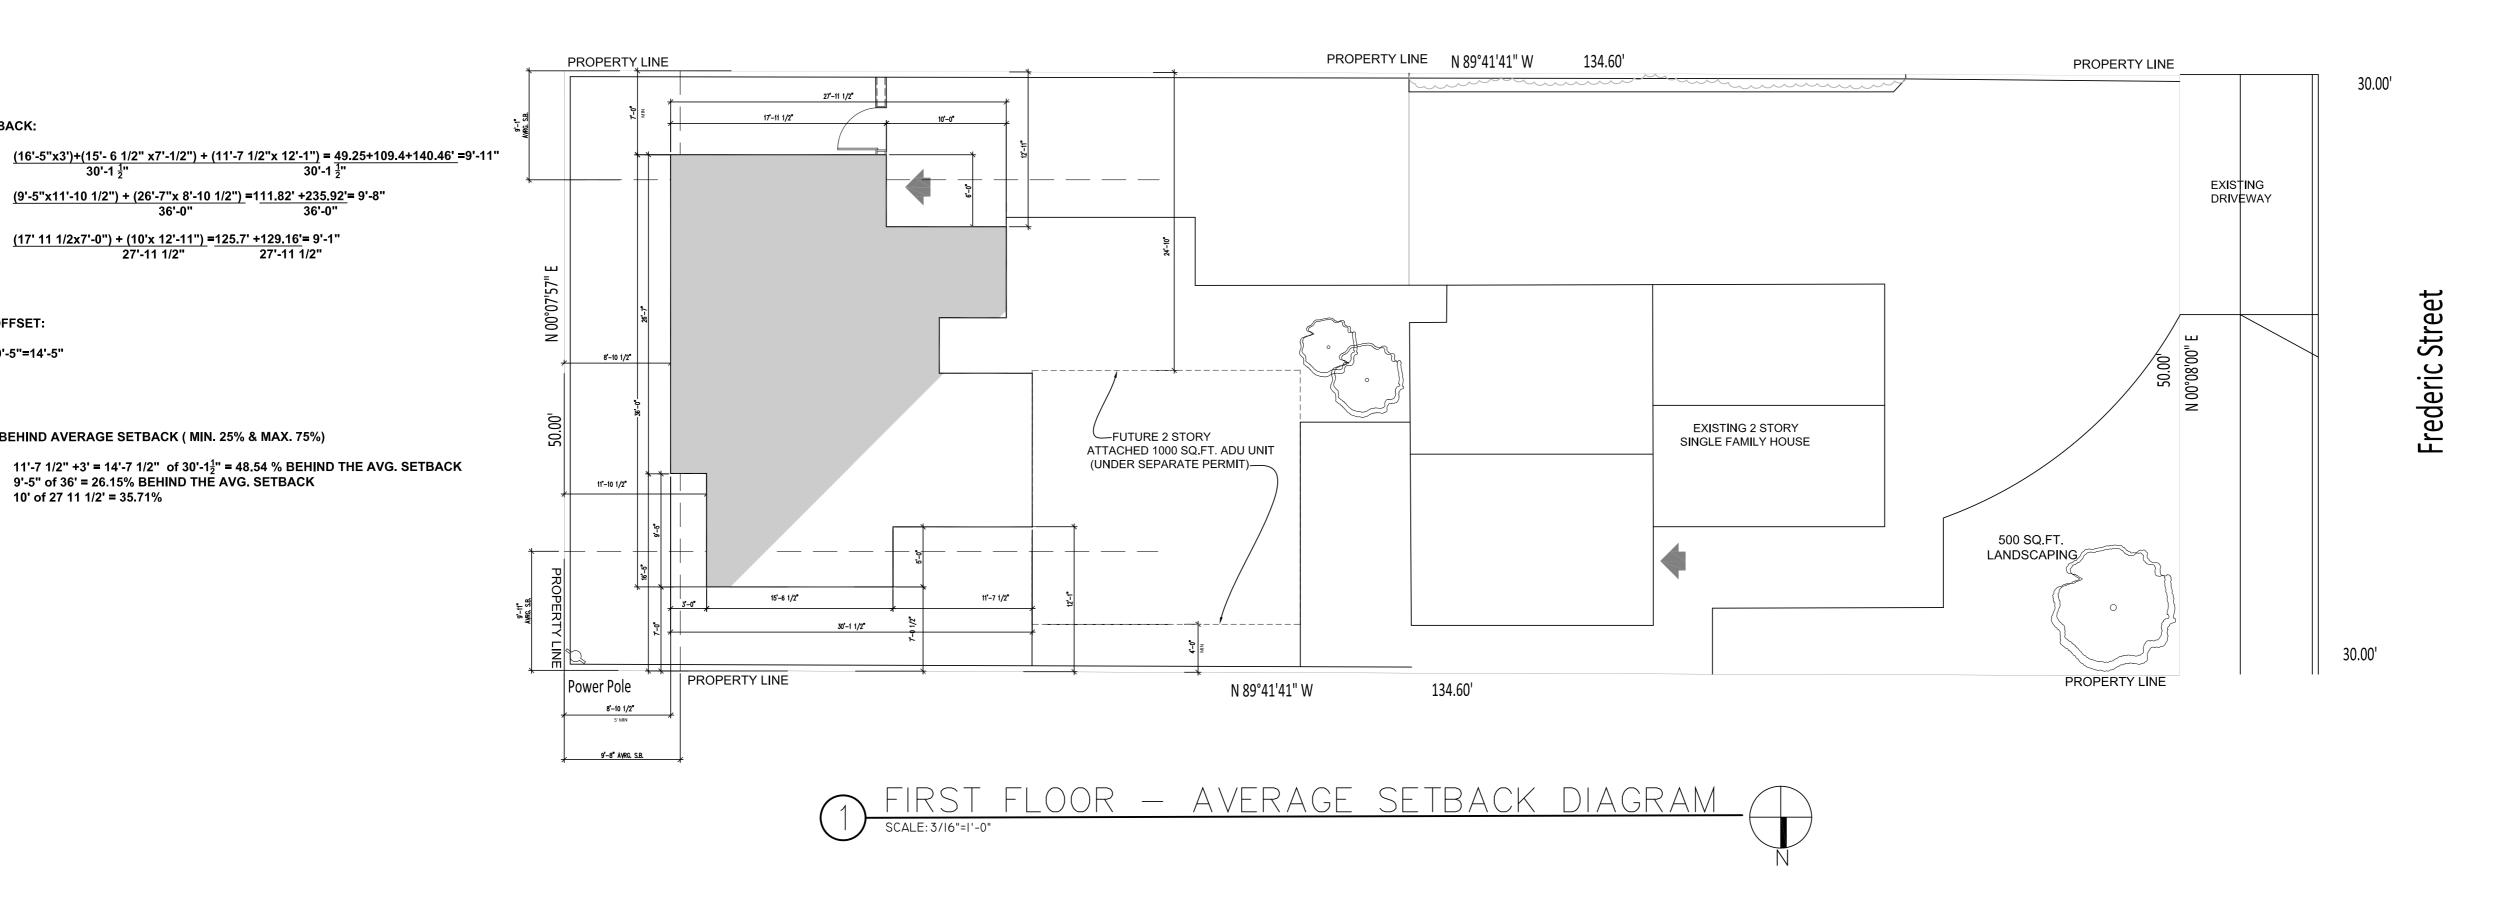

AVERAGE SETBACK:

 $\frac{(16'-5"x3')+(15'-6\ 1/2"\ x7'-1/2")+(11'-7\ 1/2"x\ 12'-1")}{30'-1\frac{1}{2}"}=\frac{49.25+109.4+140.46'}{30'-1\frac{1}{2}"}=9'-11"$

PROPERTY LINE

9'-8" AYRG. S.B.

(17' 11 1/2x7'-0") + (10'x 12'-11") = 125.7' +129.16'= 9'-1" 27'-11 1/2" = 27'-11 1/2"

PLAN LENGTH BEHIND AVERAGE SETBACK (MIN. 25% & MAX. 75%)

10' of 27 11 1/2' = 35.71%

(9'-5"x11'-10 1/2") + (26'-7"x 8'-10 1/2") = 111.82' +235.92' = 9'-8" 36'-0"

(17' 11 1/2x7'-0") + (10'x 12'-11") = 125.7' +129.16' = 9'-1" 27'-11 1/2" = 27'-11 1/2" SOUTH


PLAN BREAK OFFSET:

NORTH 5'+9'-5"=14'-5" EAST SOUTH 6'

PLAN LENGTH BEHIND AVERAGE SETBACK (MIN. 25% & MAX. 75%)

11'-7 1/2" +3' = 14'-7 1/2" of 30'-1 $\frac{1}{2}$ " = 48.54 % BEHIND THE AVG. SETBACK


EAST 9'-5" of 36' = 26.15% BEHIND THE AVG. SETBACK SOUTH 10' of 27 11 1/2' = 35.71%

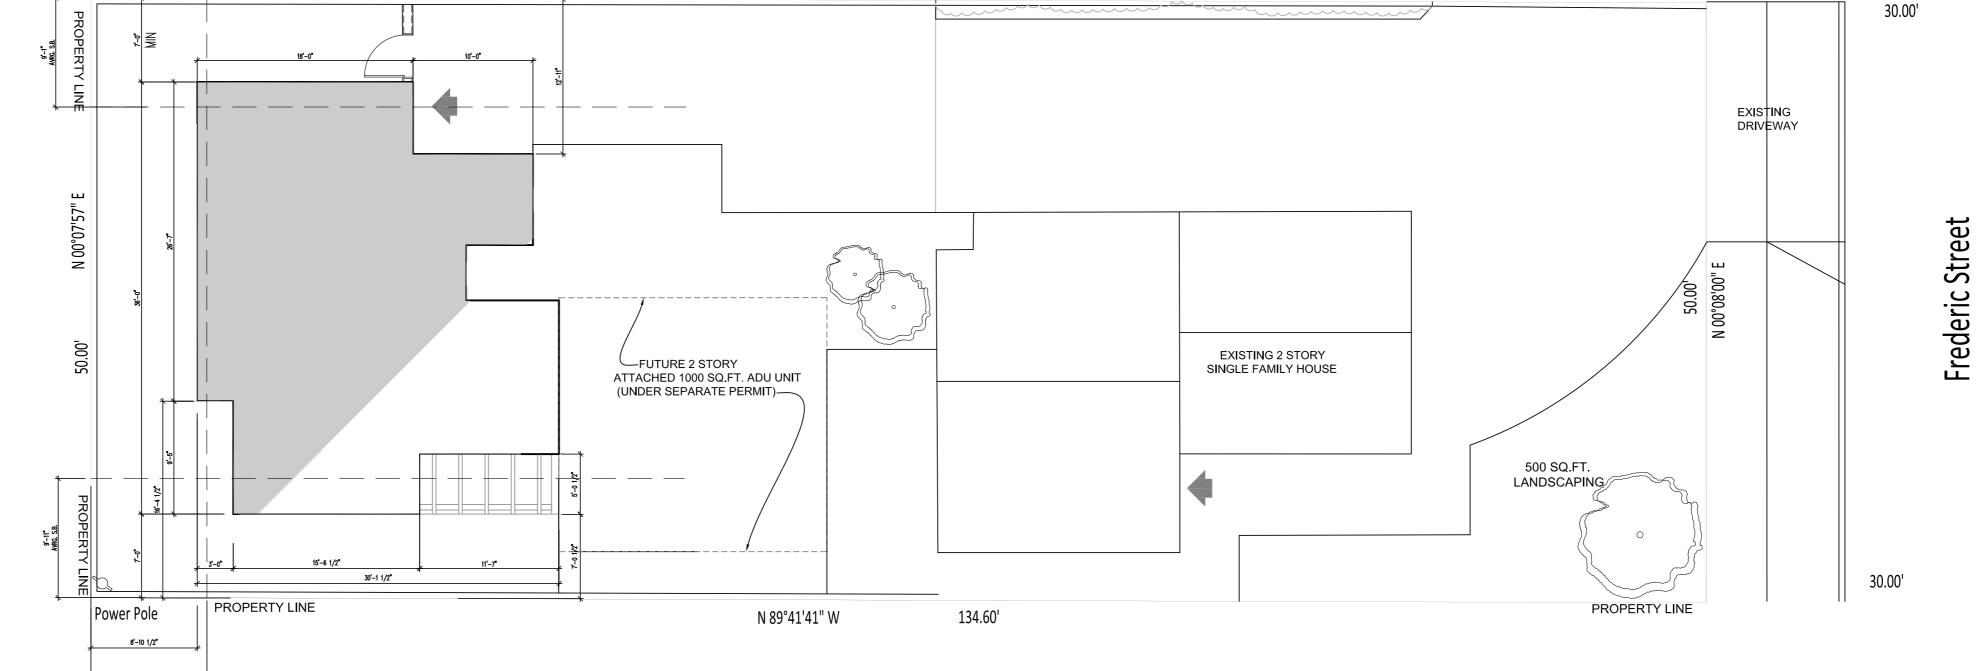

PROPERTY LINE N 89°41'41" W 134.60'

SECOND FLOOR - AVERAGE SETBACK DIAGRAM

SCALE: 3/16"=1'-0"

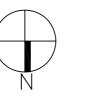

PROPERTY LINE

BUILDING DESIGN STUDIO

PARALLEL BUILDING DESIGN STUDIO INC.

P.O.BOX 1602 Glendale, CA 91209 Phone:(818)939-3201 Sevana@Parallelbd.com

Mr.ROGER RANJBAR

PROJECT NAME:

PROJECT ADDRESS: 2230 N FREDERIC ST.

BURBANK CA. 91504

AVERAGE

Scale: N/A


APPROVED • APPROVED

• REVISION 11/04/2024 Respond to planning corrections


REVISION

• REVISION ODRAWN BY

PRINT DATE

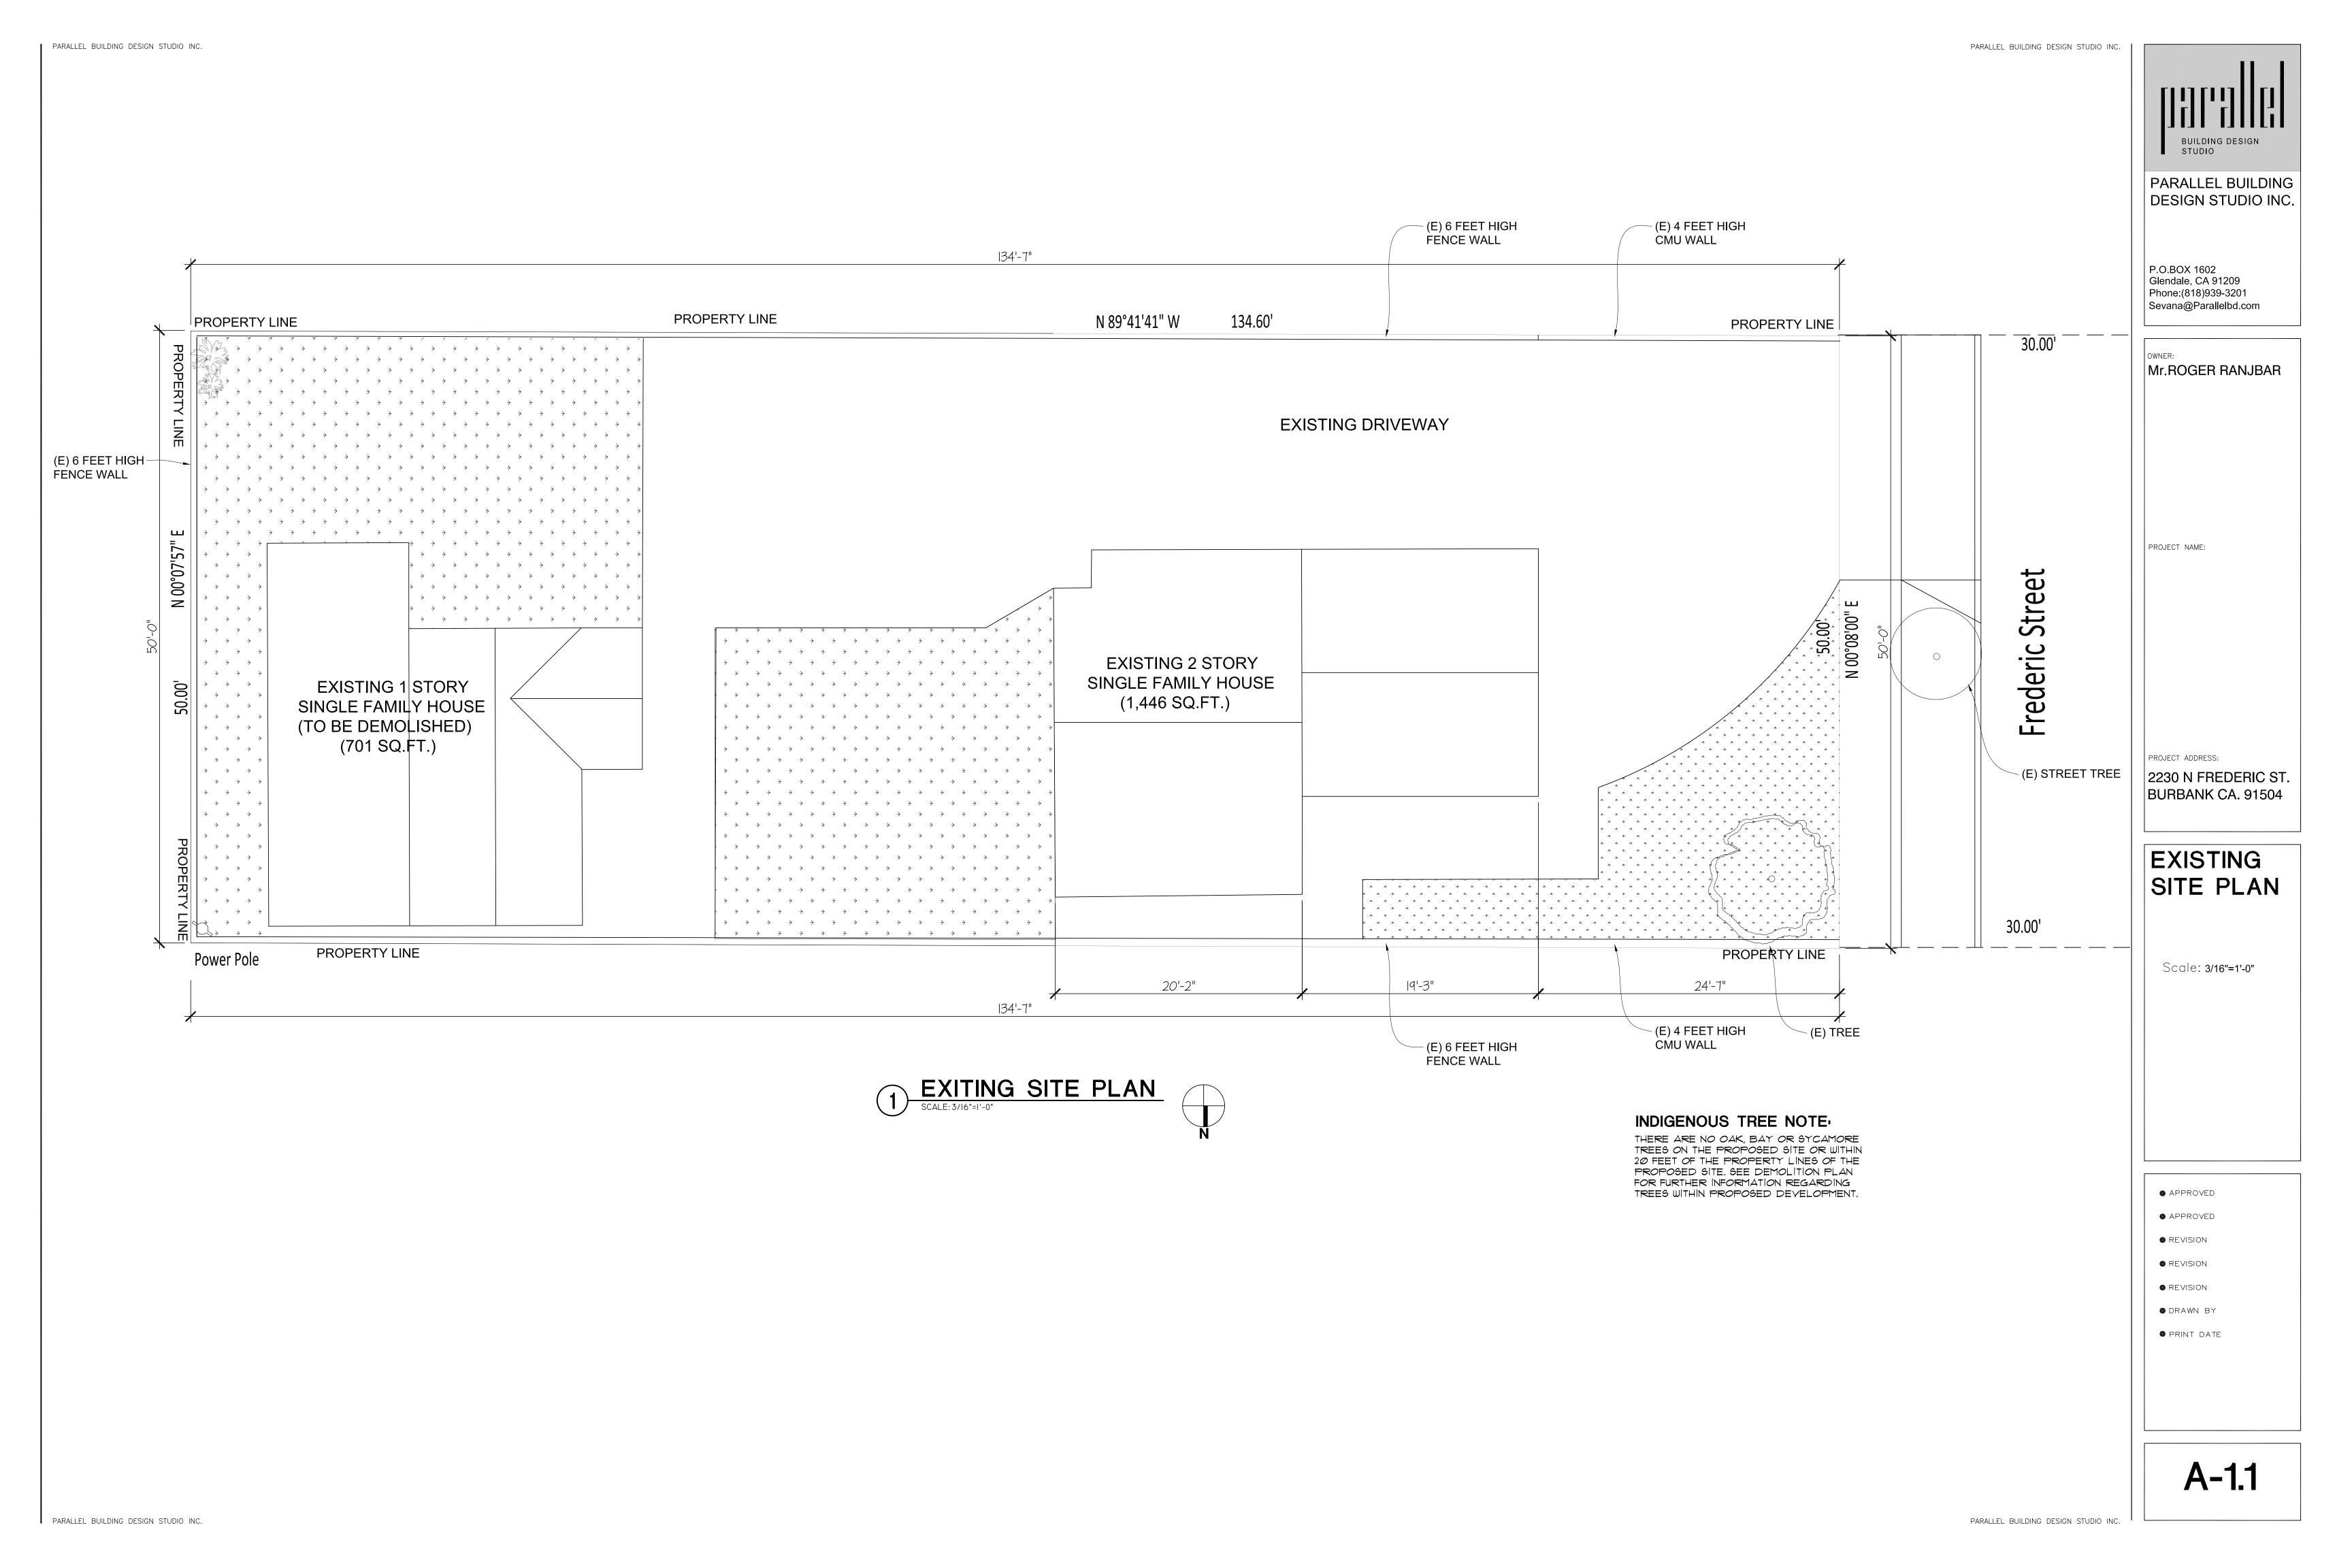

PARALLEL BUILDING DESIGN STUDIO INC. PARALLEL BUILDING DESIGN STUDIO INC.

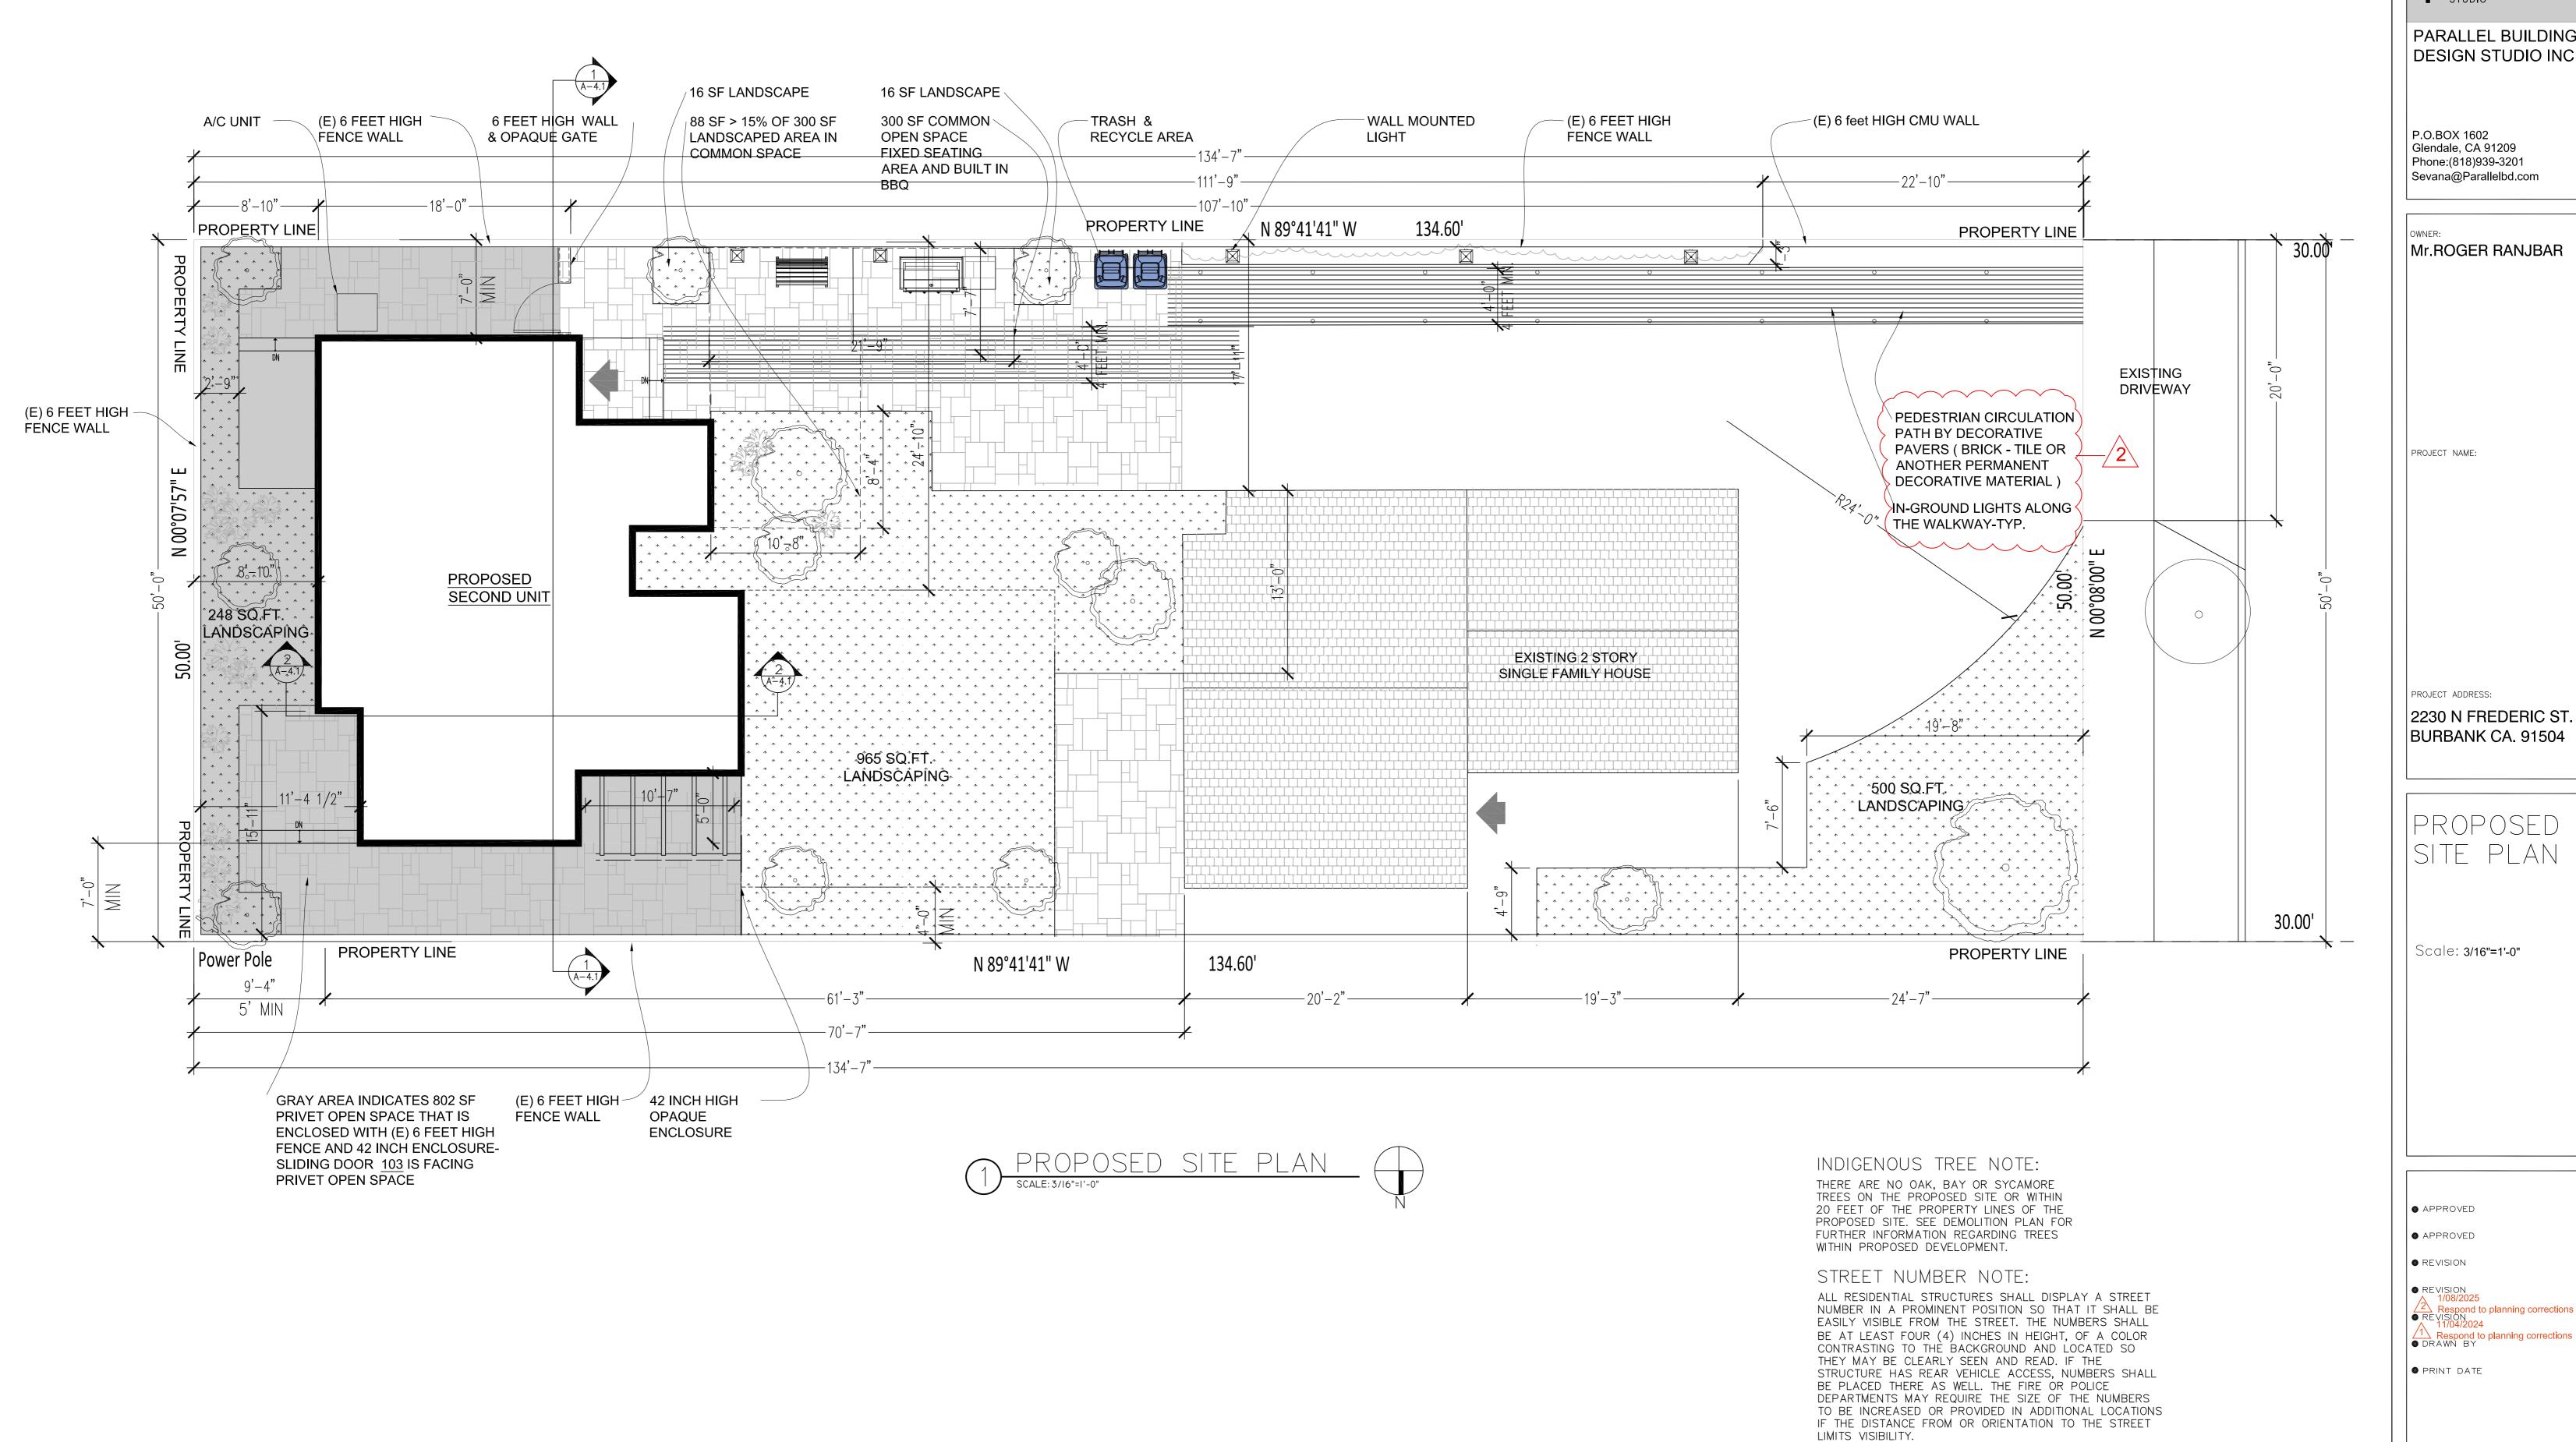

BUILDING DESIGN STUDIO

PARALLEL BUILDING DESIGN STUDIO INC.

P.O.BOX 1602 Glendale, CA 91209 Phone:(818)939-3201 Sevana@Parallelbd.com

Mr.ROGER RANJBAR

PROJECT ADDRESS:

| Scale: 3/16"=1'-0"

APPROVED

• APPROVED


• REVISION


● REVISION 1/08/2025 Respond to planning corrections
REVISION
11/04/2024

Respond to planning corrections

ORAWN BY

PRINT DATE

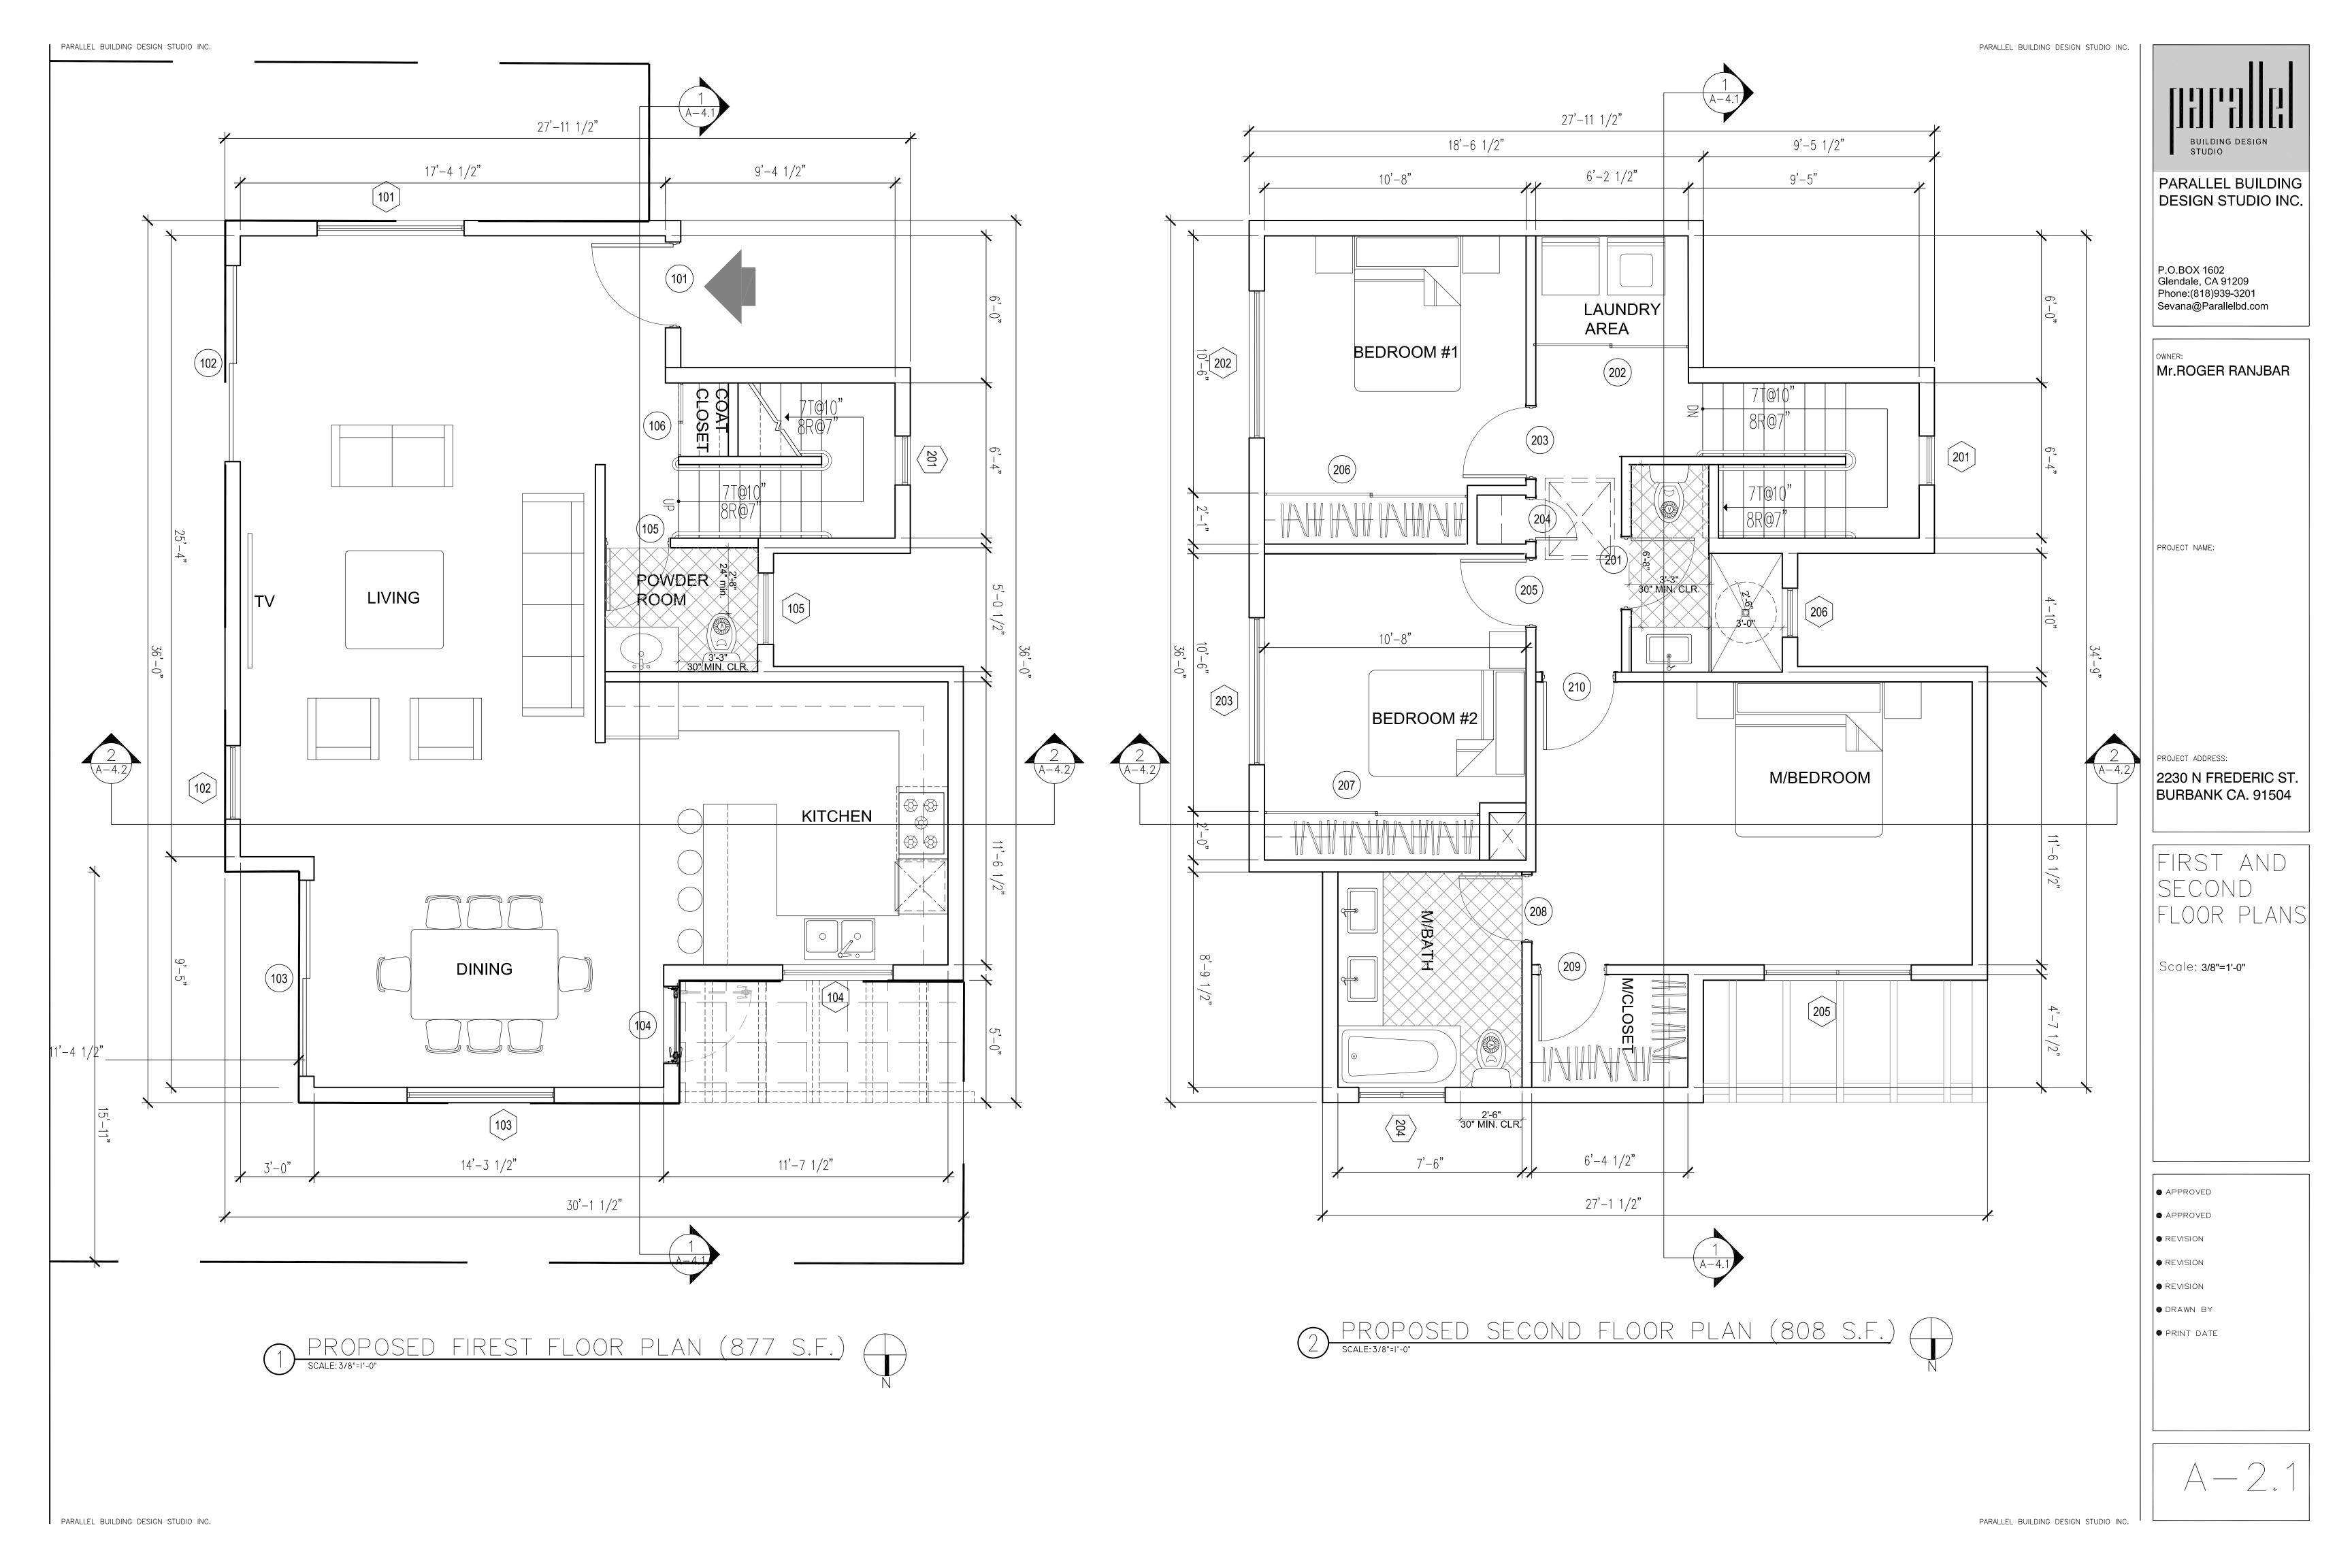

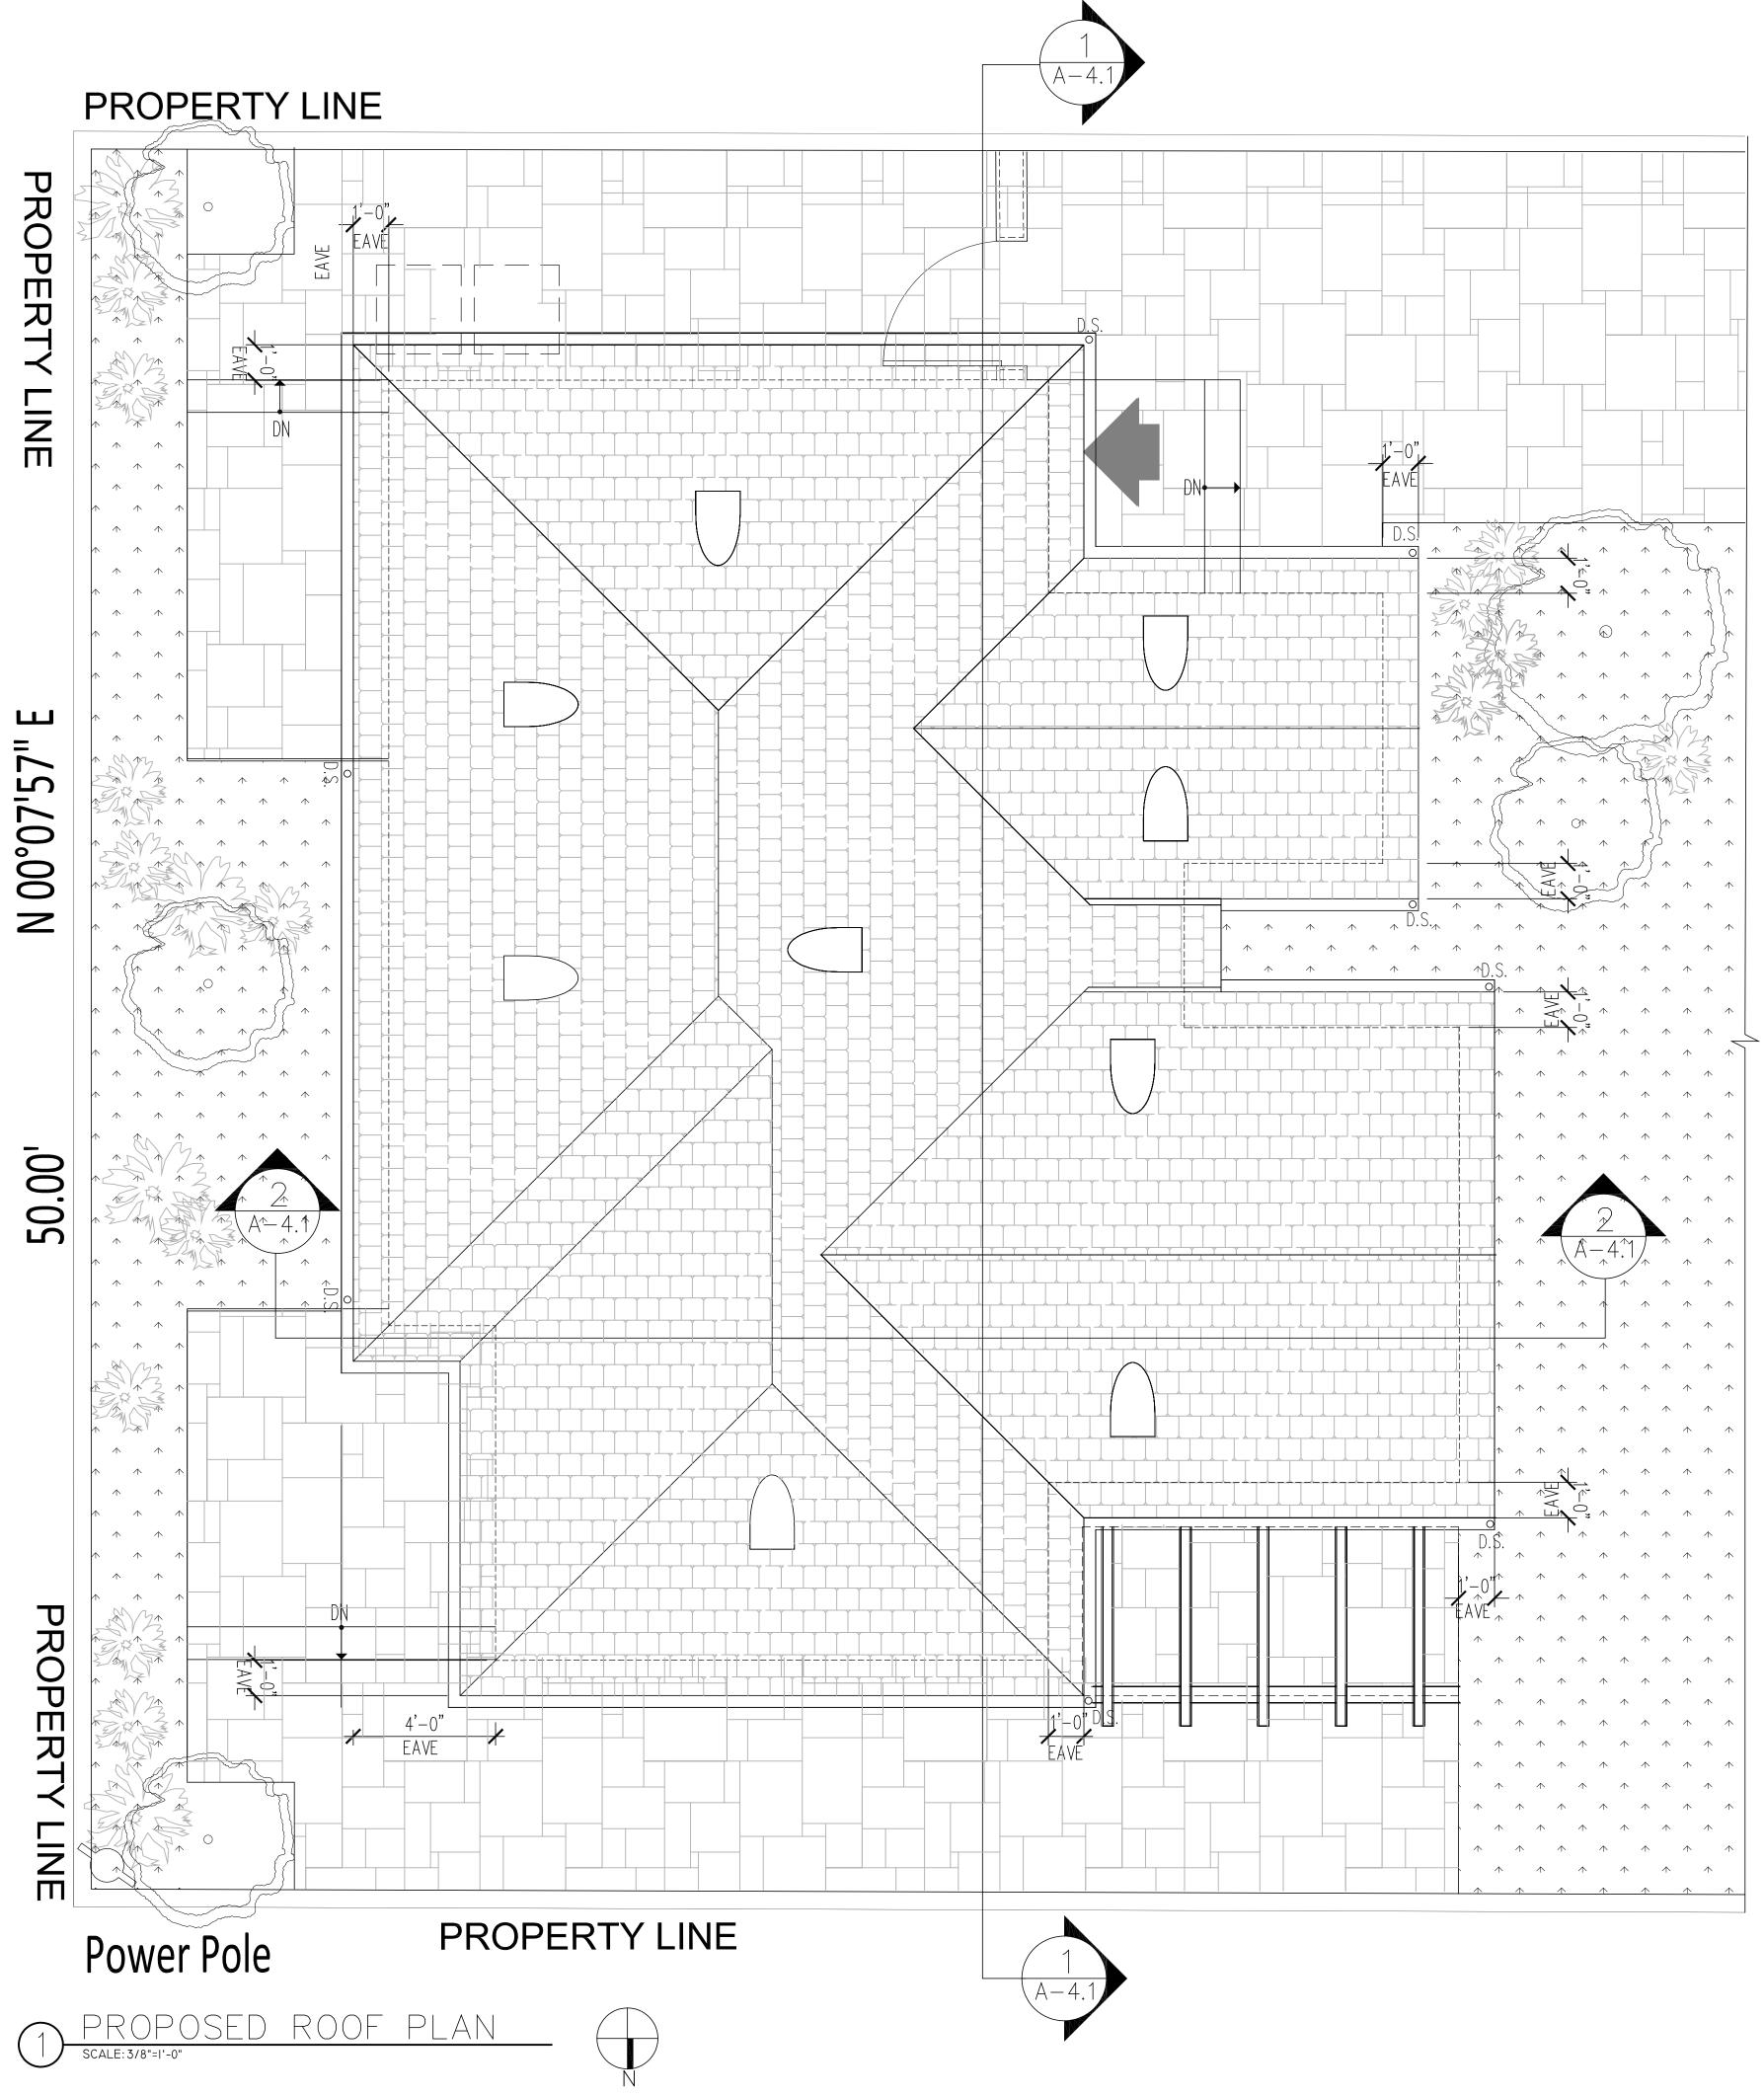

BUILDING DESIGN STUDIO

PARALLEL BUILDING DESIGN STUDIO INC.

P.O.BOX 1602 Glendale, CA 91209 Phone:(818)939-3201 Sevana@Parallelbd.com

NER:

Mr.ROGER RANJBAR

PROJECT NAME:

PROJECT ADDRESS:

2230 N FREDERIC ST. BURBANK CA. 91504

> ROPOSED ROOF PLAN

Scale: 3/8"=1'-0"

APPROVED

• APPROVED

REVISION


• REVISION

• REVISION

DRAWN BY

PRINT DATE

A-2.2

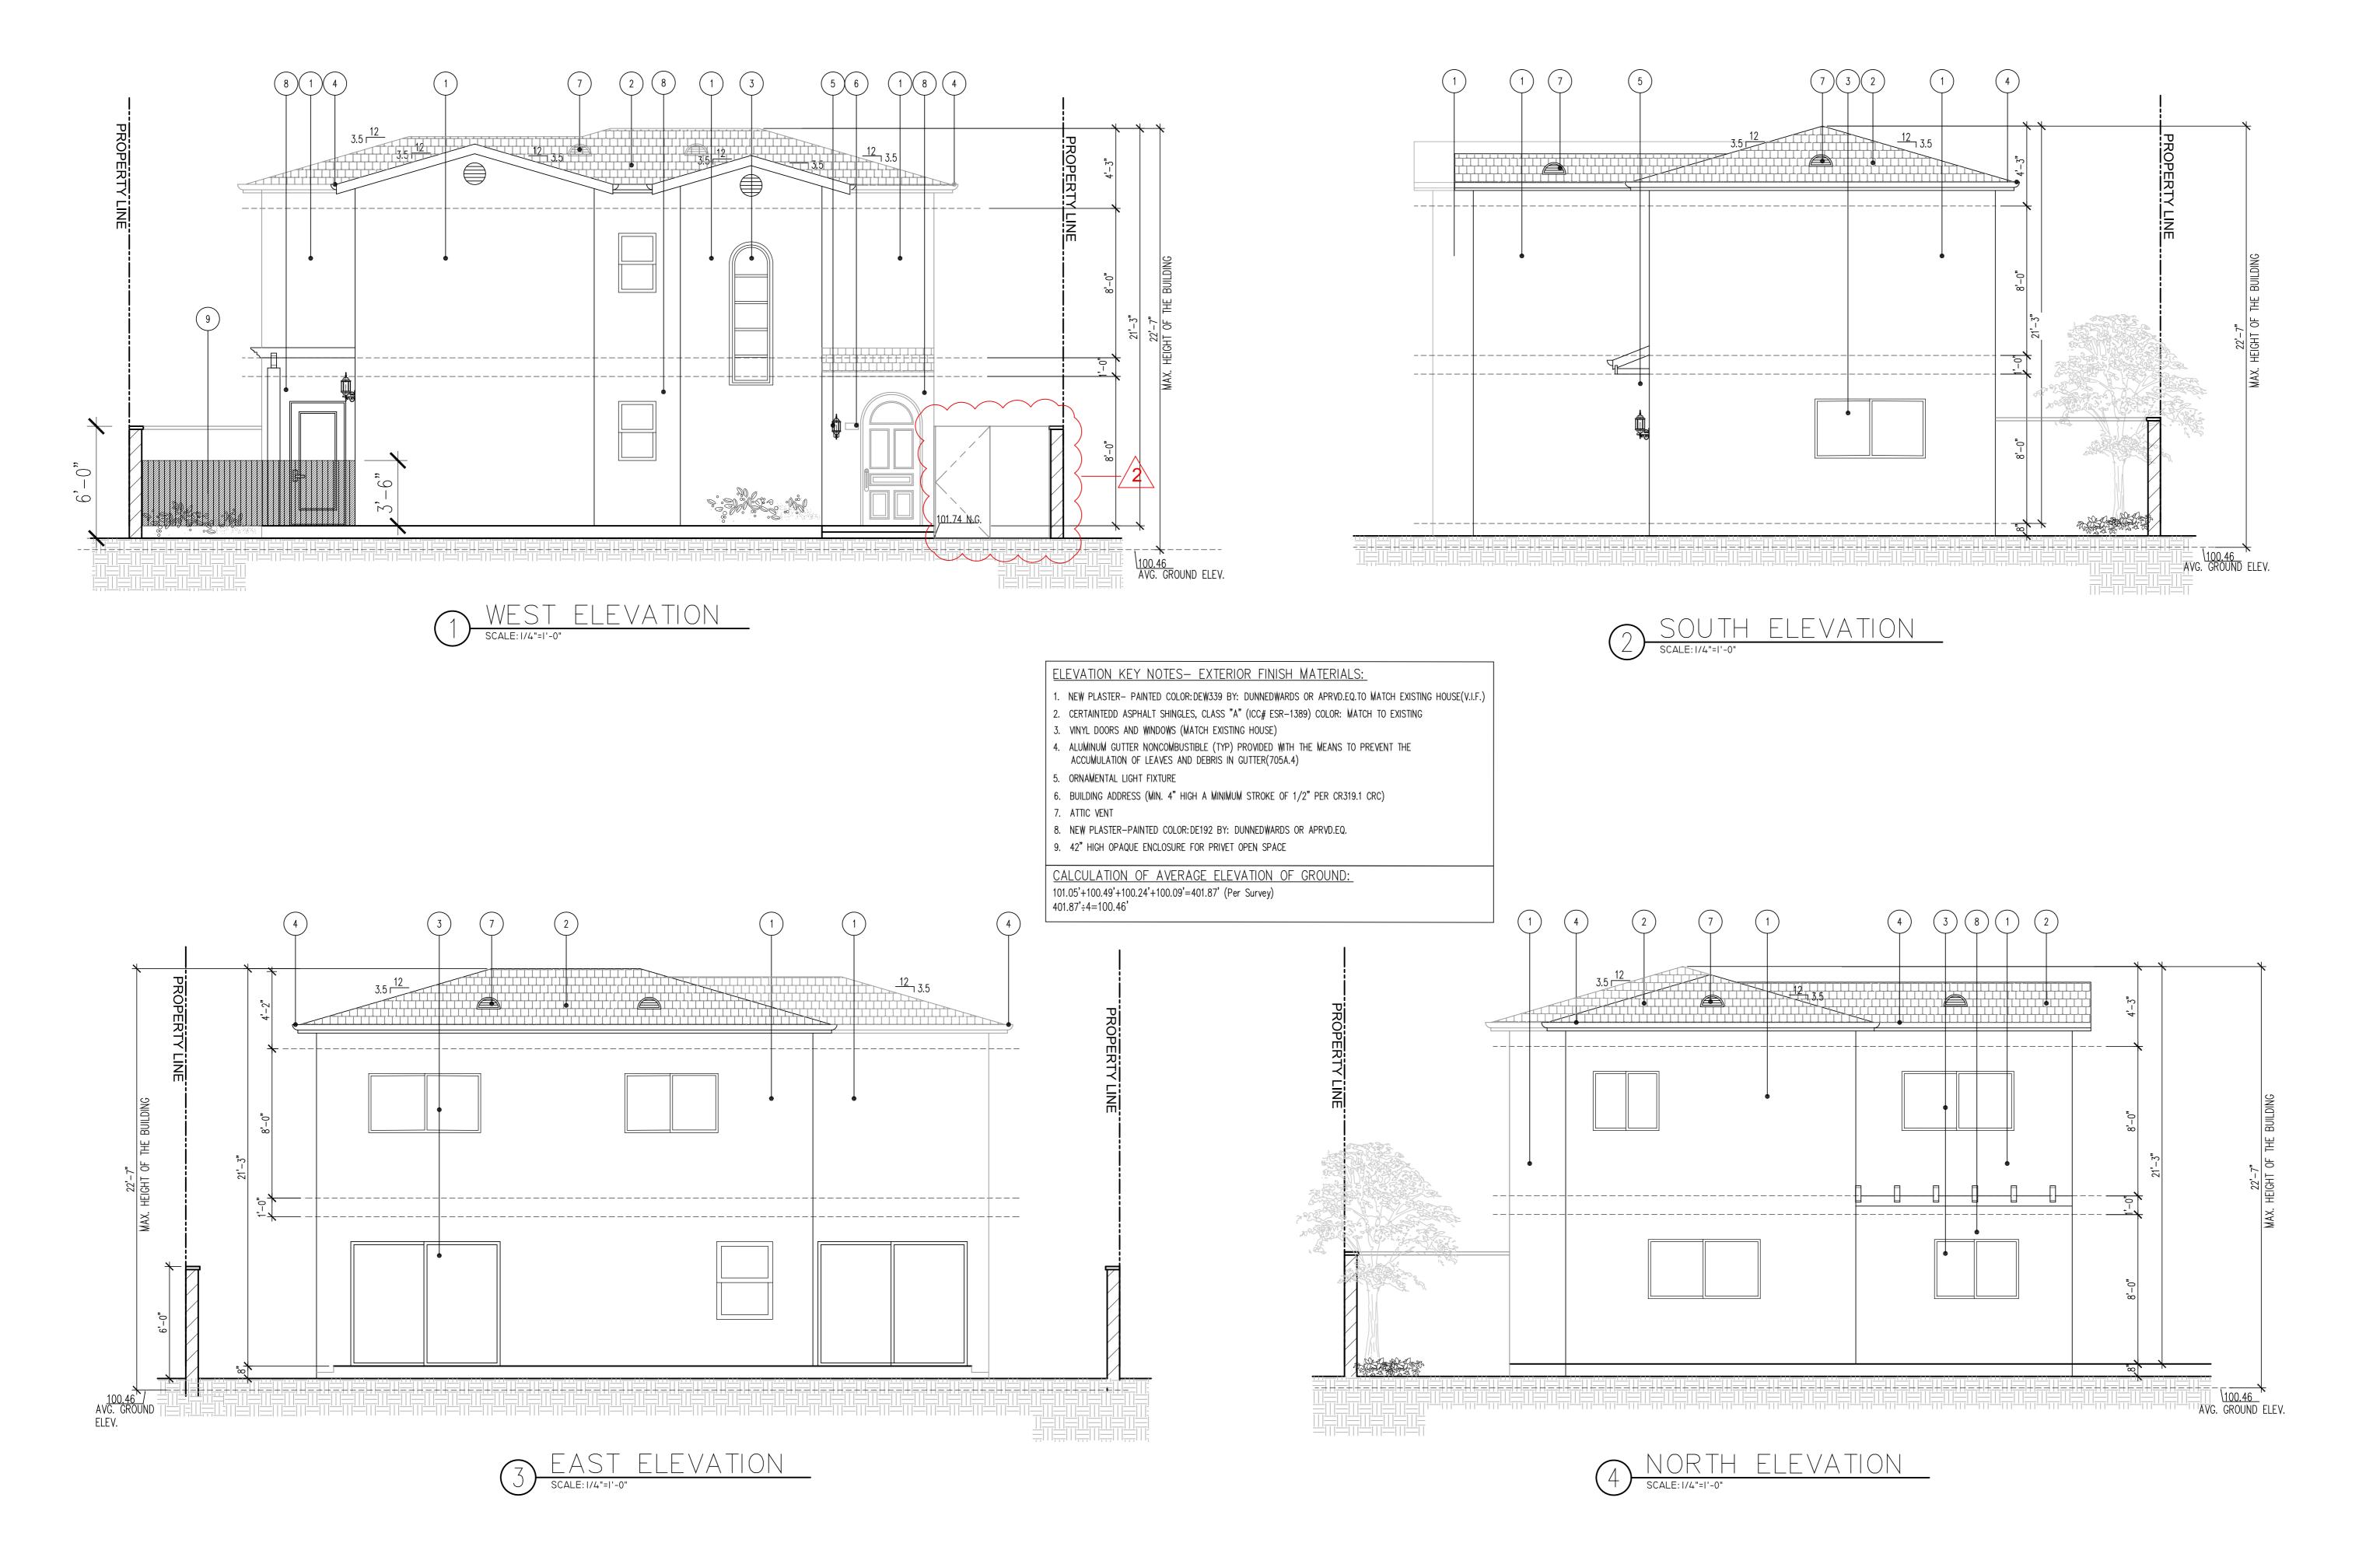

BUILDING DESIGN STUDIO

PARALLEL BUILDING DESIGN STUDIO INC.

P.O.BOX 1602 Glendale, CA 91209 Phone:(818)939-3201 Sevana@Parallelbd.com

Mr.ROGER RANJBAR

PROJECT NAME:

PROJECT ADDRESS:

2230 N FREDERIC ST. BURBANK CA. 91504

PEOPOSED

Scale: 1/4"=1'-0"


APPROVED
 APPROVED

• REVISION


REVISION
1/08/2025
Respond to planning correction
1/104/2024
Respond to planning correction

PRINT DATE

A-3.1

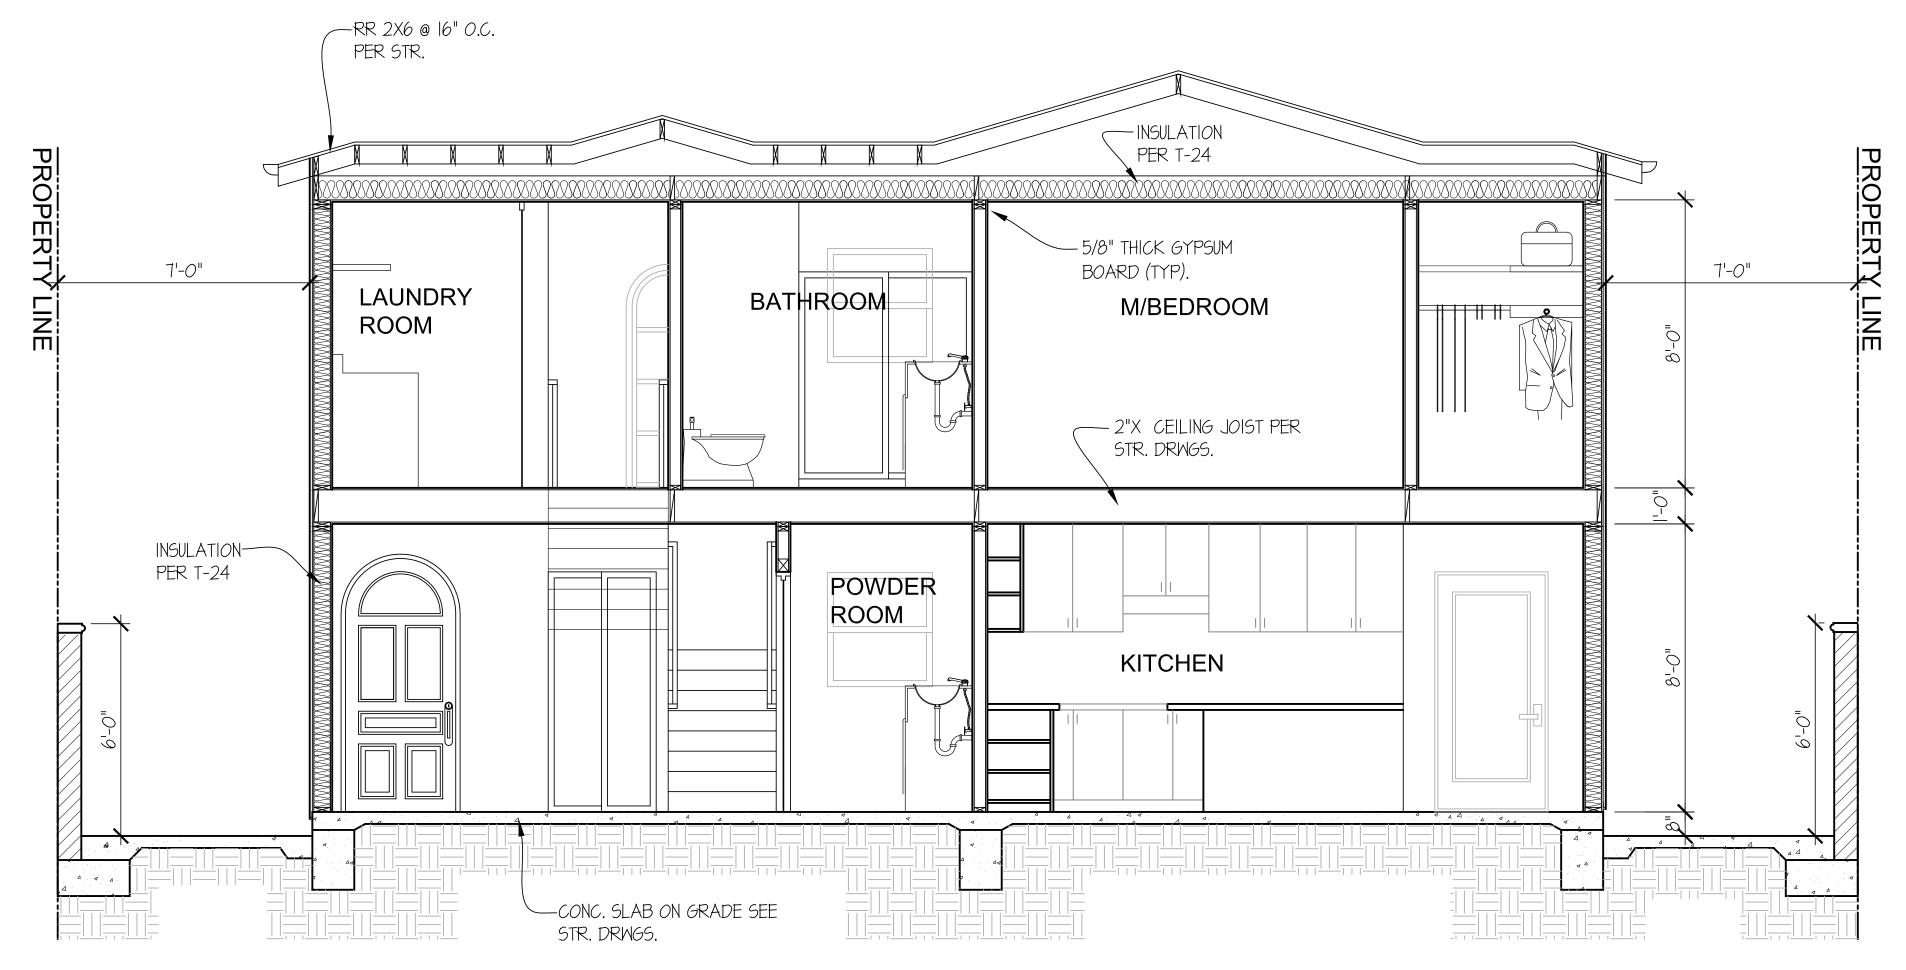

SECTION A SCALE: 1/4"=1'-0"

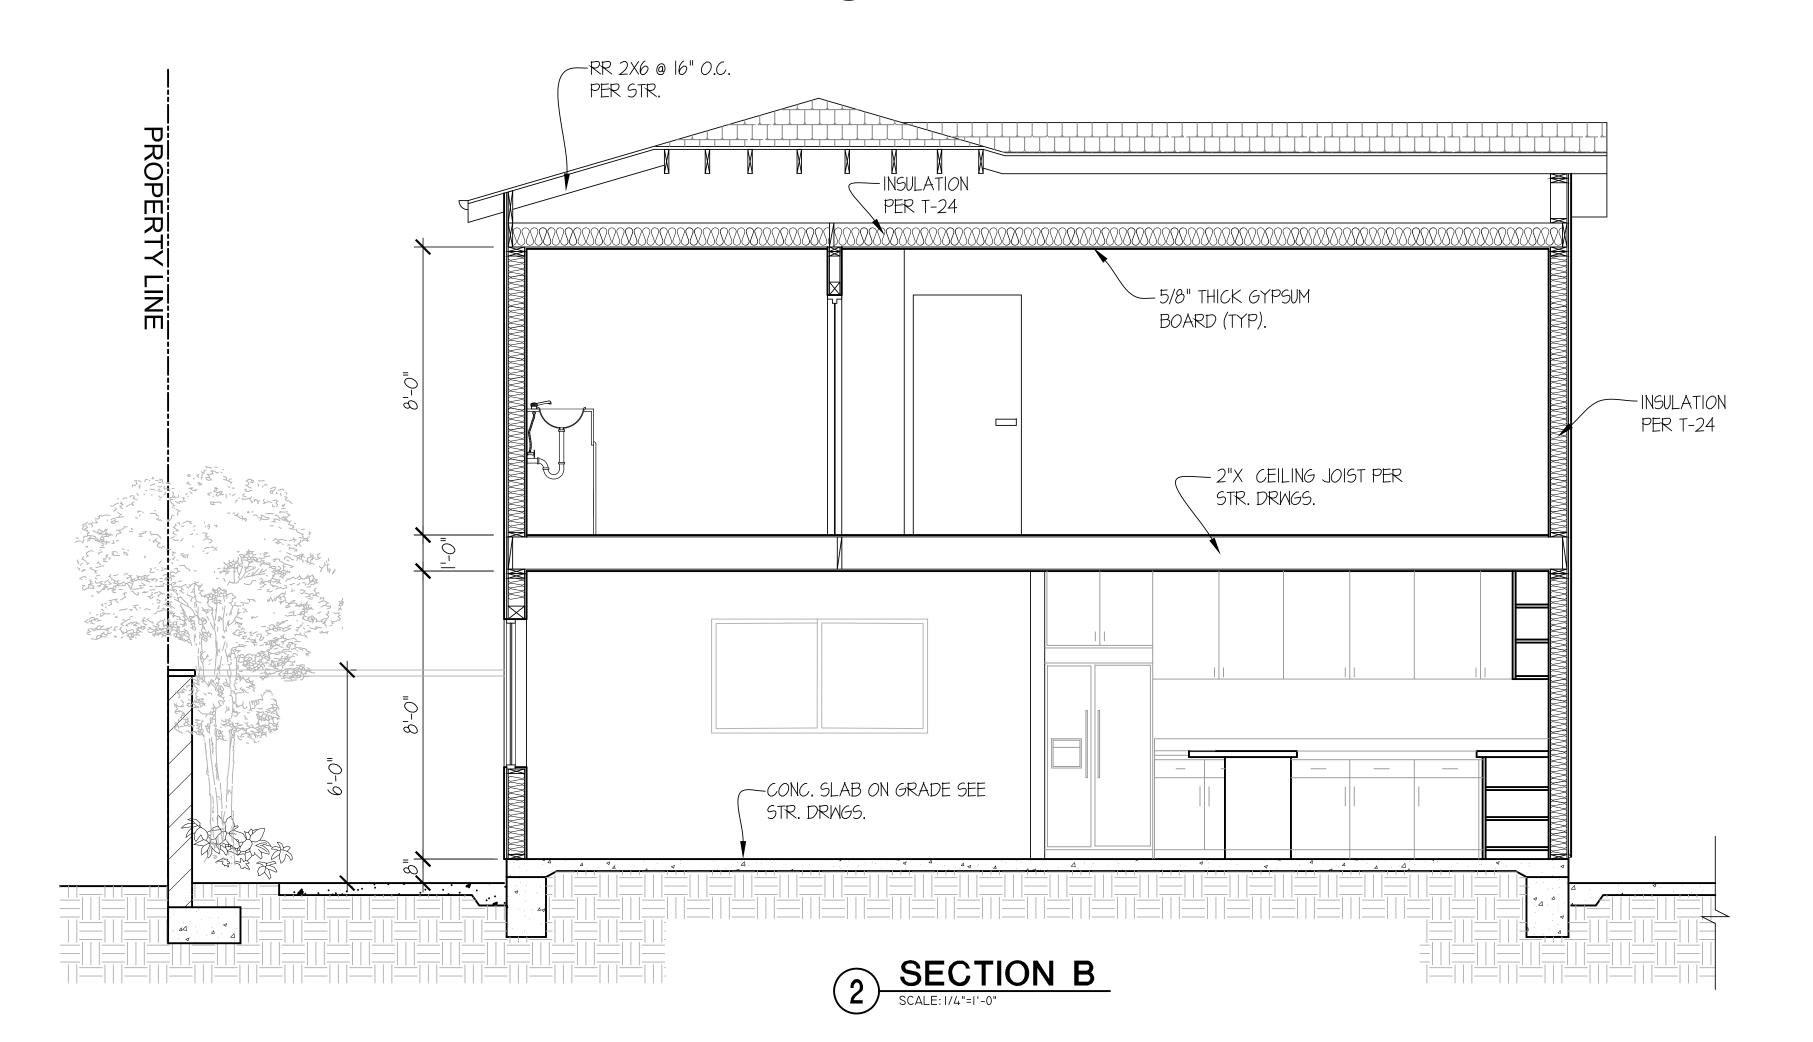

BUILDING DESIGN STUDIO

PARALLEL BUILDING DESIGN STUDIO INC.

P.O.BOX 1602 Glendale, CA 91209 Phone:(818)939-3201 Sevana@Parallelbd.com

OWNER:

Mr.ROGER RANJBAR

PROJECT NAME:

PROJECT ADDRESS:

2230 N FREDERIC ST. BURBANK CA. 91504

SECTIONS

Scale: 3/8"=1'-0"

• APPROVED

• APPROVED

REVISION
 REVISION

• REVISION

• DRAWN BY

PRINT DATE


A-4.1

) WINDO	N SYI	MB0L	Pl	JBLIC S	PACES)							WIN	NDC)W (SCH	EDU	JLE	
	MINDOM	MIN.	LOCATION	M	INDOM S	SIZE	SILL	OPENING	MAT	ERIAL		ZING		DETA	<u> </u>	11 = 1	CTOR	SHO	2	REMARKS
	NUMBER	TYPE	LOCATION	MIDTH	HEIGHT	THICK.	HT.	AREA sa. Ft.	FRAME	MINDOM	SINGLE DUAL	TEMP PLATE	SILL	JMB	HD.		CIOR	SHO		RLMARRS
00R	101	В	LIVINGROOM	6'-0"	3'-2"		3'-6"	9	VINYL	GLASS	DUAL					0.34	NFRC	0.34	NFRC	SLIDING
	102	C	LIVINGROOM	3'-0"	4'-2"		2'-6"	6	VINYL	GLASS										SINGLE HANG
FIRST	103	В	DININGROOM	6'-0"	3'-2"		3'-6"	9	VINYL	GLASS										SLIDING
	104	В	KITCHEN	4'-6"	3'-2"		3'-6"	7	VINYL	GLASS										SLIDING
	105	C	POWDER ROC	⊠'-O"	3'-2"		3'-6"	3	VINYL	GLASS										SINGLE HANG
	201	А	STAIRS	2'-4"	7'-8"		3'-6" ANDII	60	VINYL	GLASS										FIX
Ö K	202	В	BEDROOM#I	6'-0"	3'-2"		3'-6"	9	VINYL	GLASS										SLIDING
	203	В	BEDROOM#2	6'-0"	3'-2"		3'-6"	9	VINYL	GLASS										SLIDING
OND +	204	В	M/BATHROOM	13'-6"	3'-2"		3'-6"	9	VINYL	GLASS										SLIDING
10	205	В	M/BEDROOM	6'-0"	3'-2"		3'-6"	9	VINYL	GLASS										SLIDING
SE	206	C	BATHROOM	2'-0"	3'-2"		3'-6"	3	VINYL	GLASS	-					>	—	-	V	SINGLE HANG

WINDOW TYPES			
1ST FIN, FLR,			LANDING
	WIN.TYPE B	WIN.TYPE C	WIN.TYPE A AT STAIRS

	DOOF	R SYI	MB <i>O</i> L												DOC	R SC	HEDULE
	DOOR	DOOR	LOCATION	DO	OOR SIZI	E	1	E RATIN		MATER	IAL _	GLAS9	ò	D	ETAIL	LUICET.	DEMADEC
	NUMBER	TYPE	LOOATION	MIDTH	HEIGHT	THK.	1-1/2 HR	1-0 20 HR MI	O IN	FRAME	DOOR	SINGLE DUAL	TEMP. FLOAT	SILL	JMB. HD.	HWSET 1	REMARKS
	101	А	ENTRY	3'-6"	7'-0"	3/4"				MOOD	S.C.W						
O N	102	В	LIVING ROOM	6'-0"	6'-8"	3/4"				VINYL	GLASS)					
FLO	103	В	DINING	8'-0"	6'-8"	3/4"				VINYL	GLASS)					
	104	C	PATIO	3'-0"	6'-8"	3/4"				VINYL	GLASS)					
FIRST	105	D	POMDER ROO	M 2'-8"	6'-8"	3/4"				MOOD	H.C.M						
	106	E	C/L DOOR	3'-0"	6'-8"	3/4"				MOOD	H.C.M						
	201	D	BATHROOM	3'-0"	6'-8"	3/4"				MOOD	H.C.M						
DX	202	E	LAUNDRY	6'-4?"	6'-8"	3/4"				MOOD	H.C.M						
0	203	D	BEDROOM#I	3'-0"	6'-8"	3/4"				MOOD	H.C.M						
	204	D	C/L DOOR	l'-9?"	6'-8"	3/4"				MOOD	H.C.M						
	205	D	BEDROOM#2	3'-0"	6'-8"	3/4"				MOOD	H.C.M						
SECOND	206	E	CLOSET	8'-2"	6'-8"	3/4"				MOOD	H.C.M						
"	207	E	CLOSET	8'-2"	6'-8"	3/4"				MOOD	H.C.M						
	208	D	M/BATH	3'-0"	6'-8"	3/4"				MOOD	H.C.M						
	209	D	C/L DOOR	2'-10'	6'-8"	3/4"				MOOD	H.C.M						
	210	D	M/BEDROOM	3'-0"	6'-8"	3/4"				MOOD	H.C.M						

DOOR TYPES

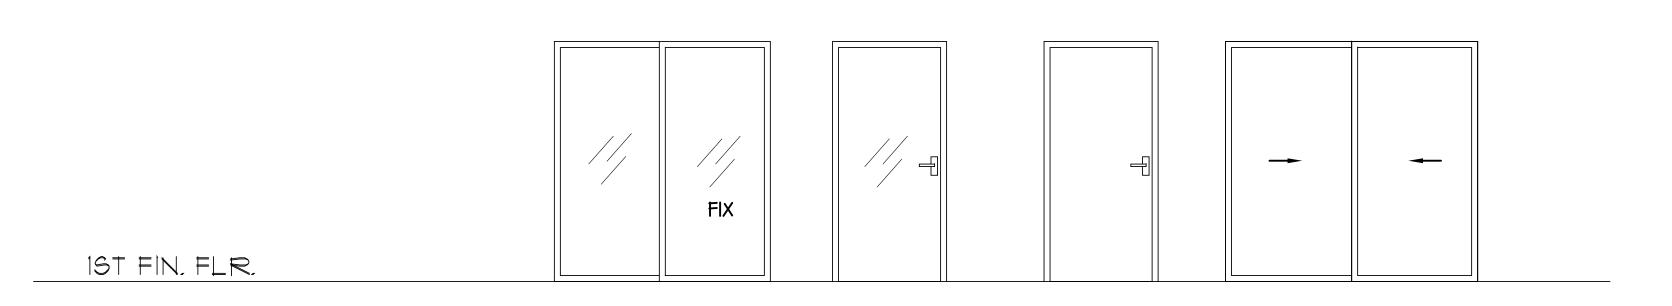

DOOR TYPE A DOOR TYPE B DOOR TYPE CDOOR TYPE D DOOR TYPE E

S.C.W: SOLID CORE WOOD

H.C.W: HOLLOW CORE WOOD

DOOR NOTE:

Exit doors shall be openable from the inside without the use of a key or any special knowledge or effort. All locking devices

BUILDING DESIGN STUDIO

PARALLEL BUILDING DESIGN STUDIO INC.

P.O.BOX 1602 Glendale, CA 91209 Phone:(818)939-3201 Sevana@Parallelbd.com

OWNER:
Mr.ROGER RANJBAR

PROJECT NAME:

PROJECT ADDRESS:

2230 N FREDERIC ST.
BURBANK CA. 91504

DOOR AND WINDOW SCHEDULE

Scale: 3/8"=1'-0"

• APPROVED

• APPROVED

• REVISION

• REVISION

• REVISION

• DRAWN BY

PRINT DATE

A-5.1

PARALLEL BUILDING DESIGN STUDIO INC.

PARALLEL BUILDING DESIGN STUDIO INC.

RANJBAR RESIDENCE

2230 N FREDERIC ST. BURBANK, CA 91504

PROJECT INFORMATION:

CONTACT INFORMATION:

LANDSCAPE ARCHITECT - AD DESIGN INC. EMAIL - anthony@addesigninc.net PHONE - 3 2 3 . 4 5 9 . 5 2 5 7 TOTAL LANDSCAPE AREA - 1,685 SQ. FT. (NOTE: PRESCRIPTIVE SUBMITTAL)


PROJECT TYPE - NEW CONSTRUCTION
WATER SUPPLY - POTABLE WATER

SHEET INDEX:

- L-1 WELO CALCULATIONS
- L-2 LANDSCAPE PLAN
- L-3 IRRIGATION PLAN



Date: 5-6-24

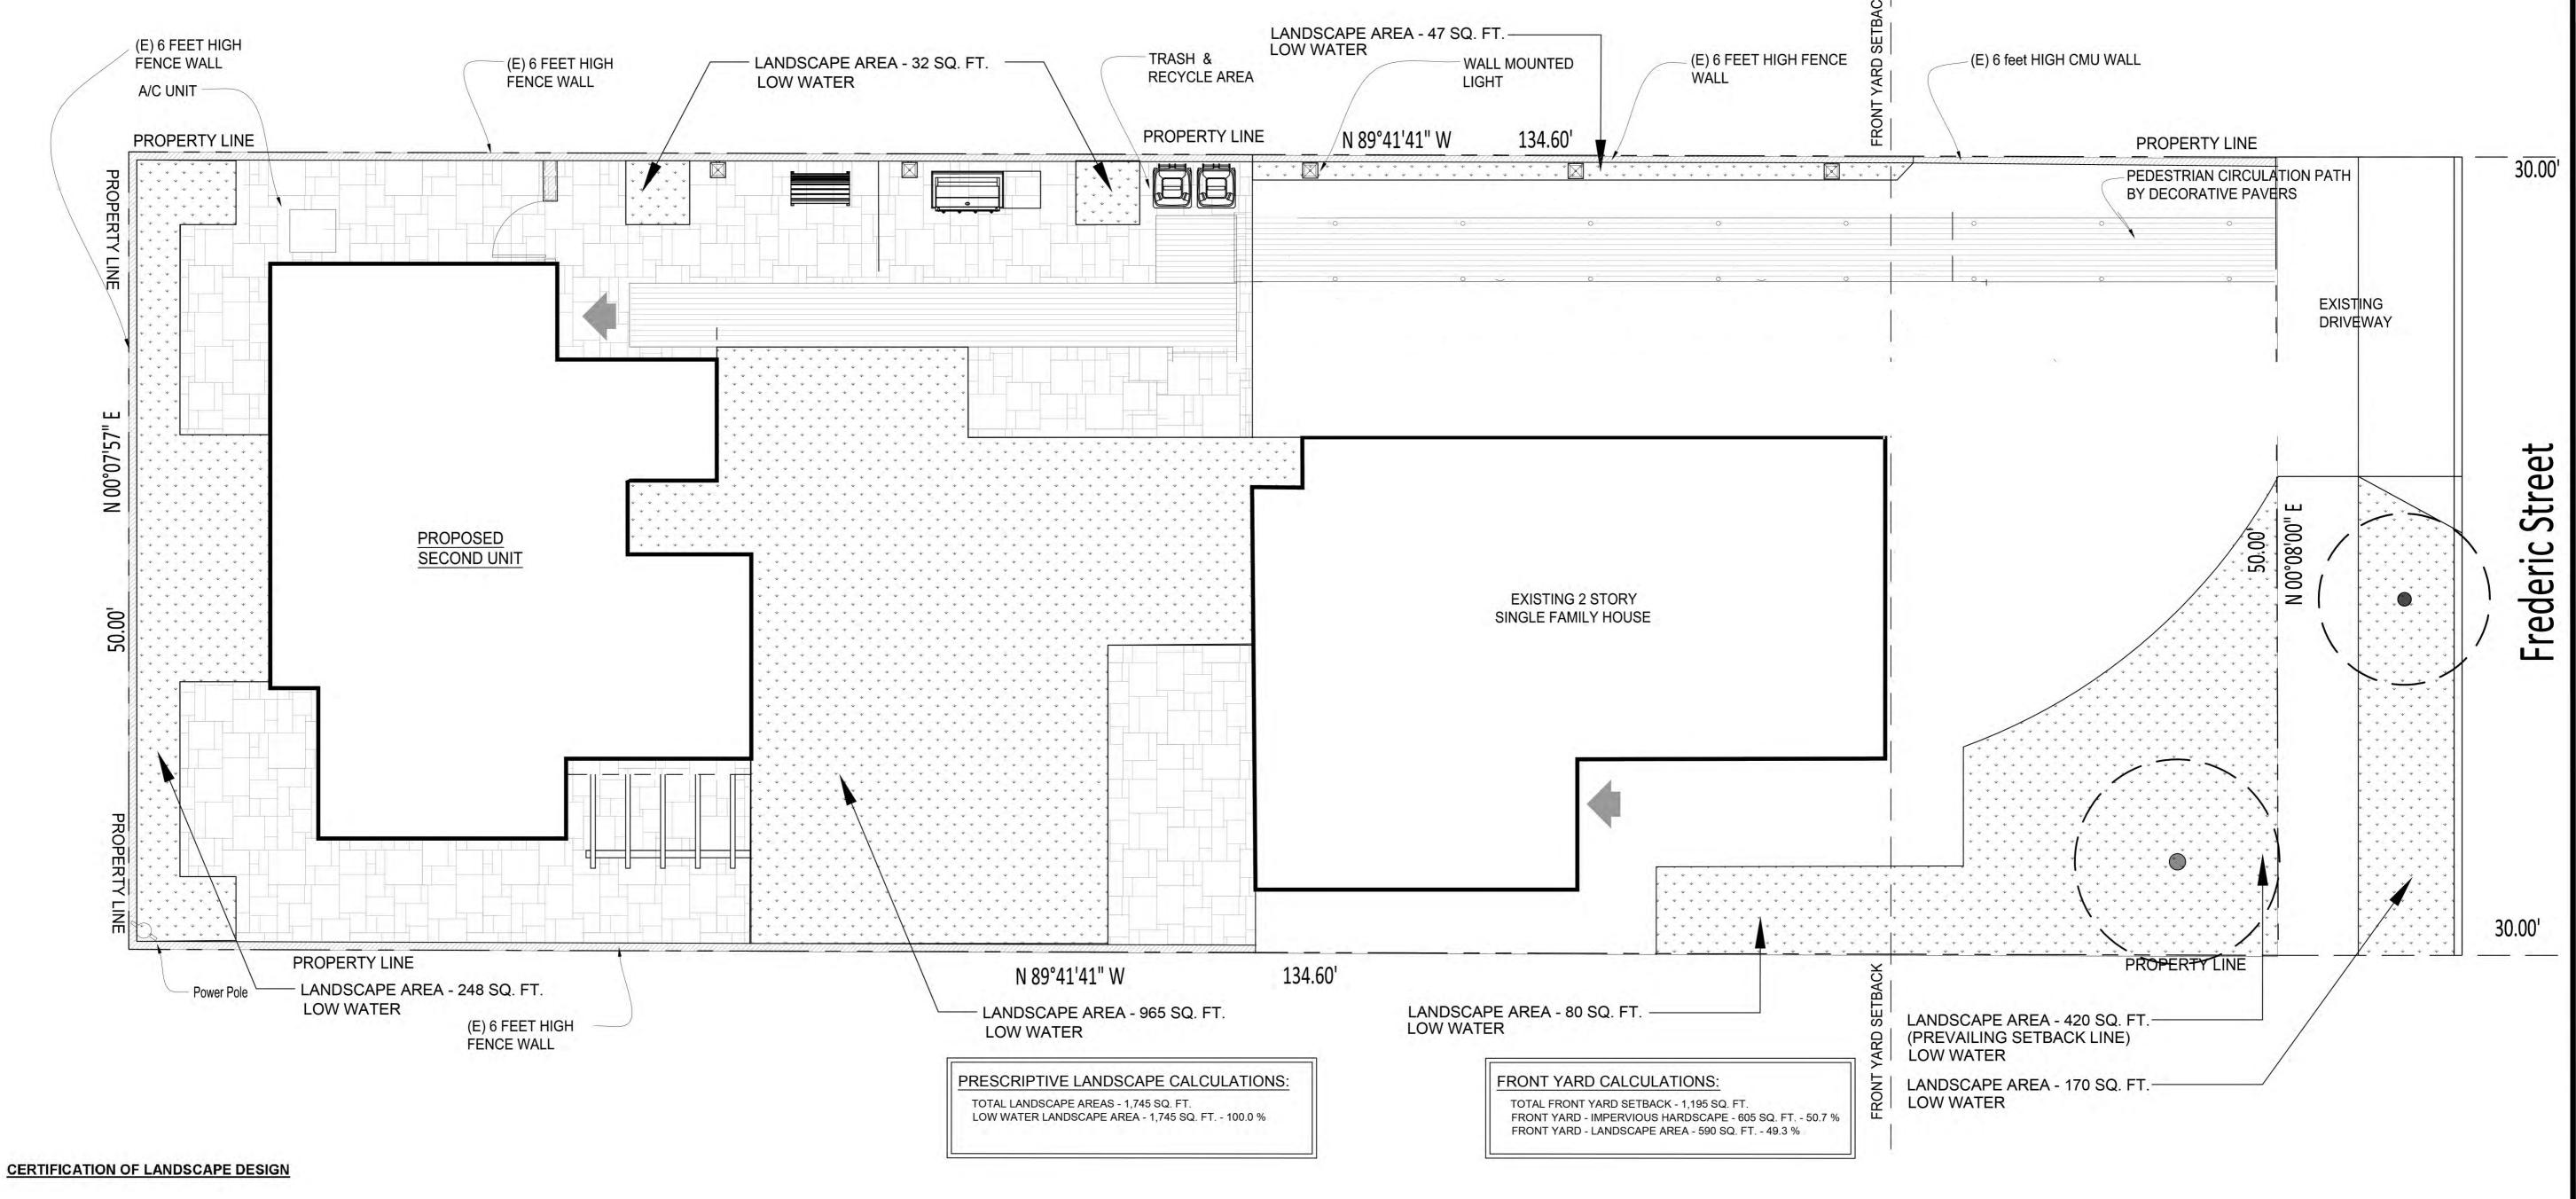

I hereby certify that:

(1) I am a professional appropriately licensed in the State of California to provide professional landscape design services.

The landscape design and water use calculations for the property located at _____
2230 N FREDERIC ST., BURBANK, CA 91504 ____ (provide street address or parcel number(s)) were prepared by me or under my supervision.

(3) The landscape design and water use calculations for the identified property comply with the requirements of the City of ______ Water Efficient Landscape Ordinance (Municipal Code Sections ______ 9-3-500 ______) and the City of _____ BURBANK ____ Water Efficient Landscape Ordinance.

(4) The information I have provided in this Certificate of Landscape Design is true and correct and is hereby submitted in compliance with the City of BURBANK

Guidelines for Implementation of the City of BURBANK

Water Efficient Landscape


Anthony Dornian	5.6.24
Print Name	Date
Millionlan	0.400
LANGE AND	6409

Address

323.459.5257 Telephone

E-mail Address

Landscape Design Professional's Stamp (If applicable)

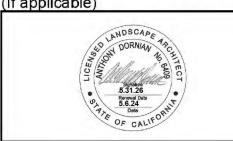

NOTES:

- 1. For residential areas, 75% of landscape, excluding edibles and areas using recycled water, shall consist of plants that average a WUCOLS plant factor of 0.3. WUCOLS plants database can be found online at: http://ucanr.edu/sites/WUCOLS
- A minimum 3-inch layer of mulch shall be applied on all exposed soil surfaces of planting areas except turf areas, creeping or rooting groundcovers, or direct seeding applications where mulch is contraindicated.
- 3. Turf shall not exceed 25% of the landscape area in residential areas.
- 4. No turf permitted in non-residential areas
- 5. Turf not permitted on slopes greater than 25%
- Turf is prohibited in parkways less than 10 feet wide.
- 7. Automatic weather-based or soil-moisture based Irrigation controllers shall be installed on the irrigation system.
- 8. Pressure regulators shall be installed on the irrigation system to ensure dynamic pressure of the system is within the manufacturer's recommended pressure range.
- 9. Manual-shut-off valves shall be installed as close as possible to the point of connection of the water supply.
- 10. Areas less than 10-feet in width in any direction shall be irrigated with subsurface irrigation or other means that produces no runoff or overspray.
- 11. At the time of final inspection, the permit applicant must provide the owner of the property with a certificate of completion, certificate of installation, irrigation schedule of landscape and irrigation maintenance.
- 12. Unless contradicted by a soils test, compost at a rate of a minimum of four cubic yards per 1,000 square feet of permeable area shall be incorporated to a depth of six inches into the soil.




RANJBAR RESIDENCE


2230 N FREDERIC ST. BURBANK, CA 91504

WELO CALCULATION



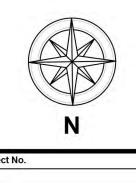

Date: 10-29-24 Scale: 3/16" = 1'-0"

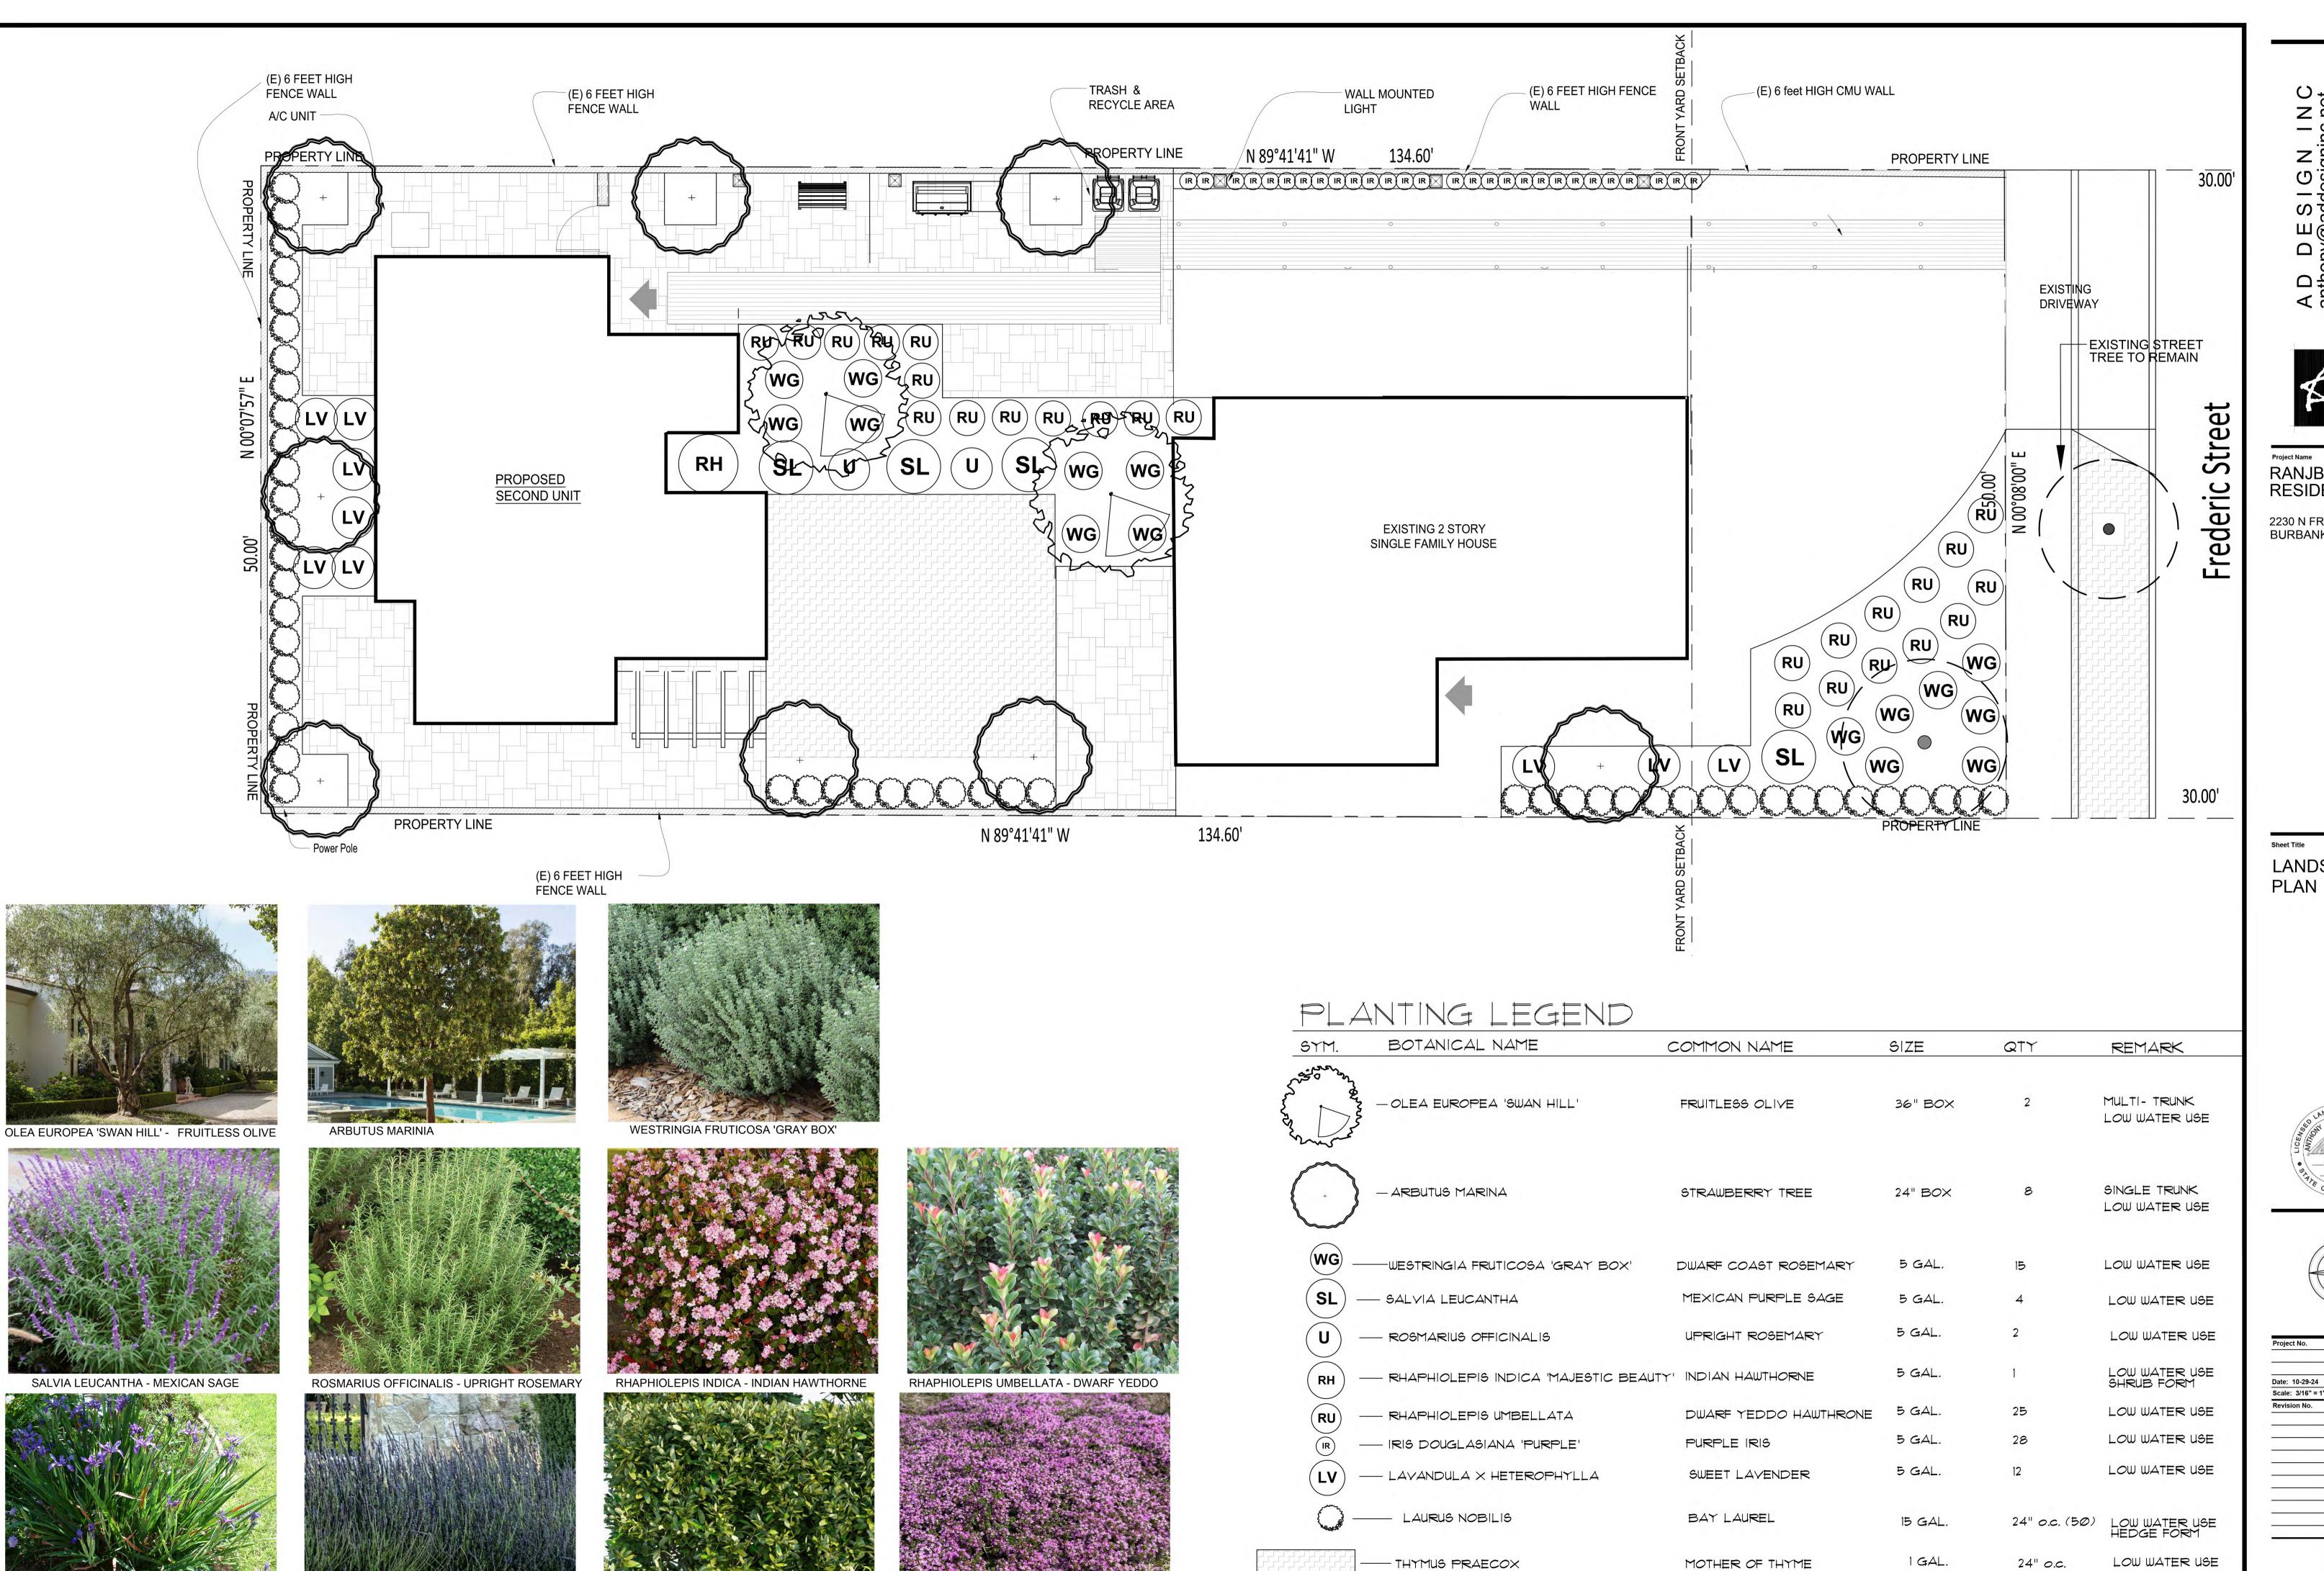



RANJBAR RESIDENCE


2230 N FREDERIC ST. BURBANK, CA 91504

LANDSCAPE





Project No.							
Date: 10-29-24							
Scale: 3/16" = 1'-	0"						
Revision No.	Description						

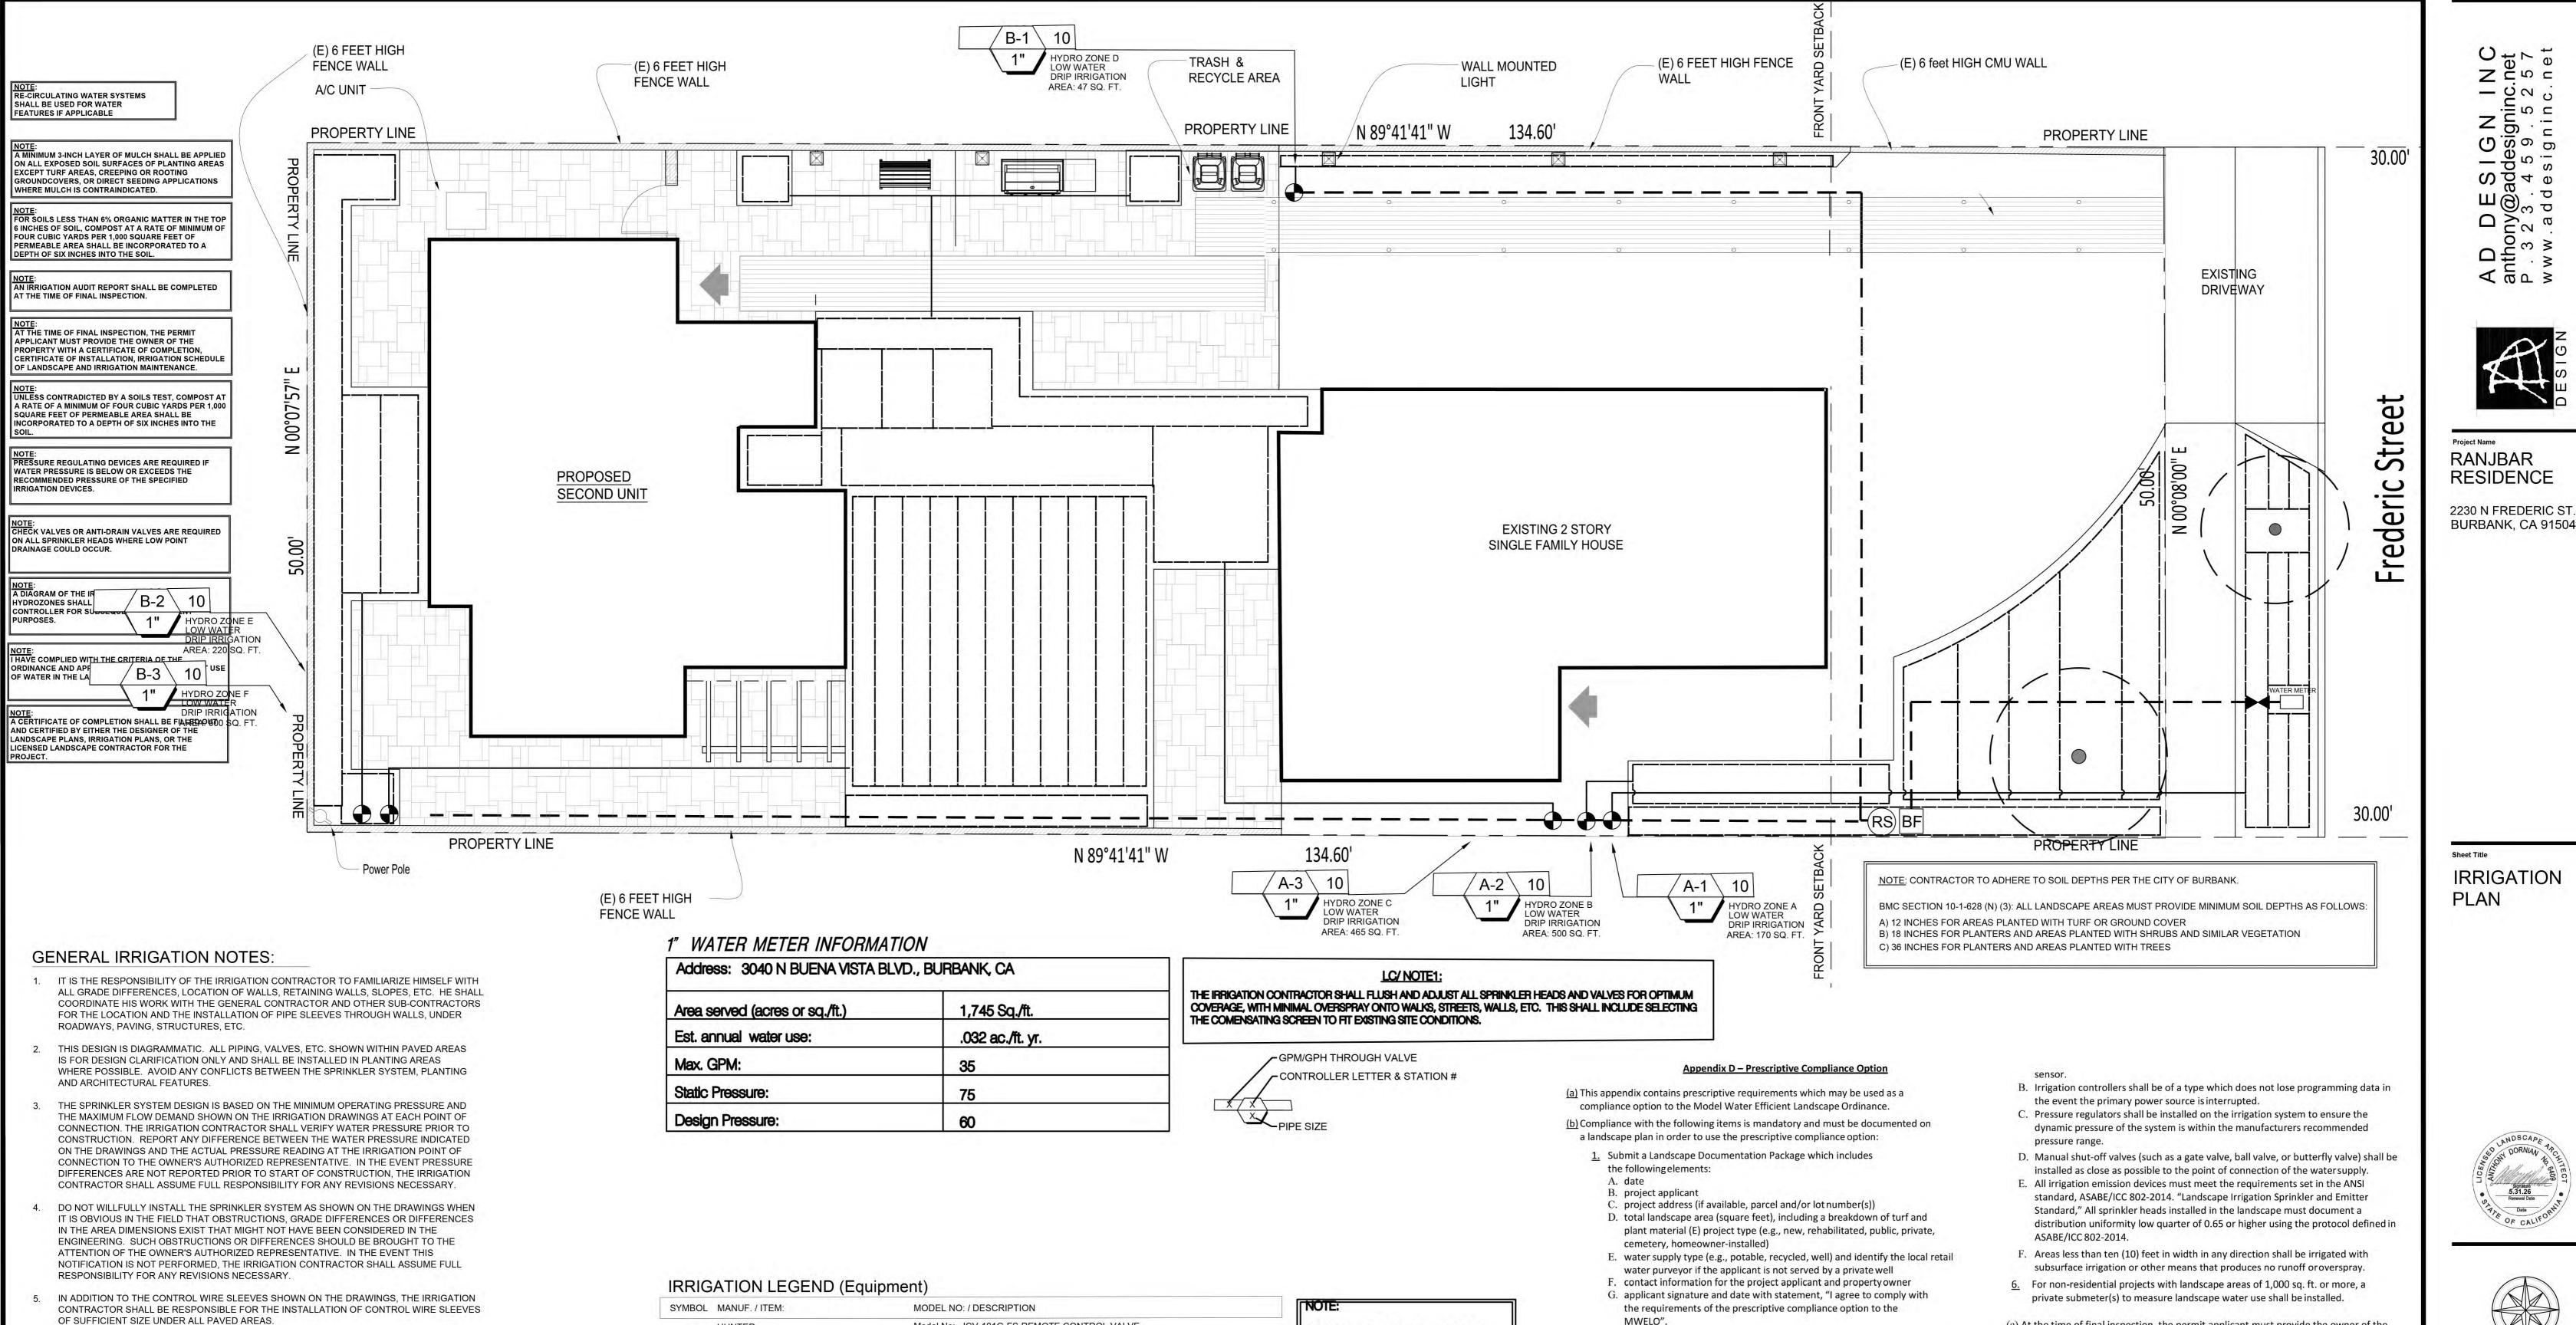

All Hose Bibs shall be connected to

(To be used for all lateral line pipe - see

=

=

1. ALL LATERAL LINE PIPE TO BE 3/4"

ALL PIPE SIZING CALLOUTS ARE IN

INCHES, OR REFERENCE THE PIPE

. PIPE SIZING CALLOUTS ARE SHOWN

ONLY AT THE END OF RUNS. ALL PIPE

. ALL LATERAL LINE PIPE DOWNSTREAM

OF A 3/4" SIZED PIPE IS ALSO 3/4".

SIZED BETWEEN THESE CALLOUTS ARE

UNLESS OTHERWISE NOTED

SIZING LEGEND ABOVE.

SIZED THE SAME.

3/4"

1 1/4"

1 1/2"

2 1/2"

plan for mainline and sleeve sizing)

the potable water system

per Water Districts Standards

PIPE SIZING LEGEND:

0-10 GPM

11-16 GPM

17-28 GPM

29-35 GPM

36-55 GPM

56-75 GPM

NOTES:

2. Incorporate compost at a rate of at least four cubic yards per 1,000 square feet

to a depth of six inches into landscape area (unless contra-indicated by a soil

A. For residential areas, install climate adapted plants that require occasional, little

or no summer water (average WUCOLS plant factor 0.3) for 75% of the plant

areas, install climate adapted plants that require occasional, little or no summer

water (average WUCOLS plant factor 0.3) for 100% of the plant area excluding

area excluding edibles and areas using recycled water; For non-residential

B. A minimum three inch (3") layer of mulch shall be applied on all exposed soil

A. Turf shall not exceed 25% of the landscape area in residential areas, and there

groundcovers, or direct seeding applications where mulch is contraindicated.

surfaces of planting areas except in turf areas, creeping or rooting

B. Turf shall not be planted on sloped areas which exceed a slope of 1 foot

C. Turf is prohibited in parkways less than 10 feet wide, unless the parkway is

adjacent to a parking strip and used to enter and exit vehicles. Any turf in

parkways must be irrigated by sub-surface irrigation or by other technology that

vertical elevation change for every 4 feet of horizontal length;

A. Automatic irrigation controllers are required and must use

evapotranspiration or soil moisture sensor data and utilize a rain

3. Plant material shall comply with all of the following;

edibles and areas using recycled water;

4. Turf shall comply with all of the following:

creates no overspray or runoff.

shall be no turf in non-residential areas;

<u>5.</u> Irrigation systems shall comply with the following:

Model No: ICV-101G-FS REMOTE CONTROL VALVE

Model No: NIBCO BRONZE- LINE SIZE

Model No: SCHEDULE 40 PVC PURPLE PIPE

SIZE AS NOTED ON PLAN - 12" MIN. COVER

EXTEND 12" PAST EDGE OF HARDSCAPE.

BACKFLOW PREVENTATION DEVICE - LEAD FREE - REDUCED PRESSURE - DOMESTIC ONLY

IRRIGATION CONTROLLER- WALL MOUNT- VERIFY ACTUAL

LOCATION AND POWER HOOK-UP WITH OWNER'S REP.

Model No: X-CORE OUTDOOR WI-FI CONTROLLER - B6-IGXC800 - 8 STATION

Model No: 1 1/2" OR SMALLER (SCH 40 PVC PIPE). 2" AND LARGER (CL. 315 PVC PIPE)

SIZE AS NOTED ON PLAN - 18" MIN. COVER WITH PURPLE PIPE

Model No: SCH. 40 PVC PIPE 4" MIN., INSTALL 18" BELOW GRADE.

VALVE

RS

HUNTER

APPROVED

GATE VALVE

APPROVED

LATERAL LINE

APPROVED

MAIN LINE

APPROVED

PIPE SLEEVE

STRAINER- WILKINS 80

PRESSURE REGULATOR - WILKINS

CONTROLLER

HUNTER - SOLAR SYNC - RAIN SENSOR

HUNTER QUICK COUPLER 3/4" ON PURPLE CAP

INSTALL ALL PIPE MATERIALS AND EQUIPMENT AS SHOWN IN DETAILS. USE TEFLON TAPE

OR TEFLON PIPE DOPE ON ALL PVC MALE PIPE THREADS ON ALL SPRINKLER SWING

7. ALL POP-UP TYPE SPRINKLER HEADS INSTALLED IN SHRUB OR GROUND COVER AREAS

ALL POP-UP TYPE SPRINKLER HEADS INSTALLED IN AREAS SHALL BE INSTALLED SO

SHALL BE INSTALLED SO THAT THE TOP OF THE SPRINKLER HEAD IS 1" ABOVE FINISH

THAT THE TOP OF THE SPRINKLER HEADS ARE FLUSH WITH ADJACENT SIDEWALK OR

ADJUSTING OF ALL HEADS BY THE IRRIGATION CONTRACTOR, SO THAT THE TOP OF THE

SPRINKLER HEAD IS 1/4" ABOVE FINISH GRADE, SHALL BE ACCOMPLISHED WITHIN TEN

OPTIMUM PERFORMANCE AND TO PREVENT OVERSPRAY ONTO WALKS, ROADWAYS AND/OR

NOTE: 1. CONTRACTOR SHALL INSTALL PRESSURE COMPENSATING NOZZLE SCREENS IN ALL SPRINKLER HEADS

USE WITH SENNINGER PRESSURE REDUCERS, INSTALL PER MAUFACTUERS SPECIFICATIONS

4. CONTRACTOR TO CONNECT NEW IRRIGATION MAINLINE TO EXISTING MAINLINE IRRIGATION SYSTEM.

2. INSTALL AQUAPORE BETWEEN ALL STEPPERS AND OR PAVING W/ TURF BORDERS. INSTALL PER MFG. SPECS

3. CONTRACTOR TO LOCATE AND VERIFY POINT OF CONNECTION IN THE FIELD AND APPROVED WITH OWNER/LANDSCAPE ARCHITECT

BUILDINGS AS MUCH AS POSSIBLE. THIS SHALL INCLUDE SELECTING THE BEST DEGREE

OF ARC TO FIT THE EXISTING SITE CONDITIONS AND TO THROTTLE THE FLOW CONTROL

AT EACH VALVE TO OBTAIN THE OPTIMUM OPERATING PRESSURE FOR EACH SYSTEM.

REQUIRING ADJUSTMENT OF RADIUS. REFER TO MANUFACTURERS LITERATURE.

(10) DAYS AFTER NOTIFICATION BY THE OWNER'S AUTHORIZED REPRESENTATIVE.

10. THE IRRIGATION CONTRACTOR SHALL FLUSH AND ADJUST ALL SPRINKLER HEADS FOR

JOINT AND VALVE ASSEMBLIES.







(c) At the time of final inspection, the permit applicant must provide the owner of the

property with a certificate of completion, certificate of installation, irrigation schedule

and a schedule of landscape and irrigation maintenance.

Date: 10-29-24 Scale: 3/16" = 1'-0" Revision No.