wireless

DISH Wireless L.L.C. SITE ID:

LALAX04397B

SOUTH MAIN & ELMWOOD

DISH Wireless L.L.C. SITE ADDRESS:

800 SOUTH MAIN STREET BURBANK, CA 91506

CALIFORNIA - LA COUNTY CODE COMPLIANCE

ALL WORK SHALL BE PERFORMED AND MATERIALS INSTALLED IN ACCORDANCE WITH THE CURRENT EDITIONS OF THE FOLLOWING CODES AS ADOPTED BY THE LOCAL GOVERNING AUTHORITIES. NOTHING IN THESE PLANS IS TO BE CONSTRUED TO PERMIT WORK NOT CONFORMING TO THESE CODES:

CODE TYPE BUILDING **MECHANICAL**

ELECTRICAL

2020 LA COUNTY BUILDING CODE (2019 CBC/2018 IBC) 2020 LA COUNTY MECHANICAL CODE (2019 CMC/2018 UMC) 2020 LA COUNTY ELECTRICAL CODE (2019 CEC/2017 NEC)

	SHEET INDEX
SHEET NO.	SHEET TITLE
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C-1	SITE SURVEY
A-1	OVERALL SITE PLAN
A-2	ENLARGED BUILDING PLAN
A-3	ANTENNA PLAN AND SCHEDULE
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A-5	NORTH EAST AND SOUTH WEST ELEVATIONS

SCOPE OF WORK

THIS IS NOT AN ALL INCLUSIVE LIST. CONTRACTOR SHALL UTILIZE SPECIFIED EQUIPMENT PART OR ENGINEER APPROVED EQUIVALENT. CONTRACTOR SHALL VERIFY ALL NEEDED EQUIPMENT TO PROVIDE A FUNCTIONAL SITE. THE PROJECT GENERALLY CONSISTS OF THE FOLLOWING:

SECTOR SCOPE OF WORK:

INSTALL (6) PROPOSED PANEL ANTENNAS (2 PER SECTOR)
INSTALL (6) PROPOSED ANTENNA MOUNTS (2 PER SECTOR)

INSTALL (6) PROPOSED ANTENNA MOUNTS (2 PER SECTOR)
INSTALL (2) PROPOSED FRP SCREENS (1 PER SECTORS ALPHA & GAMMA, 1 PER SECTOR BETA)
INSTALL PROPOSED JUMPERS
INSTALL (12) PROPOSED RRUS (4 PER SECTOR)
INSTALL (2) PROPOSED OVER VOLTAGE PROTECTION DEVICE (OVP) (1 AT ALPHA & GAMMA, 1 AT BETA SECTORS)
INSTALL (2) PROPOSED HYBRID CABLES (1 AT ALPHA & GAMMA, 1 AT BETA SECTORS)

ROOFTOP SCOPE OF WORK:

• INSTALL (1) PROPOSED CURB FRAMING

• INSTALL (2) PROPOSED H-FRAMES

INSTALL (1) PROPOSED CABLE TRAY PROPOSED BBU IN CABINET PROPOSED EQUIPMENT CABINET

PROPOSED POWER CONDUIT INSTALL PROPOSED TELCO CONDUIT INSTALL PROPOSED FOWER PROTECTIVE CABINET
PROPOSED TELCO FIBER ENCLOSURE
PROPOSED FIBER NID, IF REQUIRED INSTALL PROPOSED GPS UNIT INSTALL

INSTALL (2) PROPOSED FRP SCREEN TO BE PAINTED AND TEXTURED TO MATCH W/EXISTING UPPER BUILDING ADDING HORIZONTAL TRIM STRIP PROPOSED CABLE ENCLOSURE

INSTALL

PROPOSED SECURED ACCESS LADDER

INSTALL (1) PROPOSED GENERATOR INTERFACE
INSTALL (1) PROPOSED TRANSFORMER ON CONCRETE PAD
INSTALL (1) PROPOSED ELECTRICAL METER
INSTALL (1) PROPOSED ELECTRIC PANEL


PROJECT DIRECTORY SITE INFORMATION **APPLICANT:** DEL REY PROPERTIES, LLC DISH Wireless L.L.C. 5701 SOUTH SANTA FE DRIVE ADDRESS: 212 NORTH EVERGREEN ST LITTLETON, CO 80120 BURBANK, CA 91505 **TOWER TYPE:** ROOFTOP DEL REY PROPERTIES. LLC TOWER CO SITE ID: 212 NORTH EVERGREEN ST BURBANK, CA 91505 TOWER APP NUMBER: (818) 333-1407 SITE DESIGNER: SURESITE COUNTY: LOS ANGELES 2000 AUBURN DR. SUITE 200 LATITUDE (NAD 83): BEACHWOOD, OH 44122 34° 09' 54.49" N 34.165136° LONGITUDE (NAD 83): 118' 18' 43.80" W -118.312167 SITE ACQUISITION: ZONING JURISDICTION: CITY OF BURBANK **BECKY RHODES** becky.rhodes@dish.com **ZONING DISTRICT:** NB-NEIGHBORHOOD COMML. CONSTRUCTION MANAGER: MIKE HUBBARD PARCEL NUMBER: 2451-031-001 michael.hubbard@dish.com OCCUPANCY GROUP: RF ENGINEER: CRAIG STANZIANO CONSTRUCTION TYPE: II-B craig.stanziano@dish.com POWER COMPANY: BG&E

DIRECTIONS

TELEPHONE COMPANY: SPECTRUM

NO SCALE

DIRECTIONS FROM DISH IRVINE OFFICE: HEAD NORTHWEST TOWARD ARMSTRONG AVE, TURN RIGHT ONTO ARMSTRONG AVE, TURN LEFT ONTO BARRANCA PKWY. CONTINUE ONTO E DYER RD, USE THE RIGHT LANE TO MERGE ONTO CA-55 N/STATE RTE 55 N VIA THE RAMP TO RIVERSIDE, FOLLOW I-5 N TO BURBANK. TAKE EXIT 145B FROM I-5 N/GOLDEN STATE FWY, MERGE ONTO CA-55 N/STATE RTE 55 N. TAKE EXIT 10B TO MERGE ONTO I-5 N TOWARD SANTA ANA, KEEP LEFT TO STAY ON I-5 N, KEEP RIGHT AT THE FORK TO STAY ON I-5 N, FOLLOW SIGNS FOR I-10 W/SANTA MONICA/INTERSTATE 5 N/SACRAMENTO, KEEP LEFT TO STAY ON I-5 N, FOLLOW SIGNS FOR SACRAMENTO, KEEP RIGHT TO CONTINUE ON I-5 N/GOLDEN STATE FWY, FOLLOW SIGNS FOR SACRAMENTO, TAKE EXIT 145B TOWARD ALAMEDA AVE. KEEP LEFT AT THE FORK, FOLLOW SIGNS FOR ALAMEDA AVENUE W AND MERGE ONTO W ALAMEDA AVE, CONTINUE ON W ALAMEDA AVE. DRIVE TO S MAIN ST. MERGE ONTO W ALAMEDA AVE, TURN RIGHT ONTO S MAIN ST, DESTINATION WILL BE ON THE RIGHT

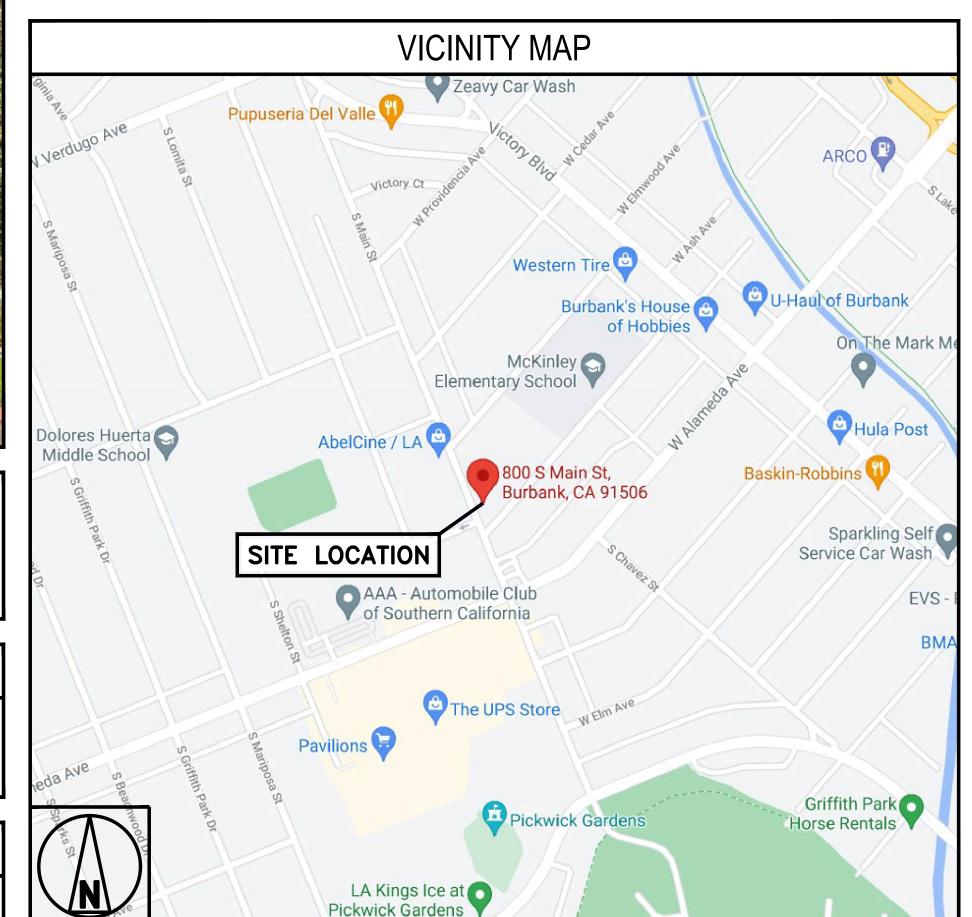



BEACHWOOD, OH 44122

5701 SOUTH SANTA FE DRIVE

LITTLETON, CO 80120

IT IS A VIOLATION OF LAW FOR ANY PERSON, UNLESS THEY ARE ACTING UNDER THE DIRECTION OF A LICENSED PROFESSIONAL ENGINEER, TO ALTER THIS DOCUMENT.

DRAWN BY: CHECKED BY: APPROVED BY: RFDS REV #:

ZONING DOCUMENTS

SUBMITTALS					
REV	DATE DESCRIPTION				
A	08/06/2021	ISSUED FOR REVIEW			
0	10/11/2021	FINAL ZONING DOCUMENTS			
1	07/28/2023	SAQ COMMENTS			
A&E PROJECT NUMBER SOUTH MAIN & ELMWOOD LALAX04397B					

DISH Wireless L.L.C. PROJECT INFORMATION

LALAX04397B 800 SOUTH MAIN STREET BURBANK, CA 91506

> SHEET TITLE TITLE SHEET

T-1

SHEET NUMBER



SITE PHOTO





UNDERGROUND SERVICE ALERT UTILITY NOTIFICATION CENTER OF CALIFORNIA (800) 422-4133 WWW.CALIFORNIA811.ORG


CALL 2-14 WORKING DAYS UTILITY NOTIFICATION PRIOR TO CONSTRUCTION

GENERAL NOTES

THE FACILITY IS UNMANNED AND NOT FOR HUMAN HABITATION. A TECHNICIAN WILL VISIT THE SITE AS REQUIRED FOR ROUTINE MAINTENANCE. THE PROJECT WILL NOT RESULT IN ANY SIGNIFICANT DISTURBANCE OR EFFECT ON DRAINAGE. NO SANITARY SEWER SERVICE, POTABLE WATER, OR TRASH DISPOSAL IS REQUIRED AND NO COMMERCIAL SIGNAGE IS PROPOSED.

11"x17" PLOT WILL BE HALF SCALE UNLESS OTHERWISE NOTED

CONTRACTOR SHALL VERIFY ALL PLANS, EXISTING DIMENSIONS, AND CONDITIONS ON THE JOB SITE, AND SHALL IMMEDIATELY NOTIFY THE ENGINEER IN WRITING OF ANY DISCREPANCIES BEFORE PROCEEDING WITH THE WORK.

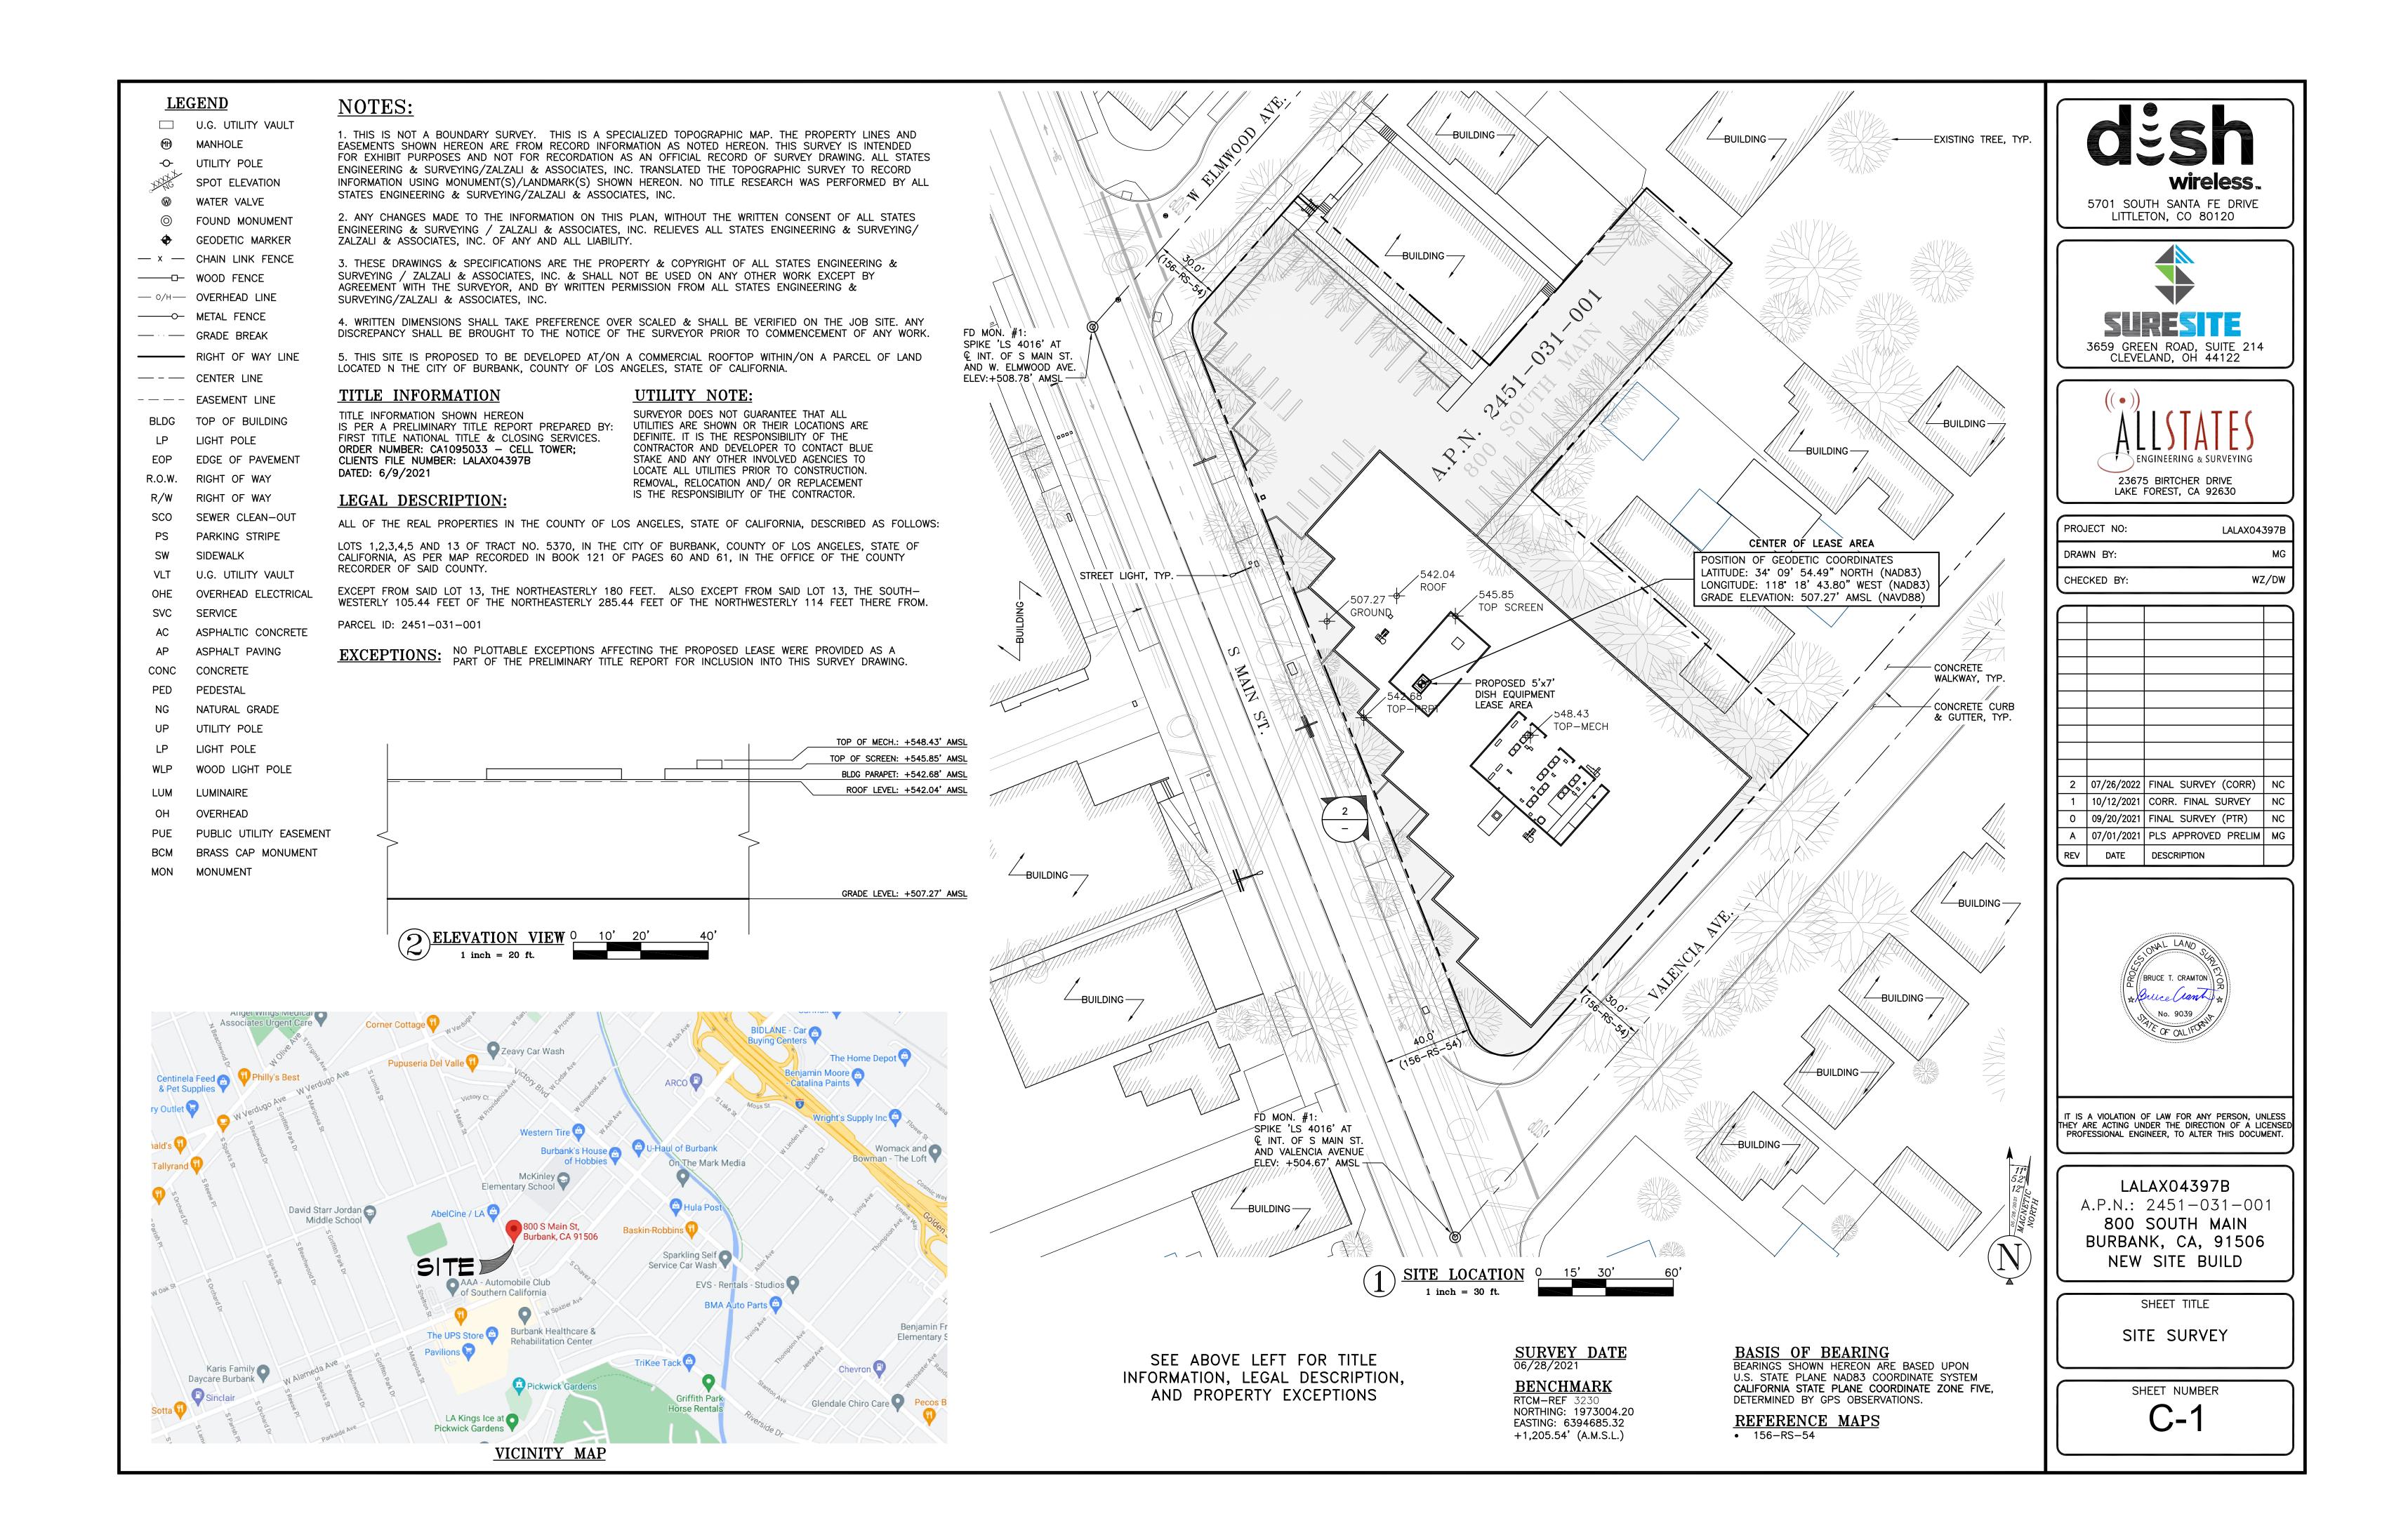

FRP ARCHITECTURAL AESTHETICS

1. PAINT TO MATCH UPPER BUILDING COLOR, ADDING HORIZONTAL TRIM STRIP TO MATCH. (THE BUILDING IS SALMON, GREEN AND CREAM. BY ADDING A GREEN OR SALMON TO THE TOP MIGHT REDUCE THE MASS OF THE FRP SCREENS)

<u>NOTES</u>

- 1. CONTRACTOR SHALL FIELD VERIFY ALL DIMENSIONS.
- 2. CONTRACTOR SHALL MAINTAIN A 10'-0" MINIMUM SEPARATION BETWEEN THE PROPOSED GPS UNIT, TRANSMITTING ANTENNAS AND EXISTING GPS UNITS.



5701 SOUTH SANTA FE DRIVE LITTLETON, CO 80120



2000 AUBURN DR, SUITE 200 BEACHWOOD, OH 44122

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GCA	AMR	AB

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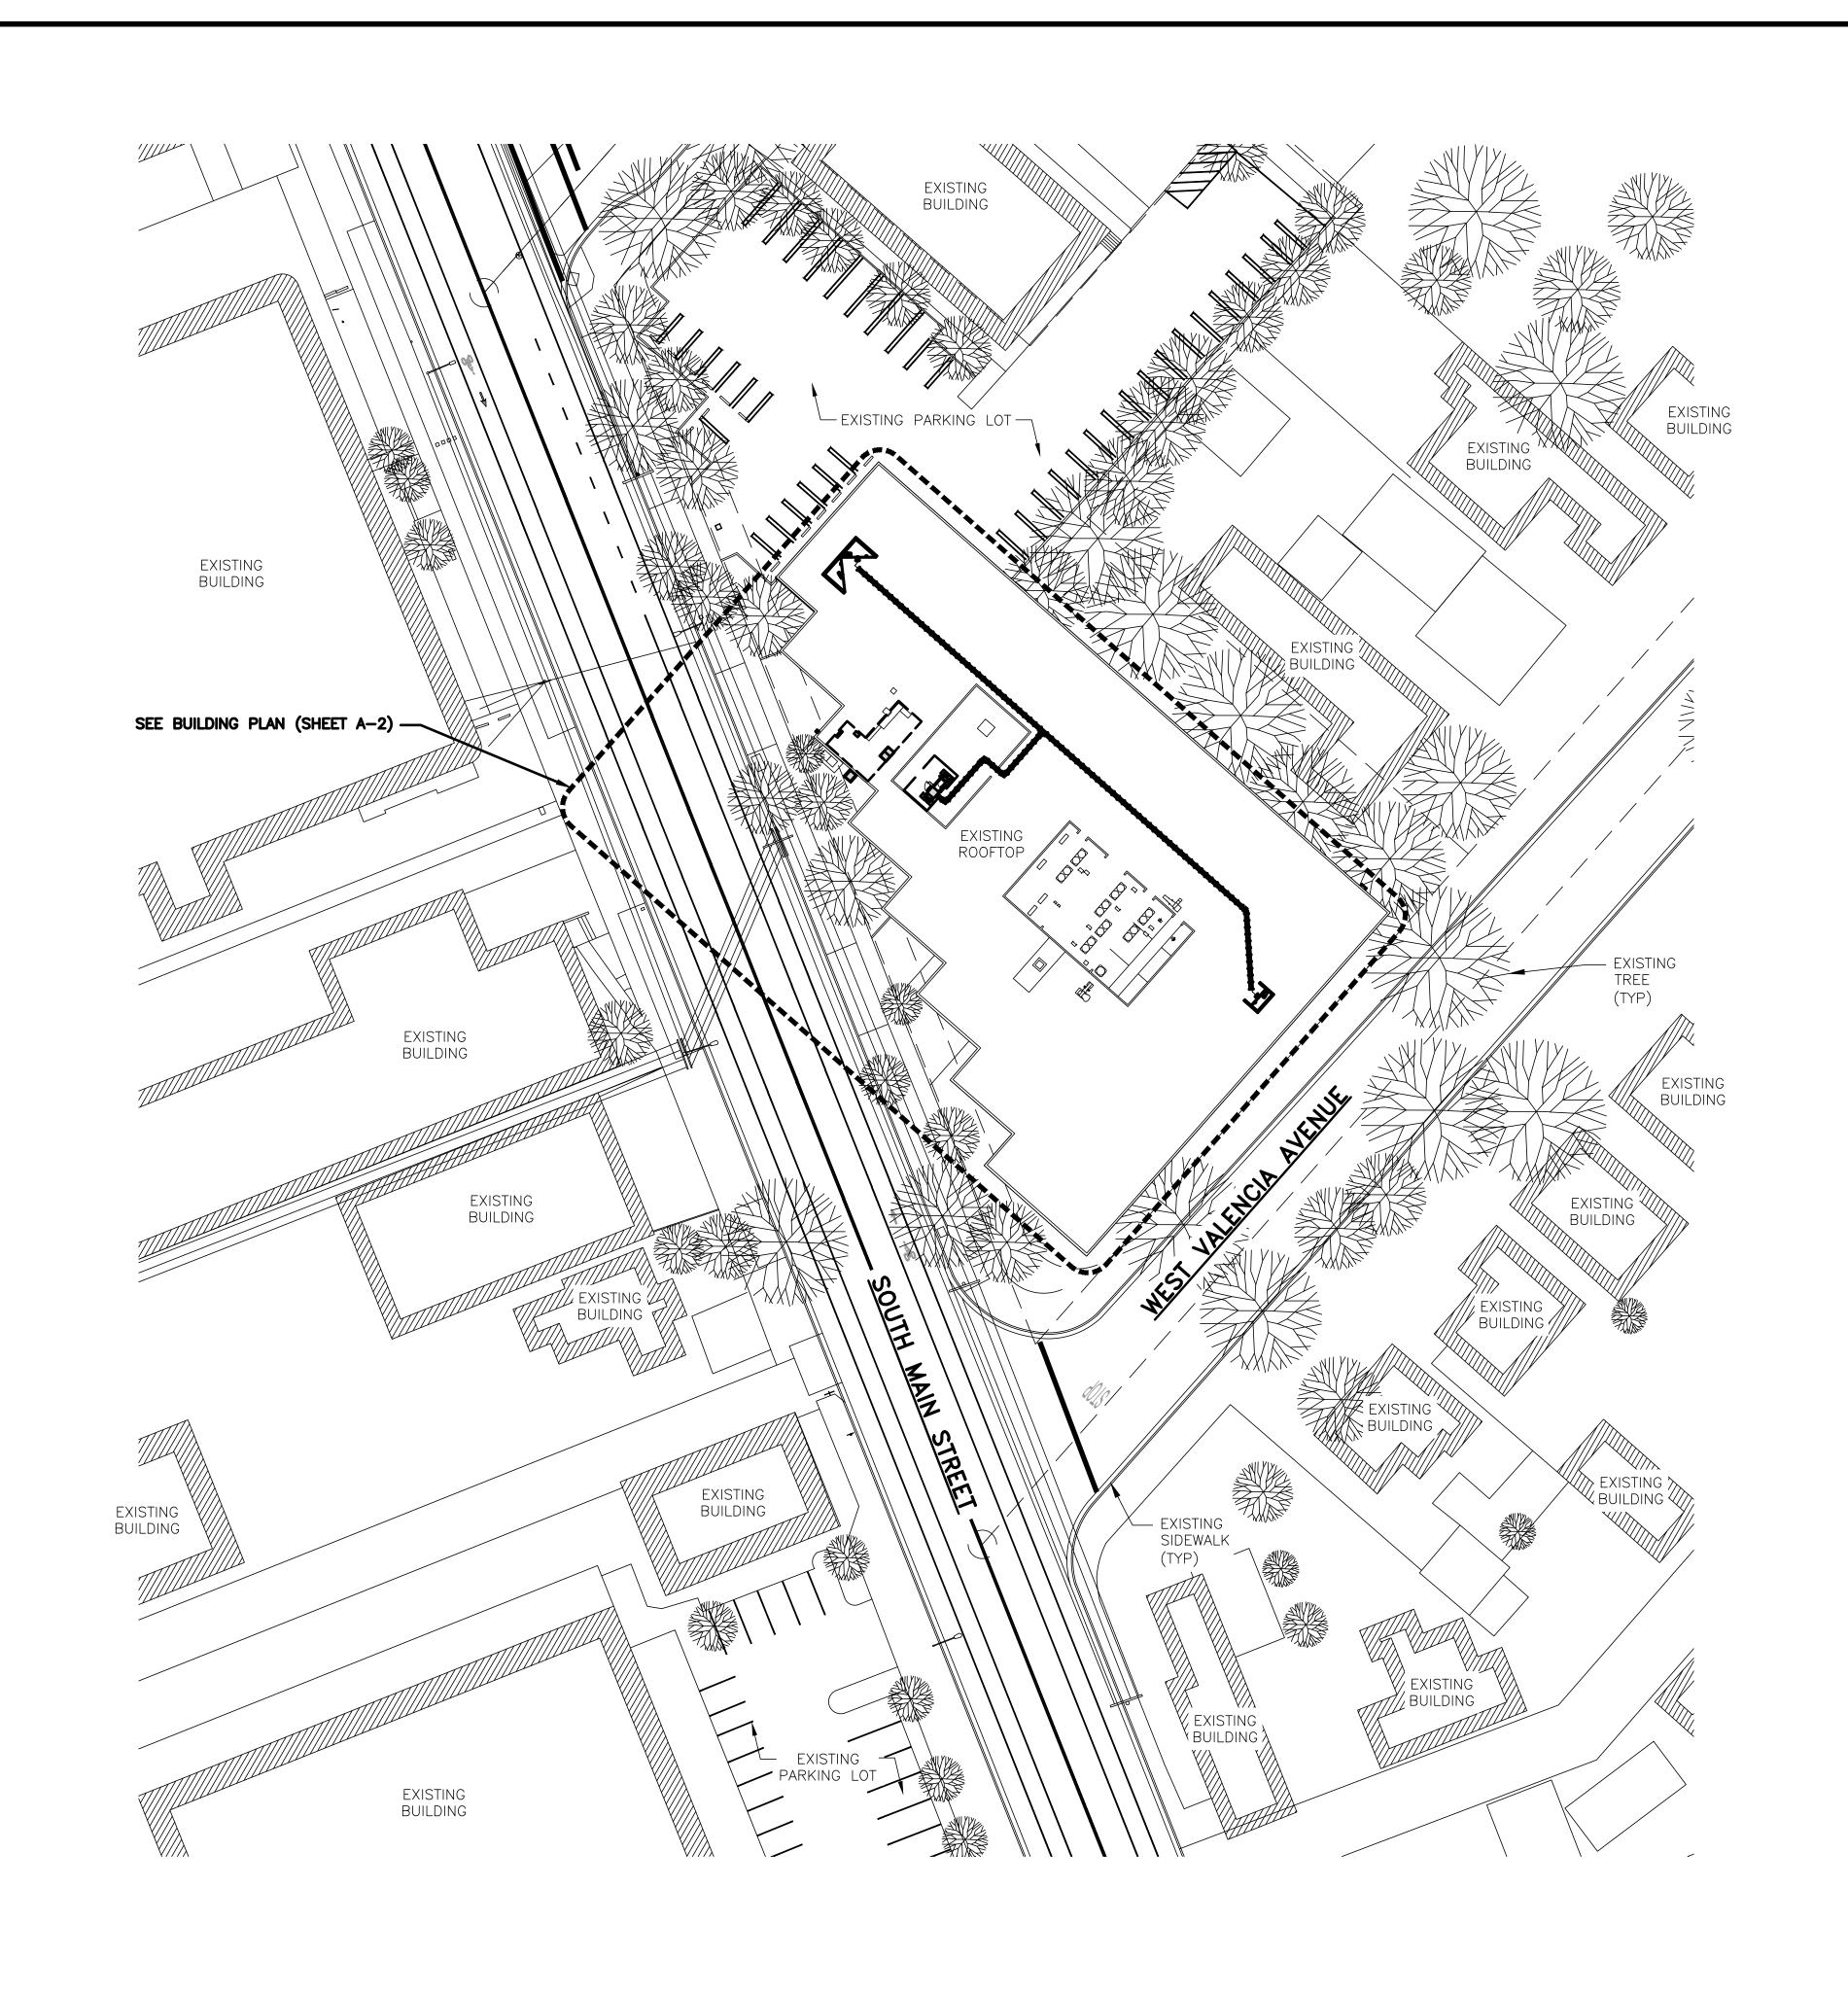
LALAXO4397B 800 SOUTH MAIN STREET BURBANK, CA 91506

SHEET TITLE
OVERALL
SITE PLAN

SHEET NUMBER

A-1

32' 24'16' 8' 0 32' 64' 1/32"=1'-0"



FRP ARCHITECTURAL AESTHETICS

PAINT TO MATCH UPPER BUILDING COLOR, ADDING HORIZONTAL TRIM STRIP TO MATCH. (THE BUILDING IS SALMON, GREEN AND CREAM. BY ADDING A GREEN OR SALMON TO THE TOP MIGHT REDUCE THE MASS OF THE FRP SCREENS)

NOTES

- CONTRACTOR SHALL FIELD VERIFY ALL DIMENSIONS.
- 2. CONTRACTOR SHALL MAINTAIN A 10'-0" MINIMUM SEPARATION BETWEEN THE PROPOSED GPS UNIT, TRANSMITTING ANTENNAS AND EXISTING GPS UNITS.
- 3. CONTRACTOR TO VERIFY WITH DISH Wireless L.L.C. C.M. THE LOCATION OF THE POWER AND FIBER SOURCE PRIOR TO CONSTRICTION.

3/32"=1'-0"

4. UTILITY RUBBER MAT TO BE INSTALLED UNDER ALL DISH Wireless L.L.C. EQUIPMENT THAT IS RESTING ON OR AFFIXED TO ROOF MEMBRANE.



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SUBMITTALS

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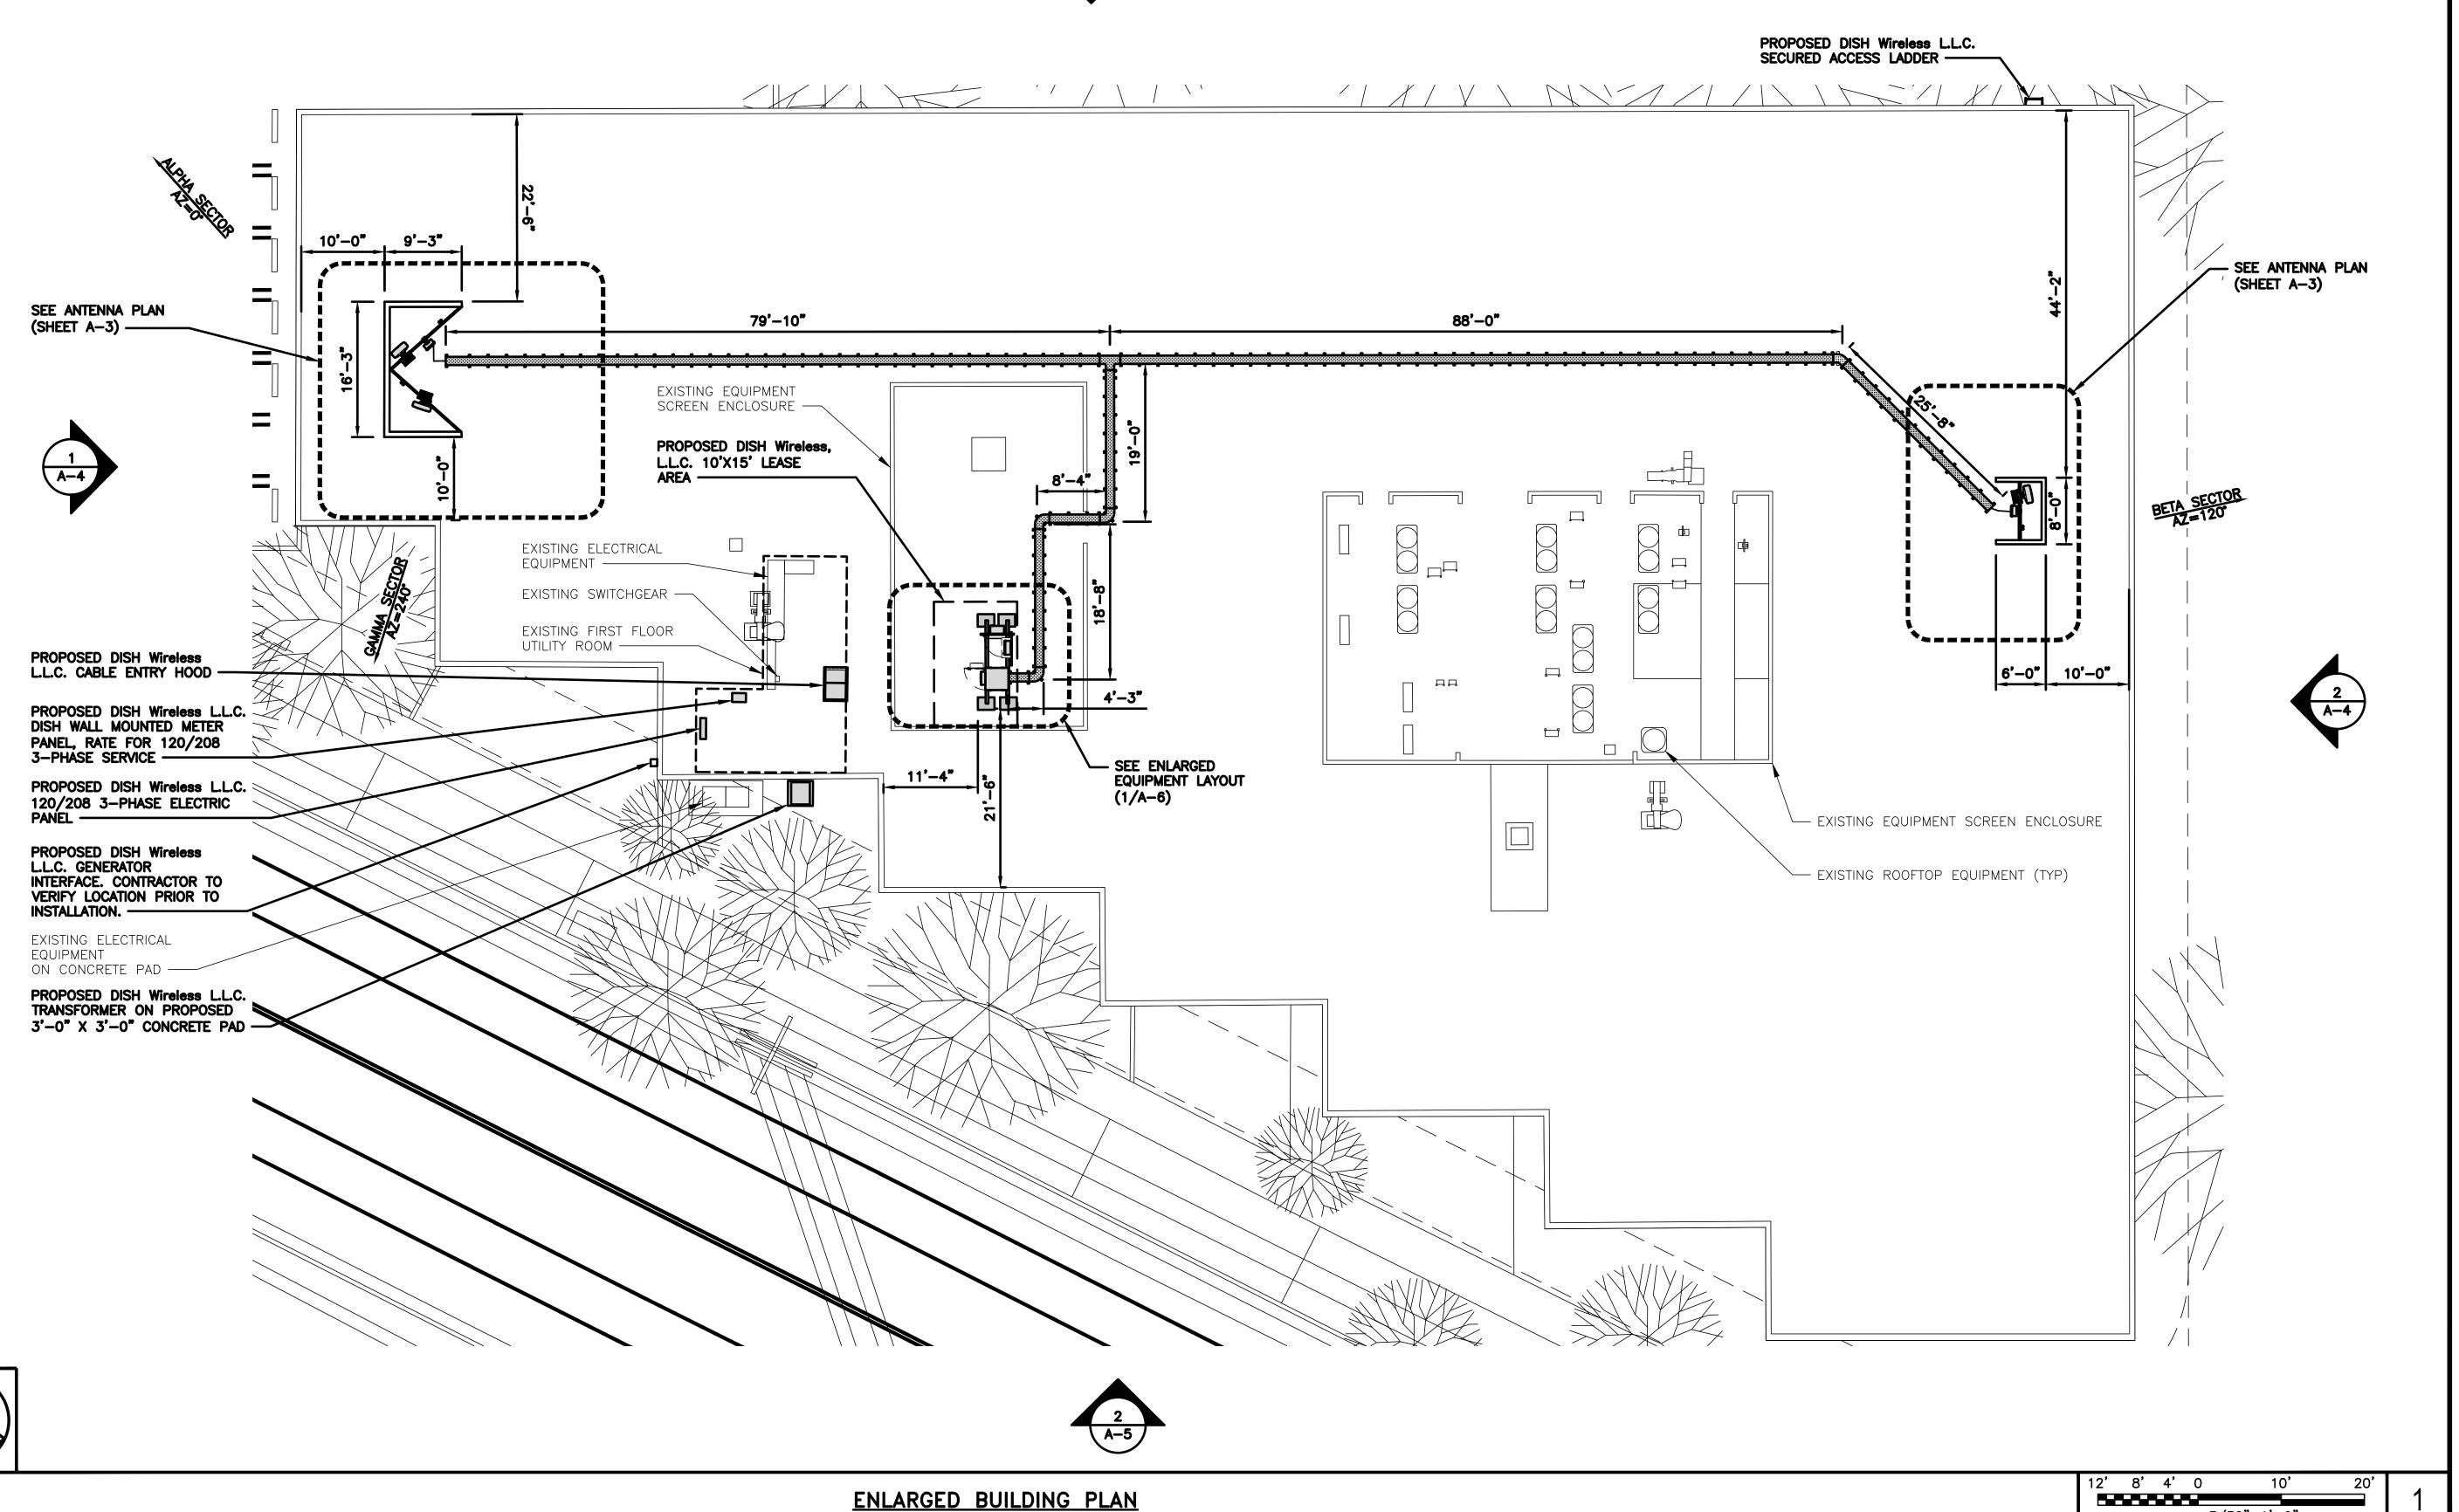
LALAX04397B 800 SOUTH MAIN STREET BURBANK, CA 91506

> SHEET TITLE ENLARGED BUILDING PLAN

> > SHEET NUMBER

A-2





		AN			INTENNA				TRANSMISSION CABLE
SECTOR POSITION		EXISTING OR PROPOSED	MANUFACTURE NUME		TECHNOLOGY	SIZE (HxW)	AZIMUTH	RAD CENTER	FEED LINE TYPE AND LENGTH
ALPHA	A 1	PROPOSED	CELLMAX (X12044x	5G	72.4"x26.7"x7.7"	O.	42'-0"	
BETA	B1	PROPOSED	CELLMAX (X12044x	5G	72.4"x26.7"x7.7"	120°	42'-0"	(2) HIGH—CAPACITY HYBRID CABLES
GAMMA	G1	PROPOSED	CELLMAX (X12044x	5G 72.4"x26.7"x7.7" 240° 42'-0"		THORID GADLES		
SECTOR	POSITION		RRU RER – MODEL MBER	BER IECHNOLOGY 1. CONTRACTOR		CTOR TO REFER TO FINAL CONSTRUCTION RFDS FOR ALI			
ALPHA	A 1		TA08025 B604 N70 N66TA08025 B605 N71		AVAILAE	NA AND RRU MODI BILITY. ALL EQUIPM	RRU MODELS MAY CHANGE DUE TO EQUALL EQUIPMENT CHANGES MUST BE APPROMPLIANCE WITH THE PROPOSED DESIGN		BE APPROVED AND
BETA	B1		- TA08025 B604 - TA08025 B605	N70 N66 N71	STRUCTURAL ANALYSES.		DESIGN AND		
CAMMA		(1) FUJITSU -	- TA08025 B604	N70 N66]				
GAMMA	G1	(1) FUJITSU -	- TA08025 B605	N71					


NOTES 1. CONTRACTOR SHALL FIELD VERIFY ALL DIMENSIONS. 2. ANTENNA AND MW DISH SPECIFICATIONS REFER TO ANTENNA SCHEDULE AND TO FINAL CONSTRUCTION RFDS FOR ALL RF DETAILS FRP ARCHITECTURAL AESTHETICS 1. PAINT TO MATCH UPPER BUILDING COLOR, ADDING HORIZONTAL TRIM STRIP TO MATCH. (THE BUILDING IS SALMON, GREEN AND CREAM. BY ADDING A GREEN OR SALMON TO THE TOP MIGHT REDUCE THE MASS OF THE FRP SCREENS) PROPOSED DISH Wireless L.L.C. HYBRID CABLE (1 AT ALPHA & GAMMA, 1 AT BETA SECTORS, TOTAL 2)

dish wireless.

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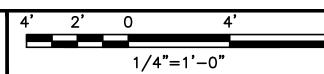


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ANTENNA SCHEDULE NO SCALE

ANTENNA PLAN - BETA SECTOR

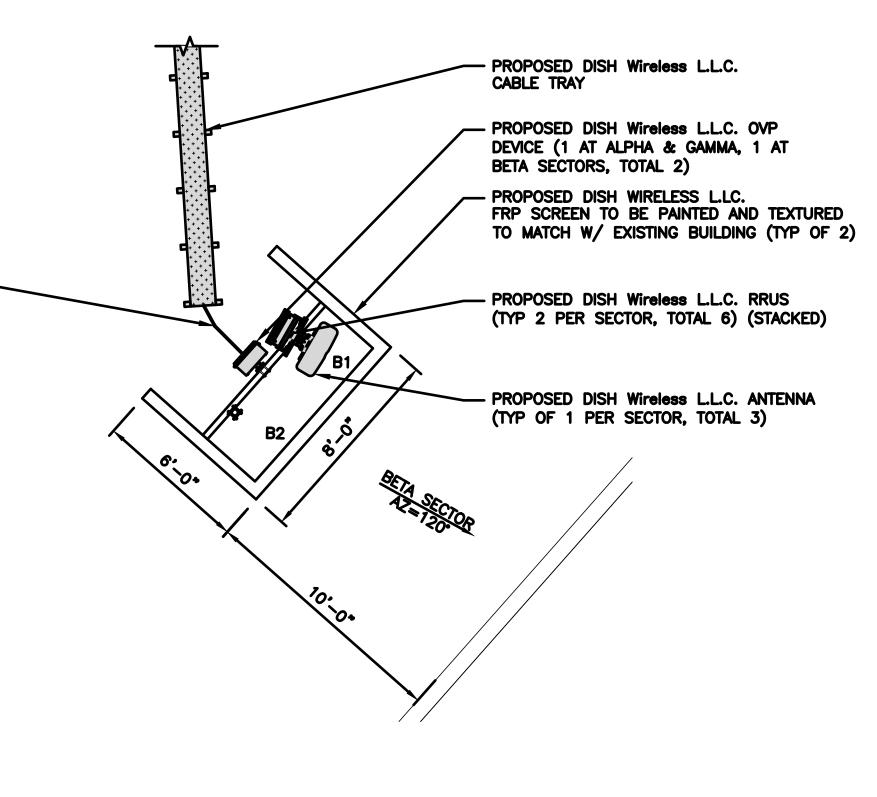

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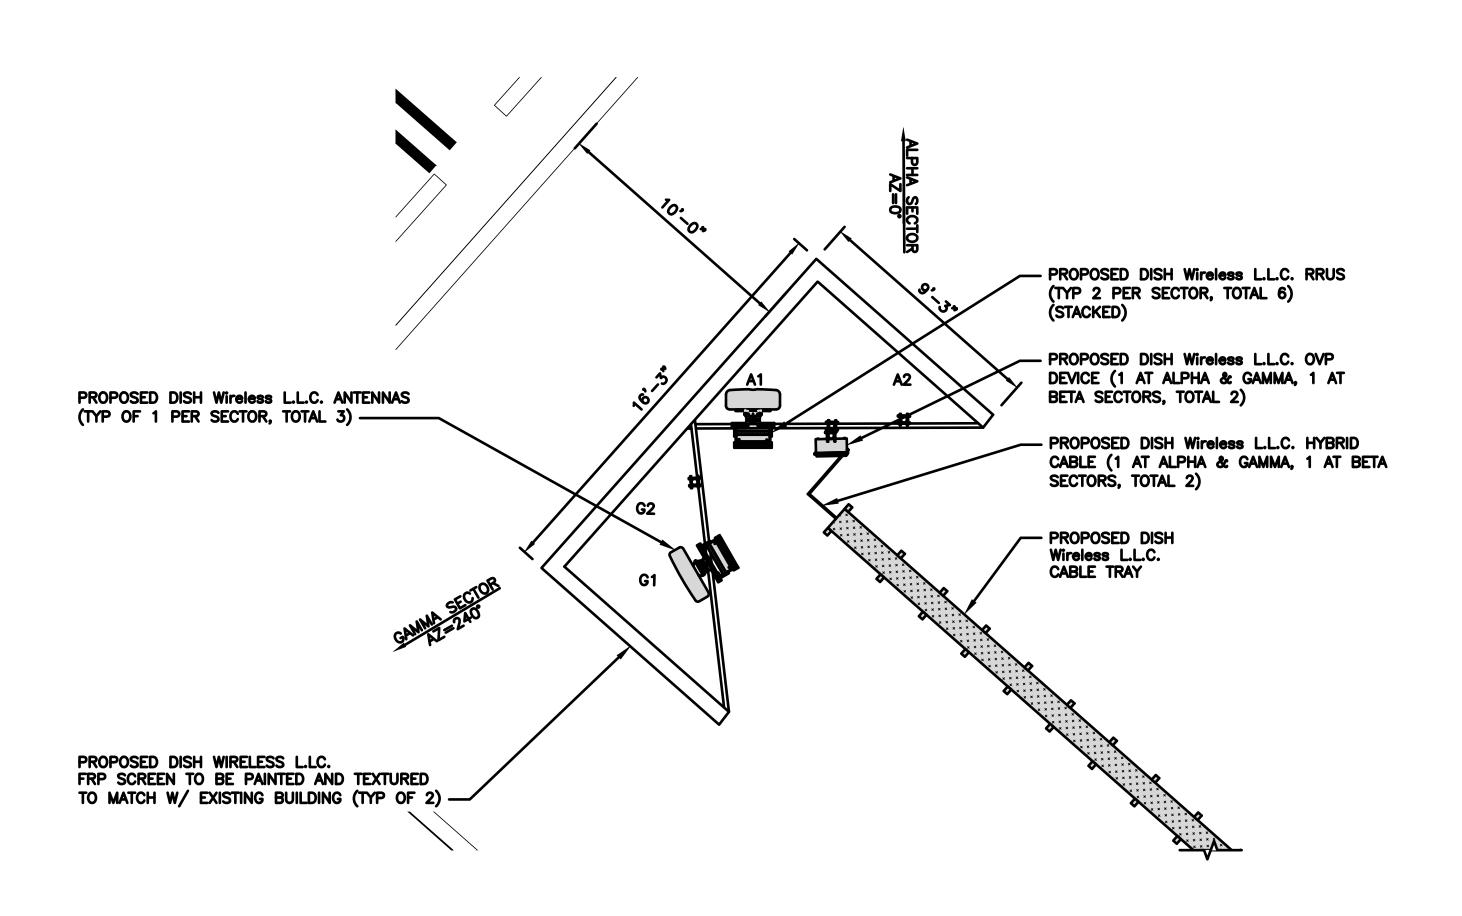
SHEET TITLE

ANTENNA PLAN,

ELEVATION AND SCHEDULE

SHEET NUMBER

A-3





ANTENNA PLAN - ALPHA & GAMMA SECTORS

1/4"=1'-0"

